

CLIENT:



NATIONAL HIGHWAYS AND INFRASTRUCTURE DEVELOPMENT CORPORATION LTD. (MINISTRY OF ROAD TRANSPORT AND HIGHWAYS) GOVERNMENT OF INDIA PROJECT :

CONSULTANCY SERVICES FOR PREPARATION OF DETAILED PROJECT REPORT FOR DEVELOPMENT OF ECONOMIC CORRIDORS, INTER CORRIDORS AND FEEDER ROUTES TO IMPROVE THE EFFICIENCY OF FREIGHT MOVEMENTS IN INDIA UNDER BHARATMALA PARIYOJANA (LOT-1:PACKAGE IV)

DESIGN CONSULTANT:

VOYANTS SOLUTIONS PVT LTD.

403, 4th Floor, Park Centra,
Sector-30, NH-8

403, 4th Floor, Park Centra,
Sector-30, NH-8
Gurugram-122001, Haryana, India
CIN- U74140HR2004PTC046918
Ph: 0124-4598200, Fax: 0124-4019051,
E-mail: info@voyants.in, www.voyants.in

REV. DATE

DESCRIPTION

Detaild Project Report	DESIGNED BY	DRAWN BY	CHECKED BY	APPROVED BY
	SLM	G. Das	MK	SKC
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SCALE:

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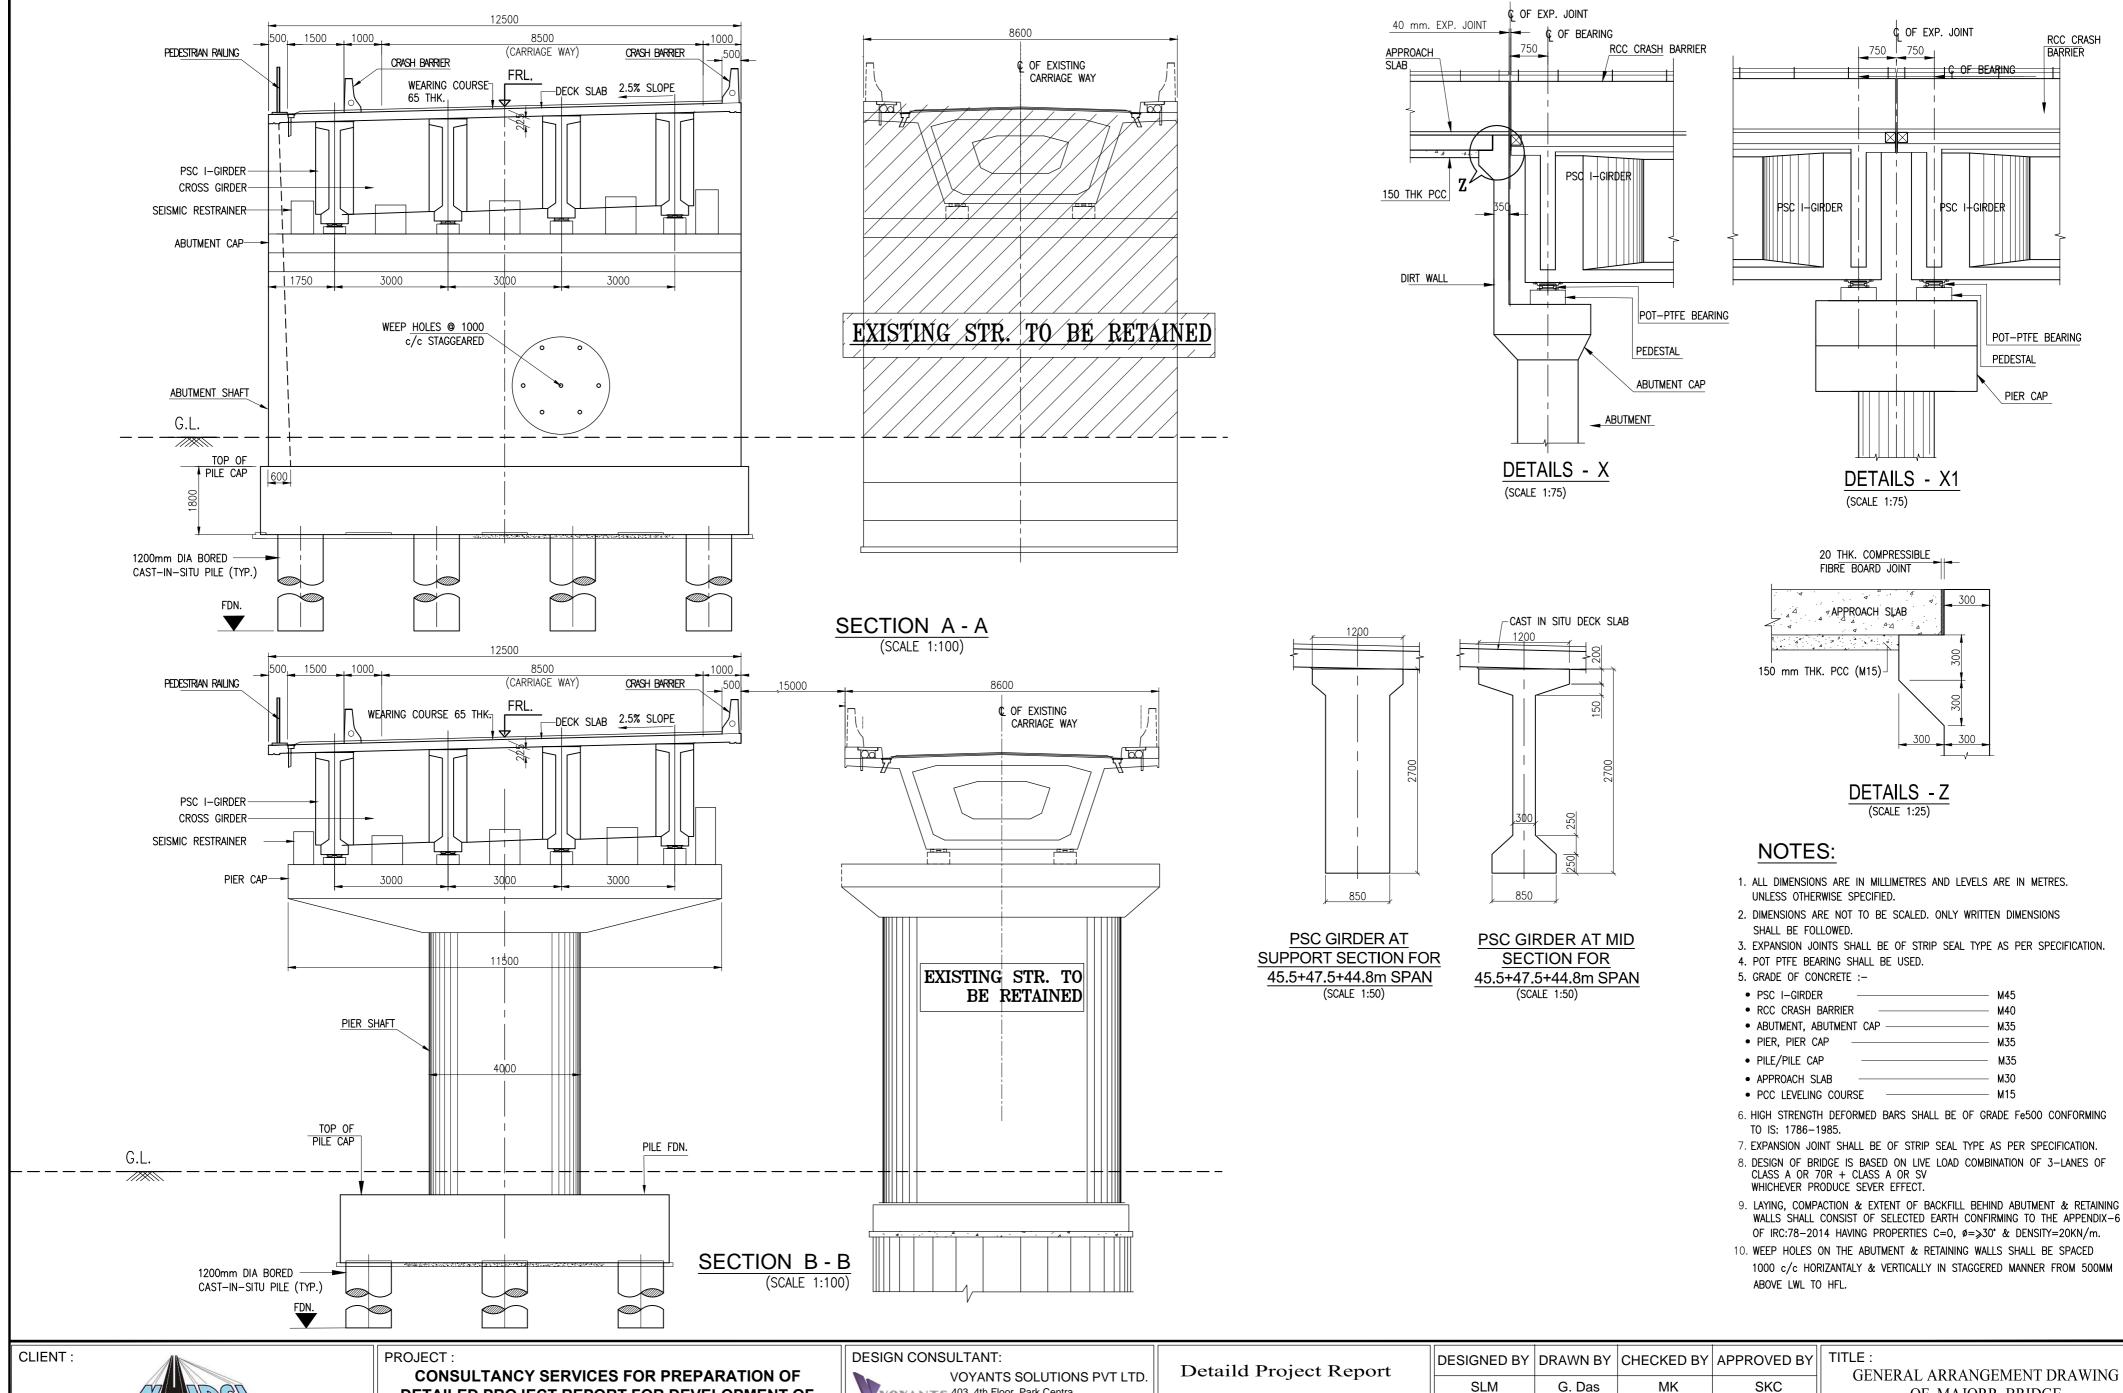
[©] OF EXP. JOINT

GENERAL ARRANGEMENT DRAWING OF MAJORR BRIDGE AT Km. Ch. 81+297.0 (RETAINED+NEW)

DRG. No. :

VSPL/1718-081/DPR/PKG-4/NH-515/SEC-3/MJB-03 (Sht. 1 of 2)

REVISION: R1 January, 2023



NATIONAL HIGHWAYS AND INFRASTRUCTURE **DEVELOPMENT CORPORATION LTD. (MINISTRY** OF ROAD TRANSPORT AND HIGHWAYS) **GOVERNMENT OF INDIA**

DETAILED PROJECT REPORT FOR DEVELOPMENT OF **ECONOMIC CORRIDORS, INTER CORRIDORS AND FEEDER ROUTES TO IMPROVE THE EFFICIENCY OF FREIGHT MOVEMENTS IN INDIA UNDER BHARATMALA PARIYOJANA** (LOT-1:PACKAGE IV)

VOYANTS 403, 4th Floor, Park Cen Sector-30, NH-8 Gurugram-122001, Hary CIN- U74140HR2004PT Ph: 0124-4598200, Fax: E-mail: info@voyants.in.

TIONS PVT LTD.	D
yana, India FC046918 : 0124-4019051, , www.voyants.in	

Detaild Project Report	DESIGNED BY	DRAWN BY	CHECKED BY	AF
	SLM	G. Das	MK	
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REV. DATE DESCRIPTION	SCALE:	AS SHOWN	SHEET SIZE	


GENERAL ARRANGEMENT DRAWING OF MAJORR BRIDGE AT Km. Ch. 81+297.0 (RETAINED+NEW)

RCC CRASH


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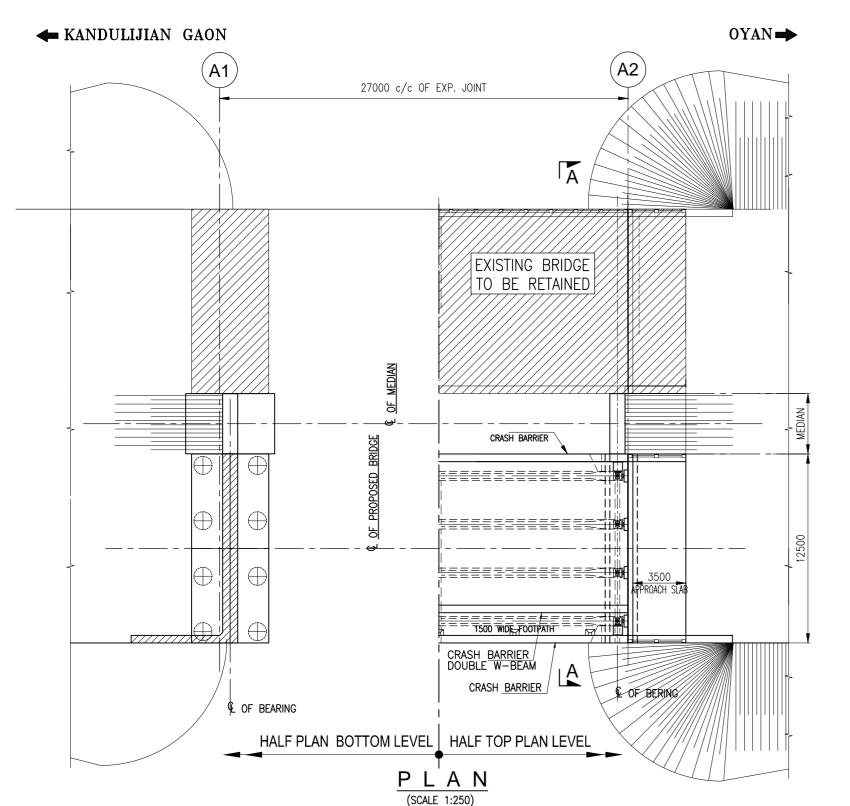
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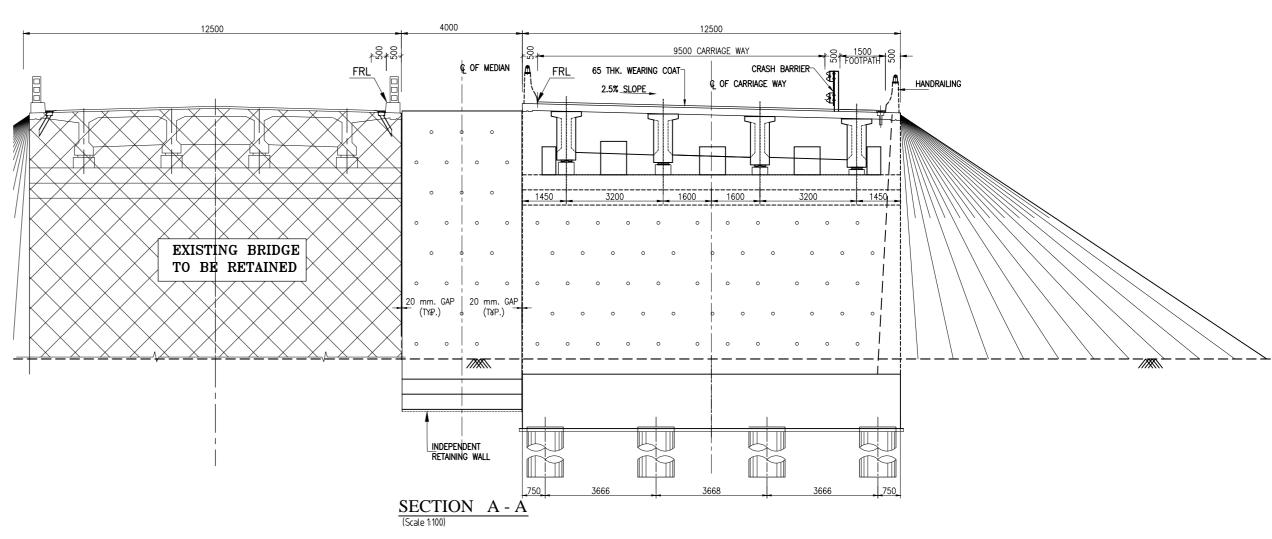
VSPL/1718-081/DPR/PKG-4/NH-515/SEC-3/MJB-03 (Sht. 2 of 2) **REVISION:** January, 2023





NATIONAL HIGHWAYS AND INFRASTRUCTURE CIN- U74140HR2004PTC046918 **ROUTES TO IMPROVE THE EFFICIENCY OF FREIGHT** DRG. No. : Ph: 0124-4598200, Fax: 0124-4019051, **DEVELOPMENT CORPORATION LTD. (MINISTRY MOVEMENTS IN INDIA UNDER BHARATMALA PARIYOJANA** E-mail: info@voyants.in, www.voyants.in VSPL/1718-081/DPR/PKG-4/NH-515/SEC-3/MNB-01 (Sht. 1 of OF ROAD TRANSPORT AND HIGHWAYS) SHEET SIZE SCALE AS SHOWN A2 (LOT-1:PACKAGE IV) **GOVERNMENT OF INDIA REVISION:** January, 2023 REV. DATE **DESCRIPTION**

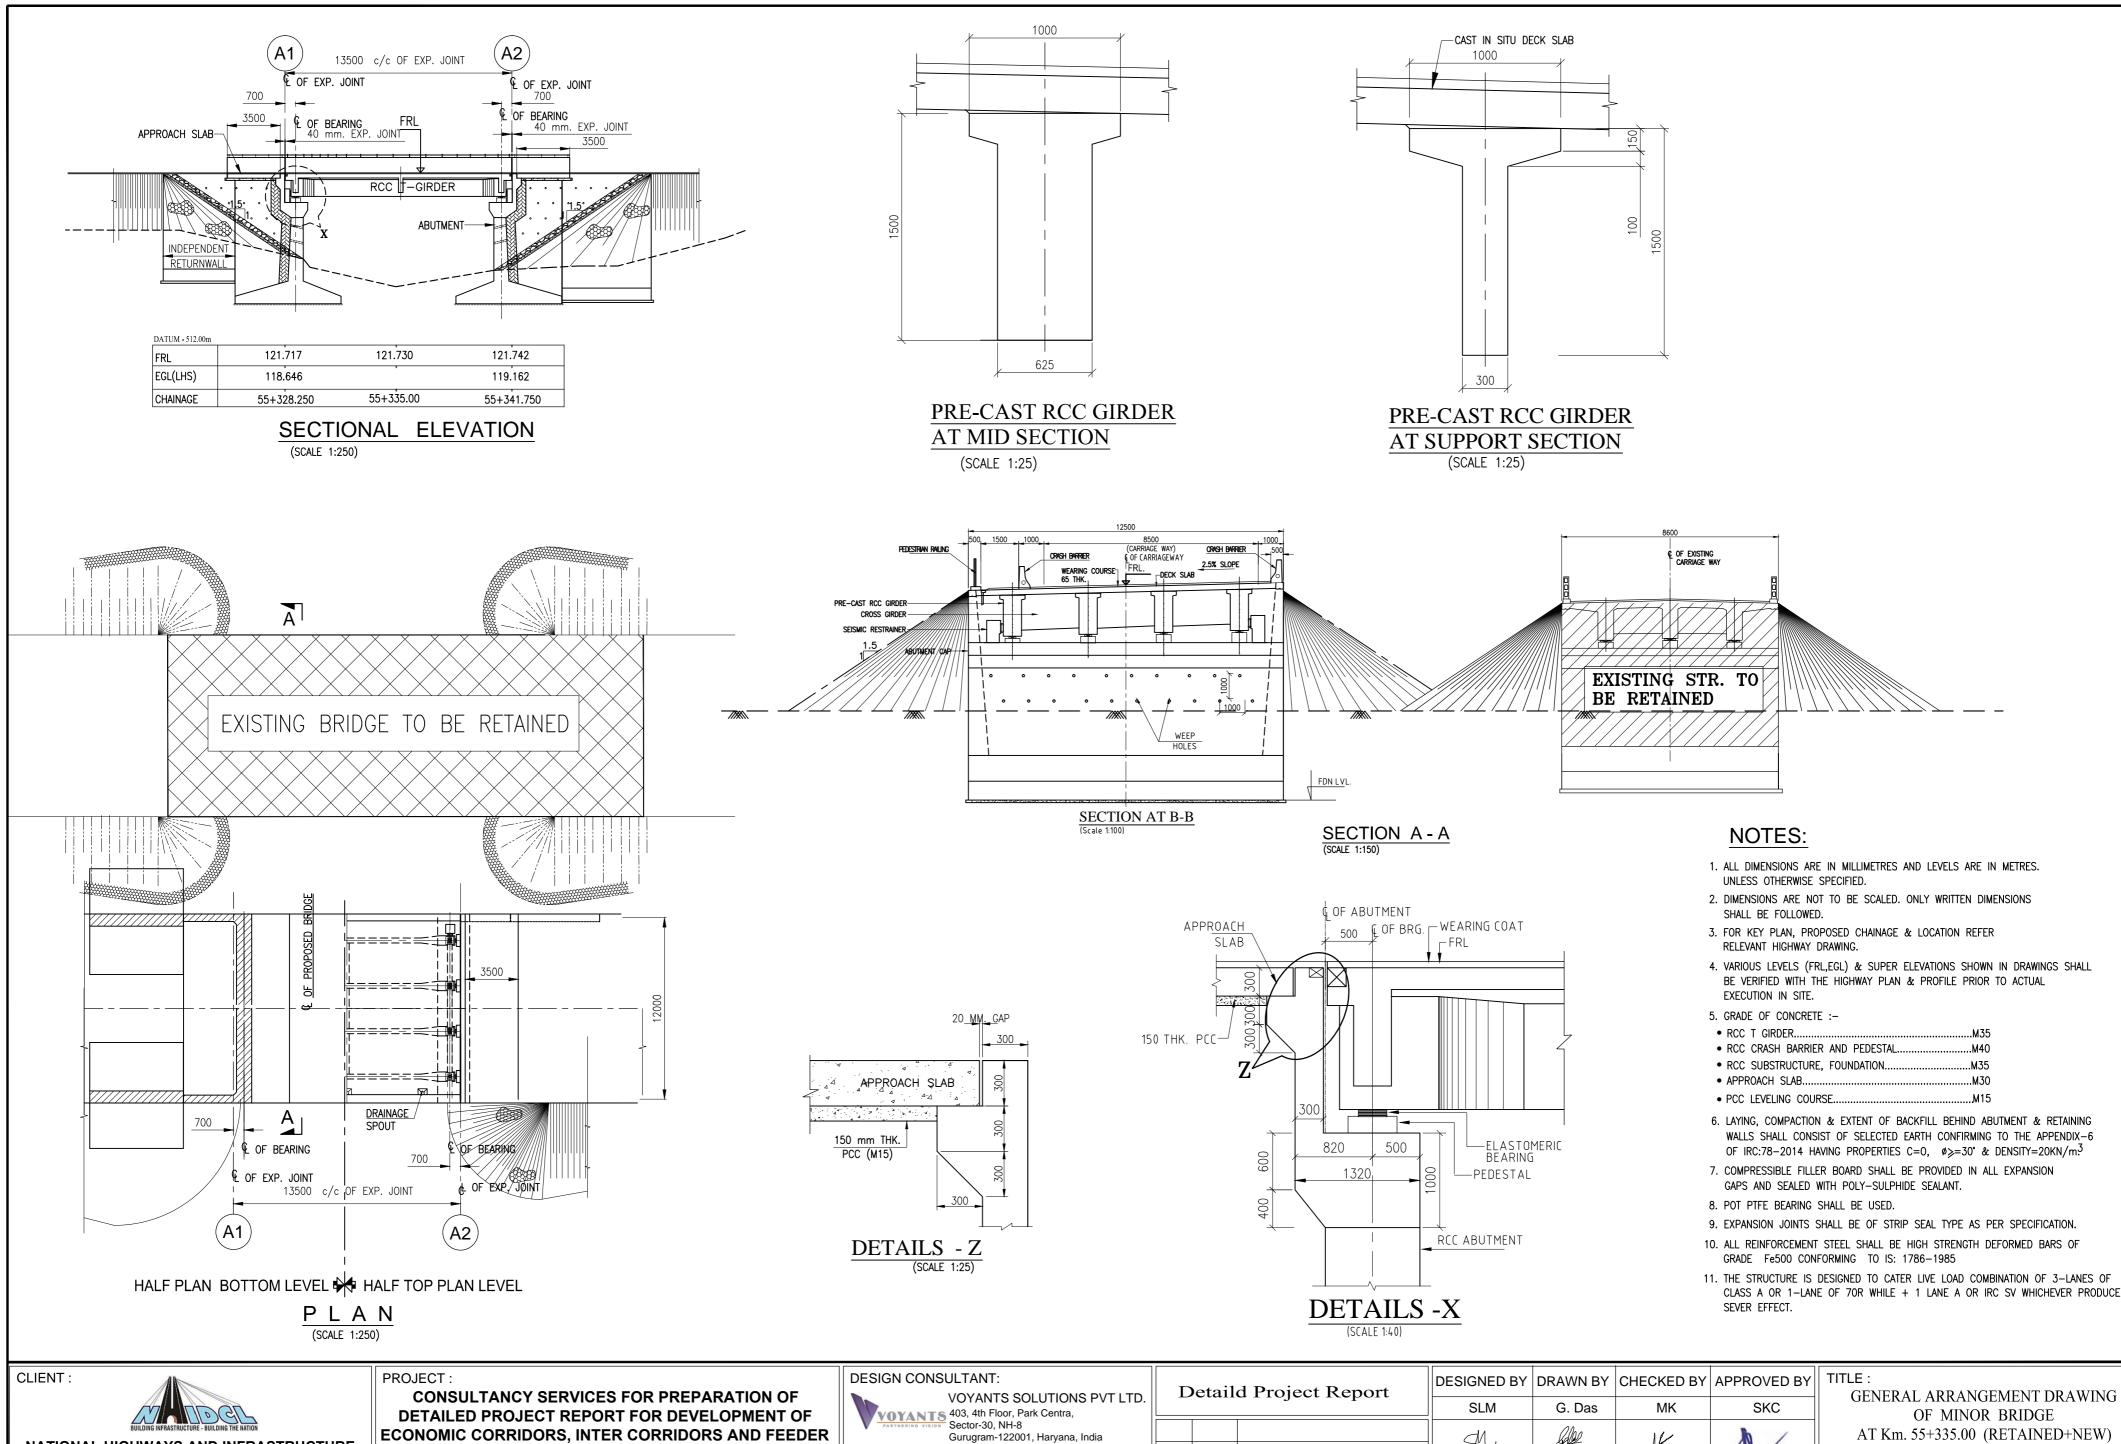



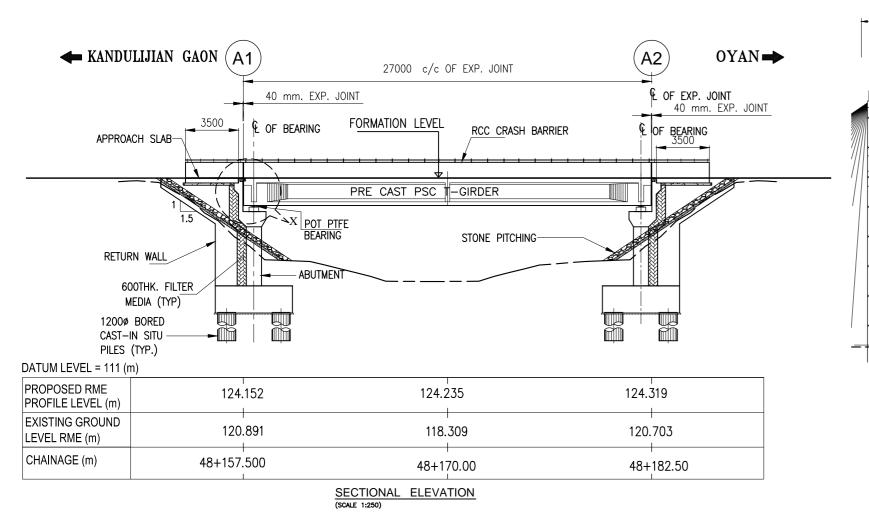

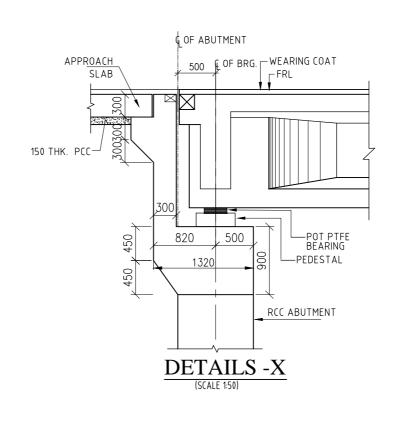

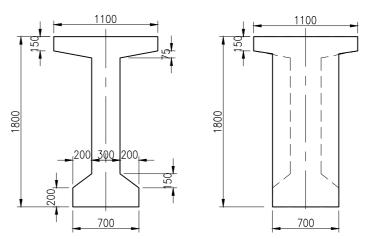

SECTION AT MID SECTION AT END DETAILS FOR PRECAST RCC T-GIRDER (22.0m SPAN)

NOTES:

- 1. ALL DIMENSIONS ARE IN MILLIMETRES AND LEVELS ARE IN METRES. UNLESS OTHERWISE SPECIFIED.
- 2. DIMENSIONS ARE NOT TO BE SCALED. ONLY WRITTEN DIMENSIONS SHALL BE FOLLOWED.
- 3. EXPANSION JOINTS SHALL BE OF STRIP SEAL TYPE AS PER SPECIFICATION.
- 4. POT PTFE BEARING SHALL BE USED.
- 5. GRADE OF CONCRETE :

3. GRADE OF CONCRETE :-	
RCC PRE CAST T-GIRDER	— м 35
RCC DECK SLAB	— M35
RCC CRASH BARRIER	— M40
ABUTMENT, ABUTMENT CAP	— М35
APPROACH SLAB	— м 35
PCC LEVELING COURSE	— M15
PILE, PILE CAP	— м35

CLIENT:



NATIONAL HIGHWAYS AND INFRASTRUCTURE **DEVELOPMENT CORPORATION LTD. (MINISTRY** OF ROAD TRANSPORT AND HIGHWAYS) **GOVERNMENT OF INDIA**

PROJECT: **CONSULTANCY SERVICES FOR PREPARATION OF**

DETAILED PROJECT REPORT FOR DEVELOPMENT OF **ECONOMIC CORRIDORS, INTER CORRIDORS AND FEEDER** ROUTES TO IMPROVE THE EFFICIENCY OF FREIGHT MOVEMENTS IN INDIA UNDER BHARATMALA PARIYOJANA (LOT-1:PACKAGE IV)


DESIGN CONSULTANT: **VOYANTS SOLUTION** VOYANTS 403, 4th Floor, Park Central Sector-30, NH-8 Gurugram-122001, Haryana CIN- U74140HR2004PTC0 Ph: 0124-4598200, Fax: 012


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VOYANTS SOLUTIONS PVT LTD.		eta
403, 4th Floor, Park Centra,		
Sector-30, NH-8		
Gurugram-122001, Haryana, India		
CIN- U74140HR2004PTC046918		
Ph: 0124-4598200, Fax: 0124-4019051,		
E-mail: info@voyants.in, www.voyants.in		
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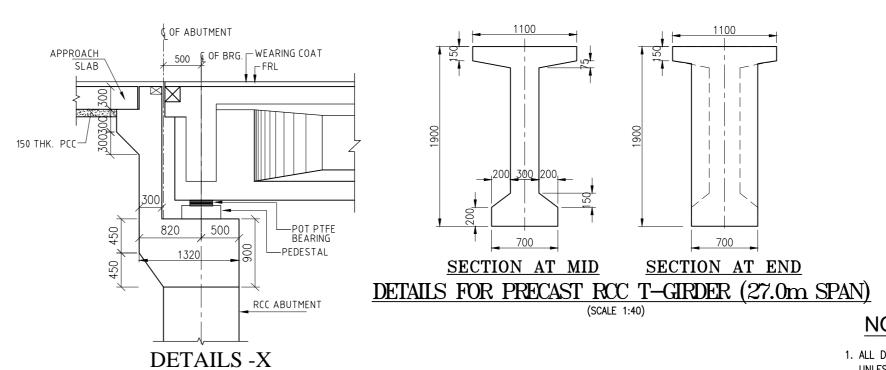
TITLE: GENERAL ARRANGEMENT DRAWING OF MINOR BRIDGE AT Km. 56+744.000 (RETAINED+NEW)

VSPL/1718-081/DPR/PKG-4/NH-515/SEC-3/MNB-02. (Sht. 1 of 1 REVISION: January, 2023



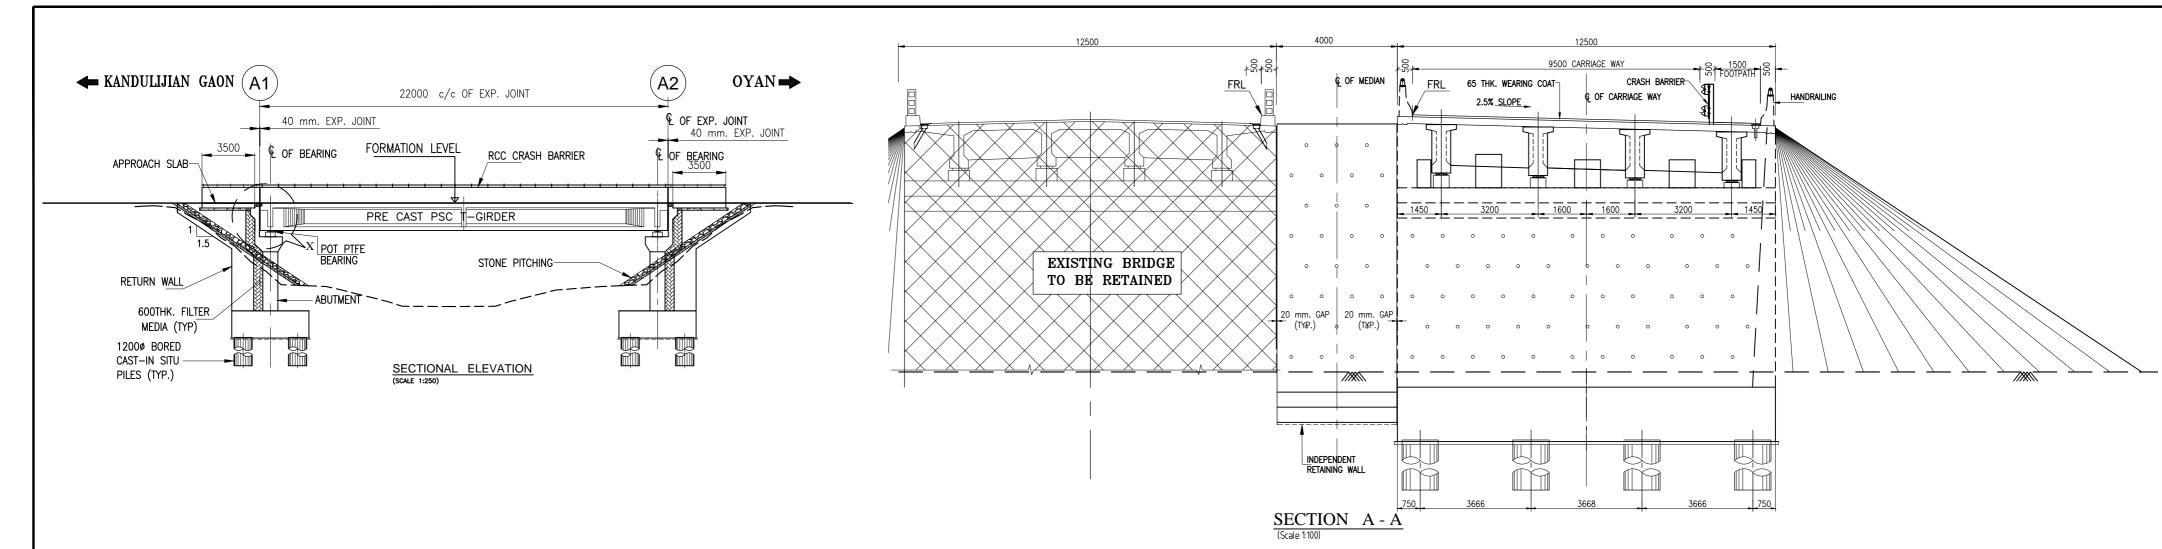

	Chainage (KM)				Proposal			Proposal				OGL		FRL					
SI. No	Existing (km)	Design (km)	Category of Structure	Type of Superstructure	Span Arrangement (m)		Total Width (m)	Remarks	Improvement Proposal	Span Arrangement (m)	Total Length (m)	Total Width (m)	Type of Superstructure	A1	CENTER	A2	A1	CENTER	A2
1	61+400	58+215	MNB	RCC I Girder	2 x 10.9	21.8	8.8	Existing Retain	New 2Lane on RHS	1 x 22	22	12.5	RCC I Girder	119.978	118.992	120.889	123.443	123.44	123.44
2	62+100	58+910	MNB	RCC I Girder	2 x 9	18	8.8	Existing Retain	New 2Lane on RHS	1 x 22	22	12.5	RCC I Girder	120.162	118.311	120.041	122.603	122.6	122.59

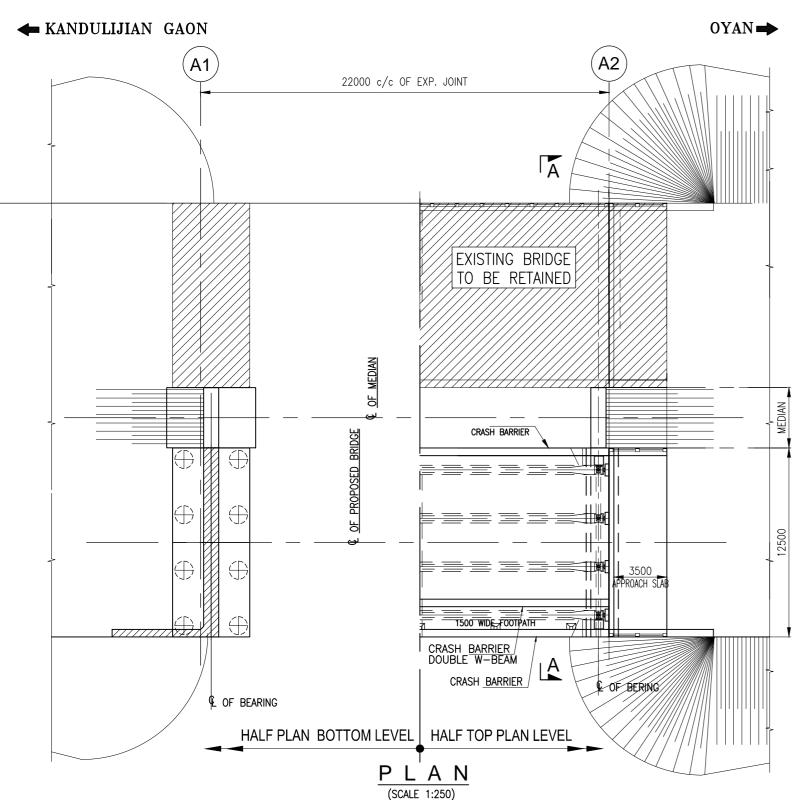

NOTES:

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- 3. EXPANSION JOINTS SHALL BE OF STRIP SEAL TYPE AS PER SPECIFICATION.
- 4. POT PTFE BEARING SHALL BE USED.
- 5 CDADE OF CONCRETE ...

A2

5. GRADE OF CONCRETE :-	
RCC PRE CAST T-GIRDER	M35
RCC DECK SLAB	M35
RCC CRASH BARRIER	M40
ABUTMENT, ABUTMENT CAP	M35
APPROACH SLAB	M35
PCC LEVELING COURSE	M15
PILE, PILE CAP	M35

CLIENT :



NATIONAL HIGHWAYS AND INFRASTRUCTURE DEVELOPMENT CORPORATION LTD. (MINISTRY OF ROAD TRANSPORT AND HIGHWAYS) GOVERNMENT OF INDIA PROJECT :

CONSULTANCY SERVICES FOR PREPARATION OF DETAILED PROJECT REPORT FOR DEVELOPMENT OF ECONOMIC CORRIDORS, INTER CORRIDORS AND FEEDER ROUTES TO IMPROVE THE EFFICIENCY OF FREIGHT MOVEMENTS IN INDIA UNDER BHARATMALA PARIYOJANA (LOT-1:PACKAGE IV) DESIGN CONSULTANT:

VOYANTS SOLUTIONS PVT LTD.

403, 4th Floor, Park Centra,
Sector-30, NH-8
Gurugram-122001, Haryana, India
CIN- U74140HR2004PTC046918
Ph: 0124-4598200, Fax: 0124-4019051,
E-mail: info@voyants.in, www.voyants.in

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DESCRIPTION


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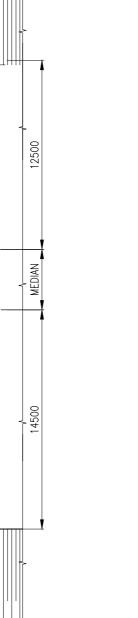
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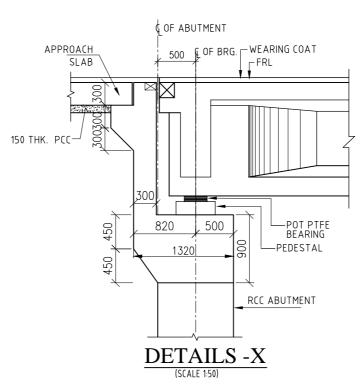
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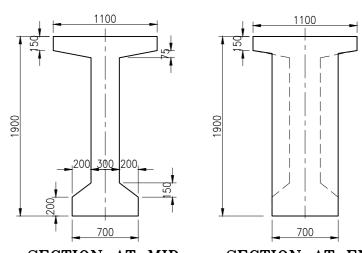
TITLE:
GENERAL ARRANGEMENT DRAWING
OF MINOR BRIDGE AT Ch. 58+215.0 &
AT Ch. 58.910.0 (RETAINED+NEW)

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	DRG. No. :							
	VSPL/1718-081/DPR/PKG-4/NH-515/SEC-3/MNB-03.							
	REVISION:	R1	January 2023					







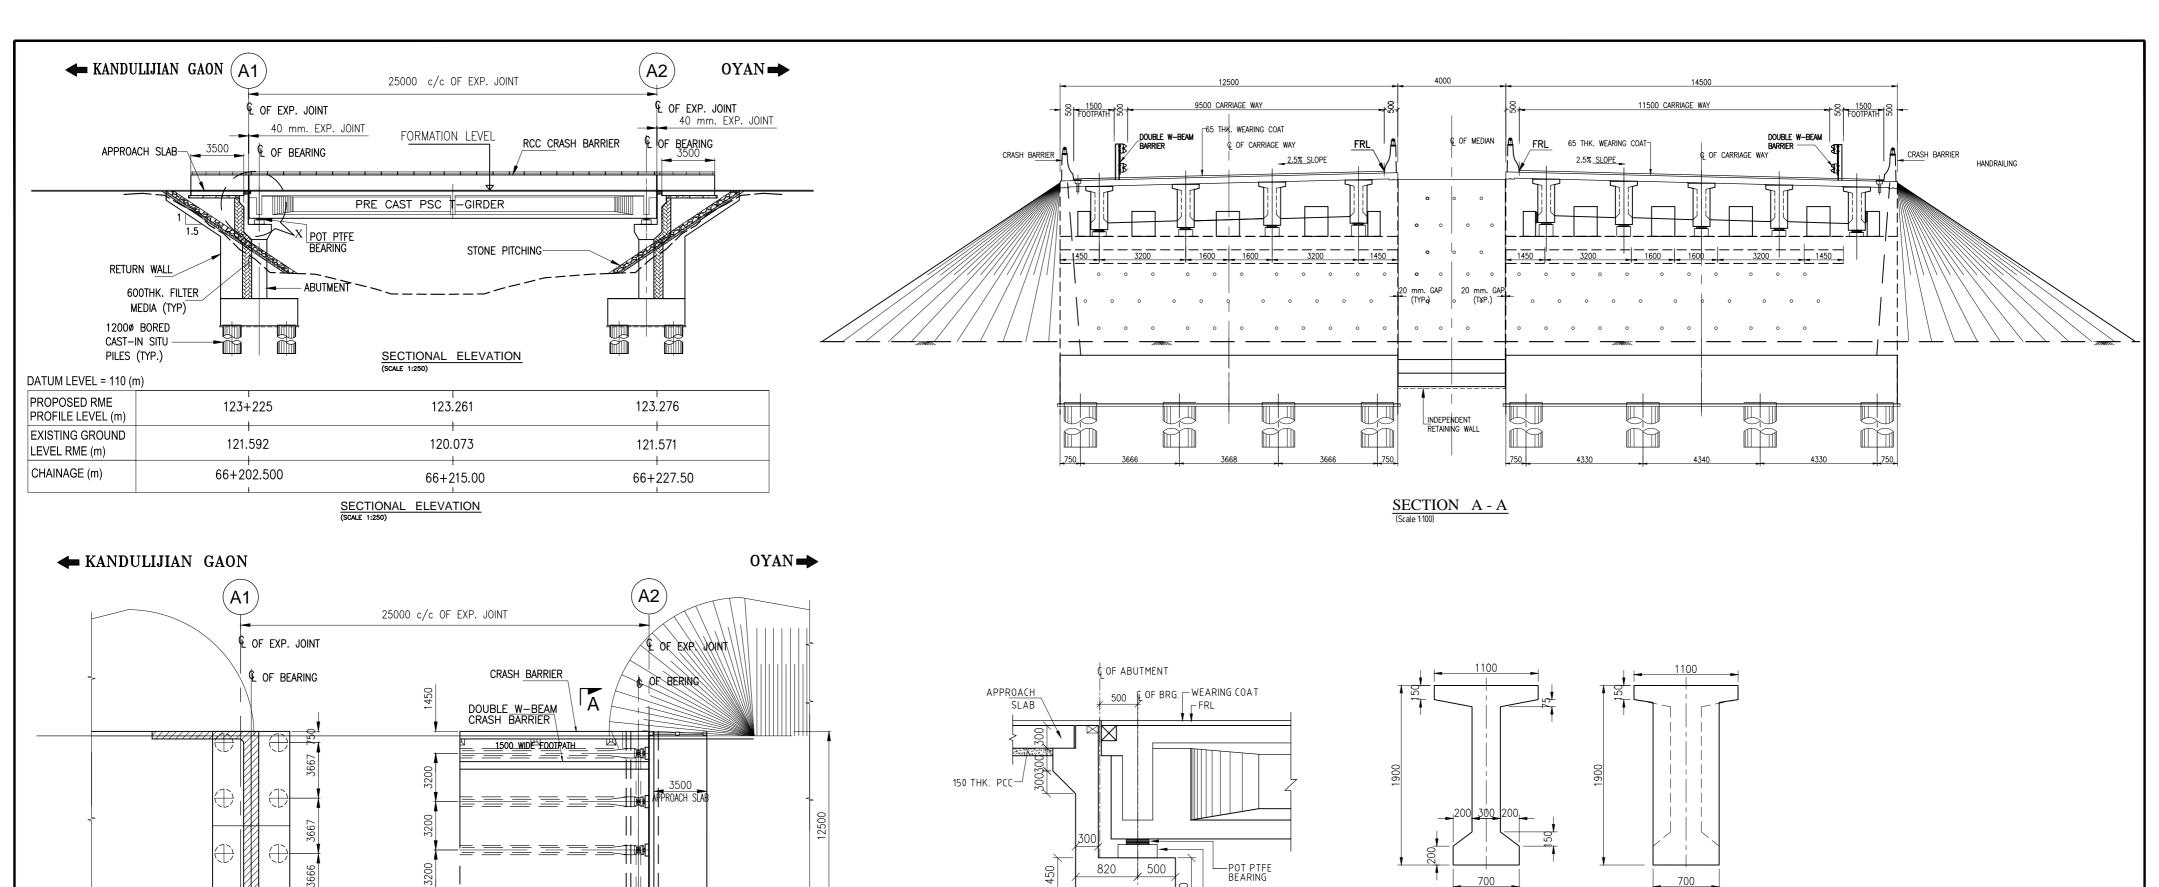

SECTION AT MID SECTION AT END DETAILS FOR PRECAST RCC T-GIRDER (27.0m SPAN) (SCALE 1:40)

NOTES:

- 1. ALL DIMENSIONS ARE IN MILLIMETRES AND LEVELS ARE IN METRES. UNLESS OTHERWISE SPECIFIED.
- 2. DIMENSIONS ARE NOT TO BE SCALED. ONLY WRITTEN DIMENSIONS SHALL BE FOLLOWED.
- 3. EXPANSION JOINTS SHALL BE OF STRIP SEAL TYPE AS PER SPECIFICATION.
- 4. POT PTFE BEARING SHALL BE USED.
- 5 CDADE OF CONCRETE

5. GRADE OF CONCRETE :-	
RCC PRE CAST T-GIRDER ———————————————————————————————————	M35
RCC DECK SLAB	M35
RCC CRASH BARRIER	M40
ABUTMENT, ABUTMENT CAP	M35
APPROACH SLAB	M35
PCC LEVELING COURSE	M15
PILE, PILE CAP	M35

CLIENT:



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NATIONAL HIGHWAYS AND INFRASTRUCTURE **DEVELOPMENT CORPORATION LTD. (MINISTRY** OF ROAD TRANSPORT AND HIGHWAYS) **GOVERNMENT OF INDIA**

PROJECT:

HALF PLAN BOTTOM LEVEL | HALF TOP PLAN LEVEL

PLAN (SCALE 1:250)

CONSULTANCY SERVICES FOR PREPARATION OF DETAILED PROJECT REPORT FOR DEVELOPMENT OF **ECONOMIC CORRIDORS, INTER CORRIDORS AND FEEDER ROUTES TO IMPROVE THE EFFICIENCY OF FREIGHT** MOVEMENTS IN INDIA UNDER BHARATMALA PARIYOJANA (LOT-1:PACKAGE IV)

OF BERING

& OF EXP JOHNY

CRASH BARRIER

1500 WIDE FOOTPATH

CRASH BARRIER DOUBLE W-BEAM


CRASH BARRIER


DESIGN CONSULTANT: VOYANTS SOLUTIONS PVT LTD. VOYANTS 403, 4th Floor, Park Centra, Sector-30, NH-8 Gurugram-122001, Haryana, India CIN- U74140HR2004PTC046918 Ph: 0124-4598200, Fax: 0124-4019051, E-mail: info@voyants.in, www.voyants.in


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	REV. DATE DESCRIPTION	SCALE:	AS SHOWN	SHEET SIZE	A2

SΥ	TITLE:
_	GENERAL ARRANGEMENT DRAWING
_	OF MINOR BRIDGE
	AT Ch. 66+215.0 (NEW)
	DDC 11

	DRG. No.:							
VSPL/1718-081/DPR/PKG-4/NH-515/SEC-3/MNB-04. (\$								
	REVISION:	R1	January, 2023					

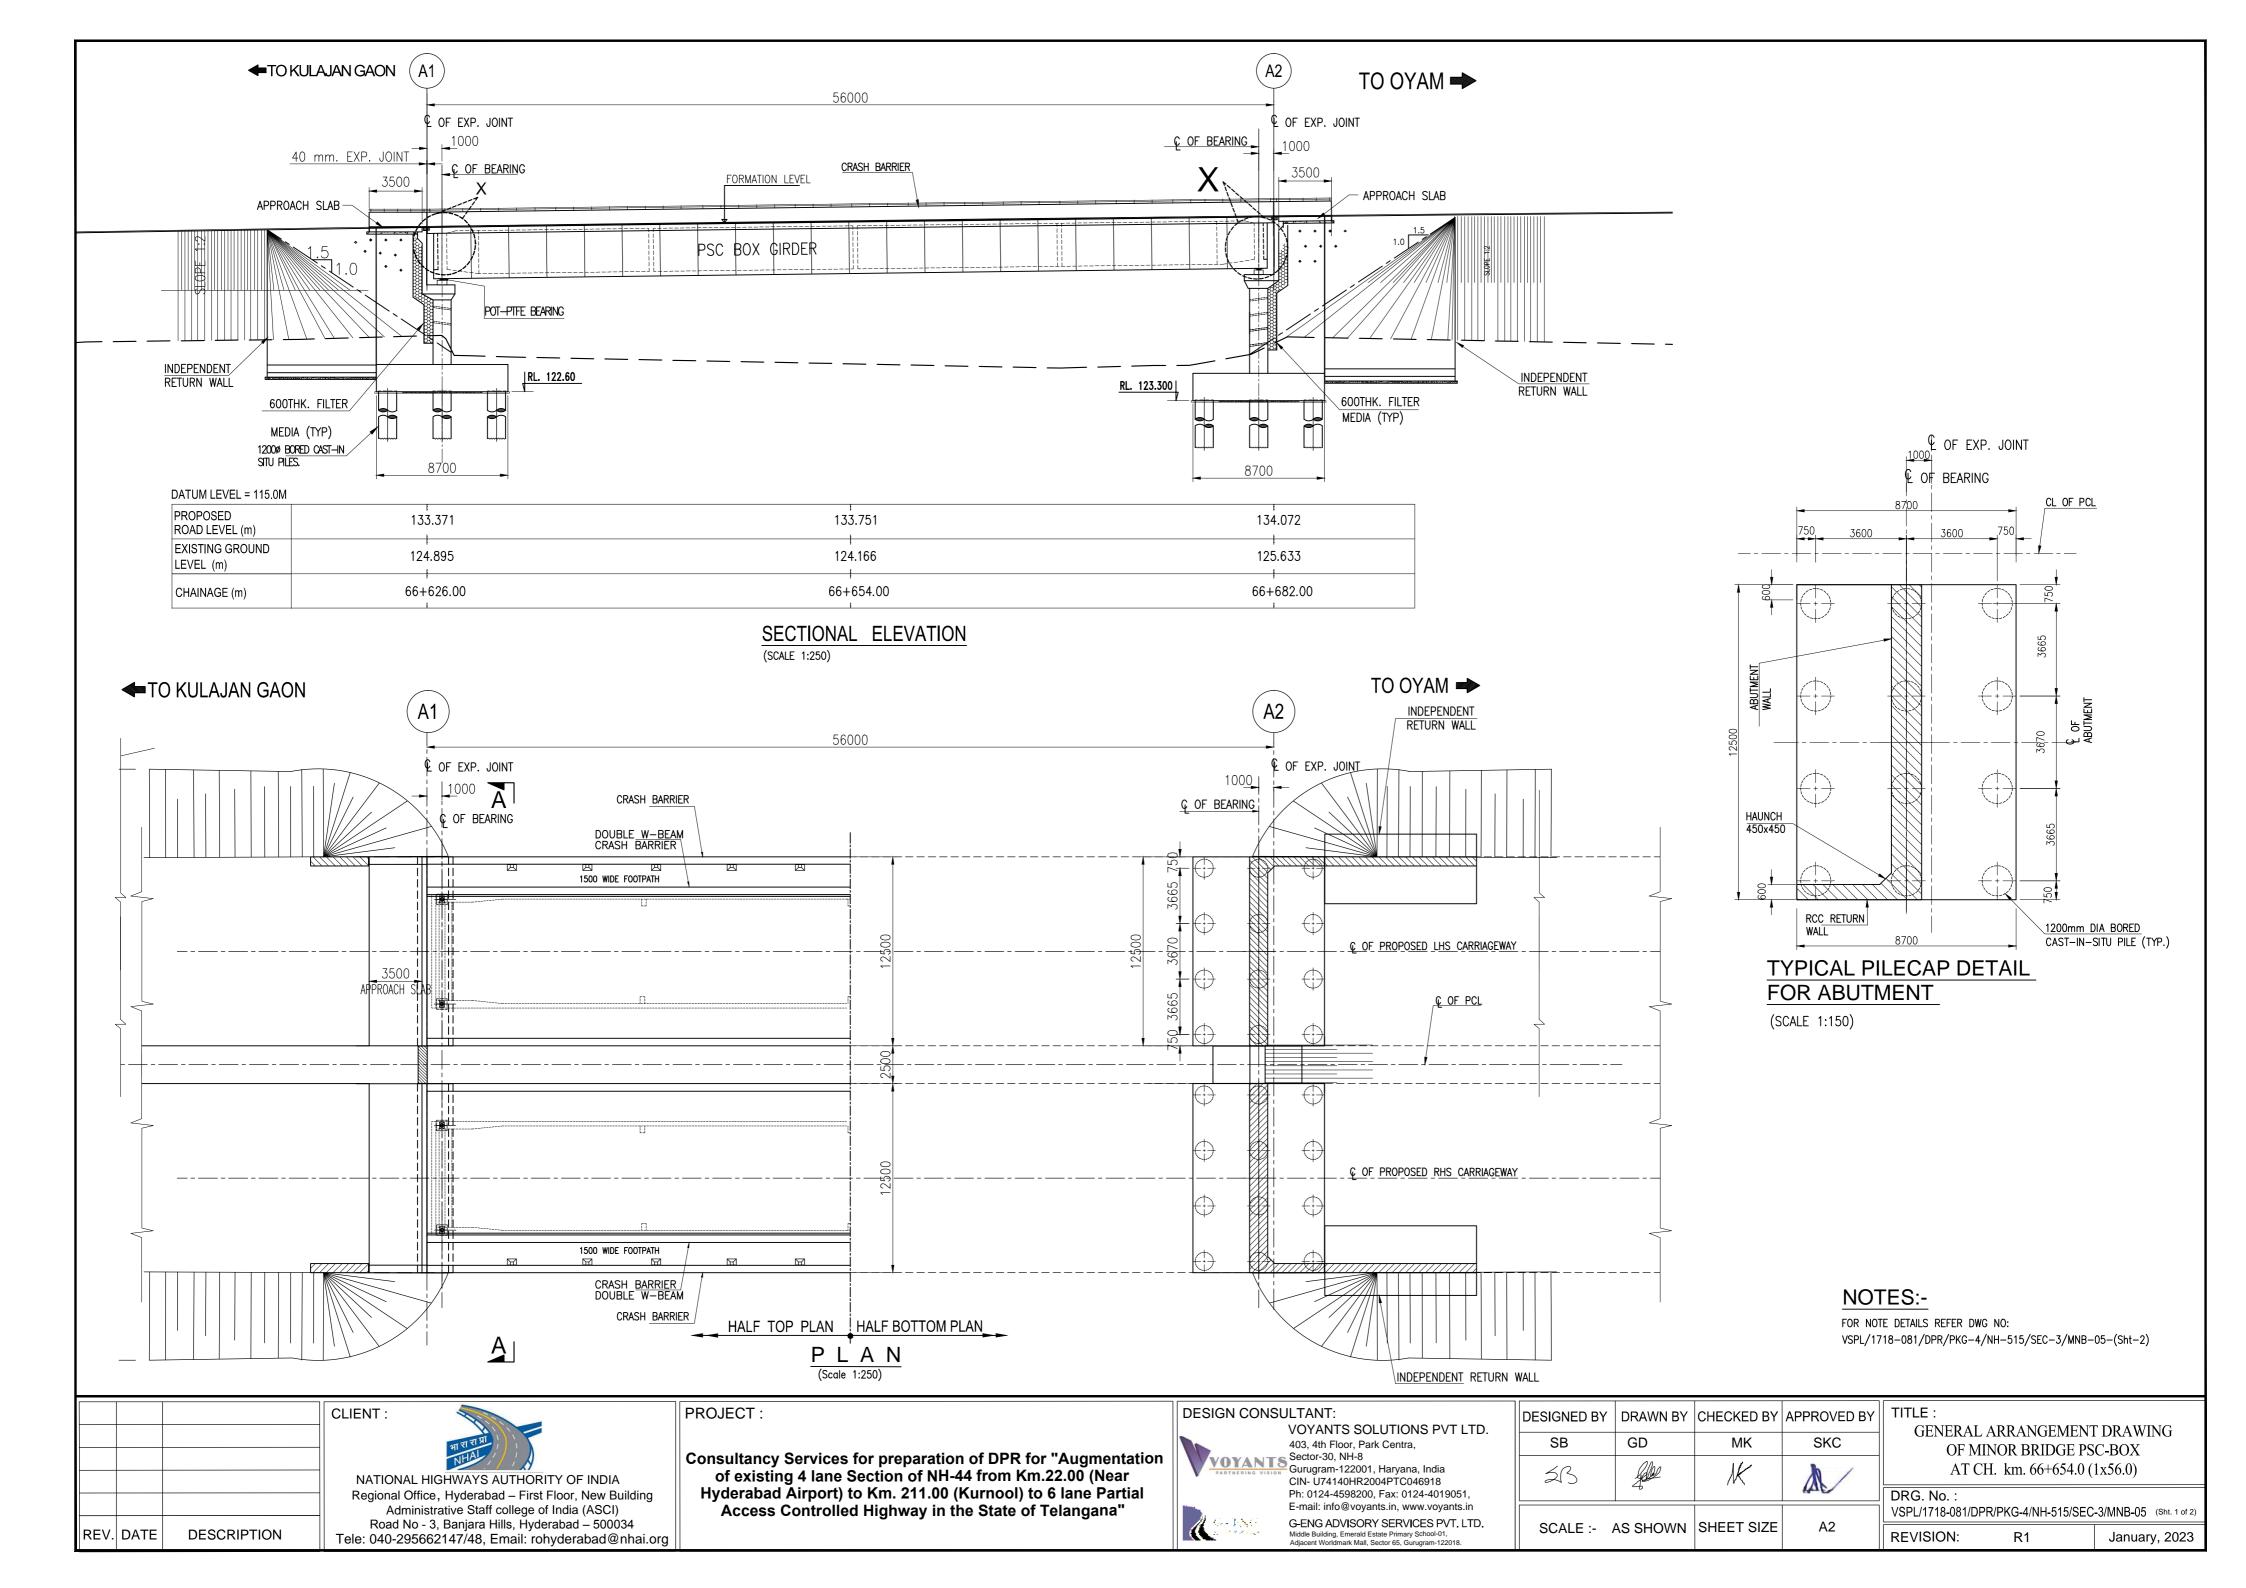

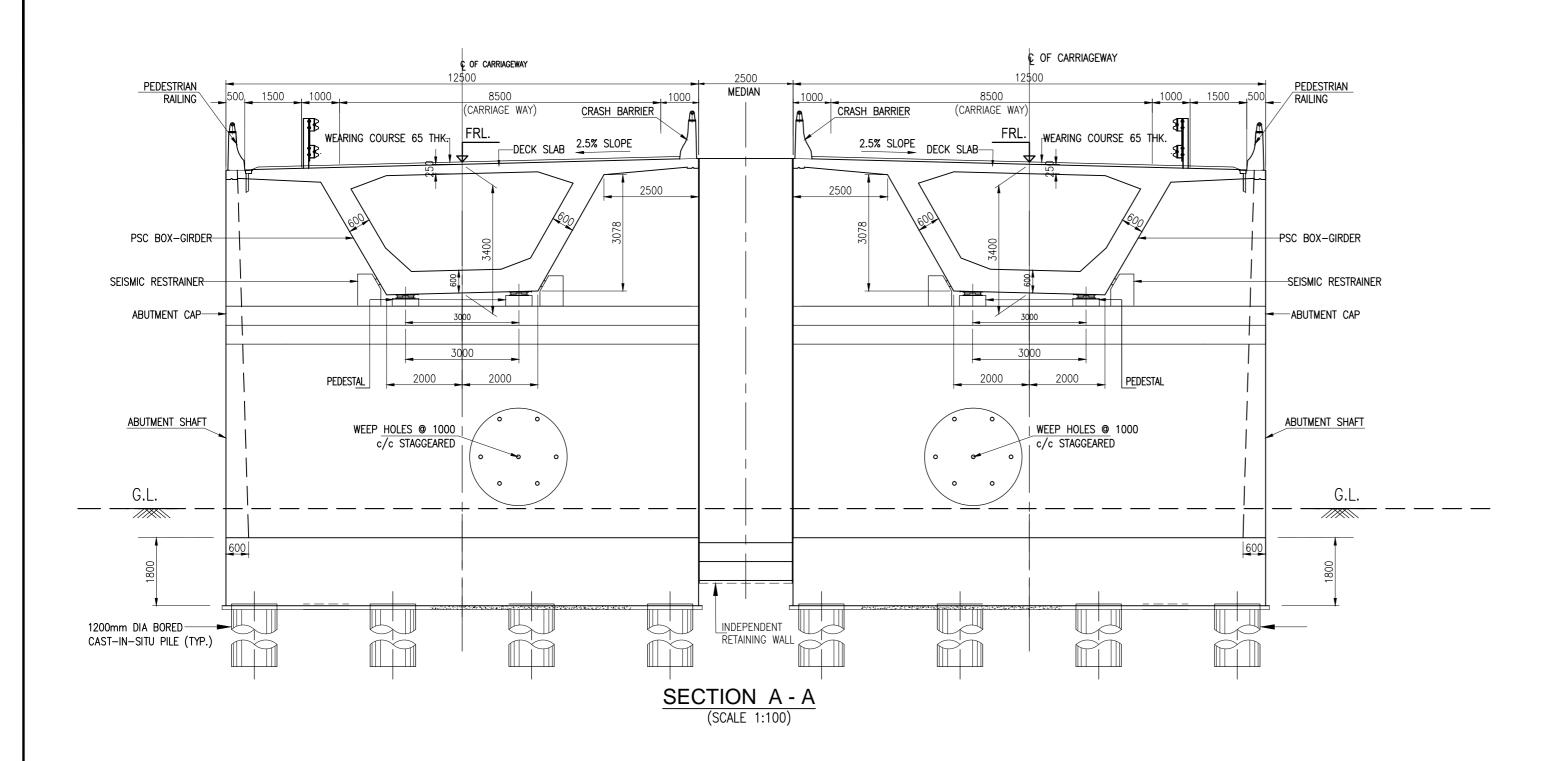

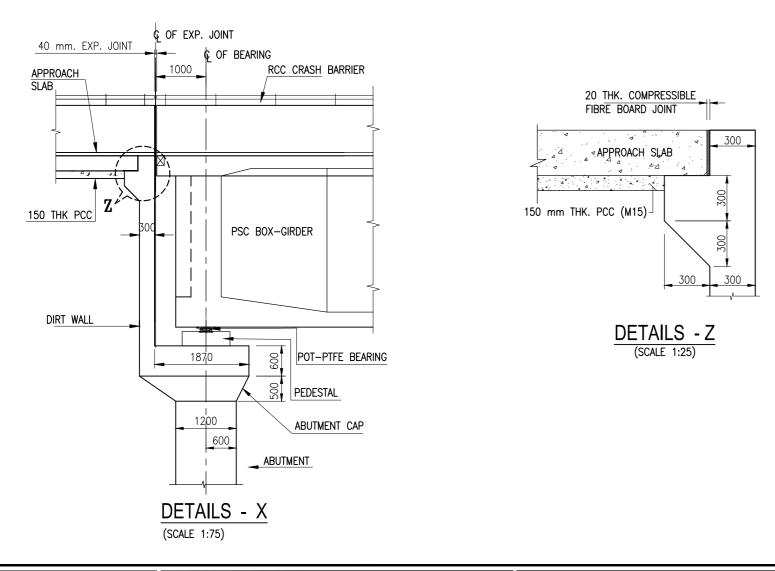

NOTES:

- 1. ALL DIMENSIONS ARE IN MILLIMETRES AND LEVELS ARE IN METRES. UNLESS OTHERWISE SPECIFIED.
- 2. DIMENSIONS ARE NOT TO BE SCALED. ONLY WRITTEN DIMENSIONS SHALL BE FOLLOWED.
- 3. EXPANSION JOINTS SHALL BE OF STRIP SEAL TYPE AS PER SPECIFICATION.
- 4. POT PTFE BEARING SHALL BE USED.

PCC LEVELING COURSE

- 5. GRADE OF CONCRETE :-
- PSC BOX RCC CRASH BARRIER ABUTMENT, ABUTMENT CAP PIER, PIER CAP APPROACH SLAB M30
- 6. HIGH STRENGTH DEFORMED BARS SHALL BE OF GRADE Fe500 CONFORMING TO IS: 1786-1985.

— M15

- 7. EXPANSION JOINT SHALL BE OF STRIP SEAL TYPE AS PER SPECIFICATION.
- 8. DESIGN OF BRIDGE IS BASED ON LIVE LOAD COMBINATION OF 3-LANES OF CLASS A OR 70R + CLASS A OR SV WHICHEVER PRODUCE SEVER EFFECT.
- 9. LAYING, COMPACTION & EXTENT OF BACKFILL BEHIND ABUTMENT & RETAINING WALLS SHALL CONSIST OF SELECTED EARTH CONFIRMING TO THE APPENDIX-6 OF IRC:78-2014 HAVING PROPERTIES C=0, $\emptyset = 30^{\circ}$ & DENSITY=20KN/m.
- 10. WEEP HOLES ON THE ABUTMENT & RETAINING WALLS SHALL BE SPACED 1000 c/c HORIZANTALY & VERTICALLY IN STAGGERED MANNER FROM 500MM ABOVE LWL TO HFL.
- 11. THIS DRAWING SHALL BE READ IN CONJUNCTION WITH DRG. No. VSPL/1718-081/DPR/PKG-4/NH-515/SEC-3/MNB-05-(Sht-1)

			CLIENT:
			भा रा रामा
			NHA
			NATIONAL HIGHWAYS AUTHORITY OF INDIA
			Regional Office, Hyderabad – First Floor, New Building
			Administrative Staff college of India (ASCI)
REV.	DATE	DESCRIPTION	Road No - 3, Banjara Hills, Hyderabad – 500034 Tele: 040-295662147/48, Email: rohyderabad@nhai.org

PROJECT:

Consultancy Services for preparation of DPR for "Augmentation of existing 4 lane Section of NH-44 from Km.22.00 (Near Hyderabad Airport) to Km. 211.00 (Kurnool) to 6 lane Partial Access Controlled Highway in the State of Telangana"





VOYANTS SOLUTIONS PVT LTD. 403, 4th Floor, Park Centra, VOYANTS Sector-30, NH-8
Gurugram-122001, Haryana, India CIN- U74140HR2004PTC046918 Ph: 0124-4598200, Fax: 0124-4019051, E-mail: info@voyants.in, www.voyants.in G-ENG ADVISORY SERVICES PVT. LTD. Middle Building, Emerald Estate Primary School-01, Adiacent Worldmark Mall. Sector 65. Gurugram-122018.


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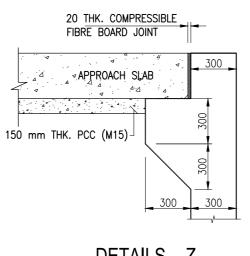
TITLE: GENERAL ARRANGEMENT DRAWING OF MAJOR BRIDGE PSC-BOX AT CH. km. 66+654.0 (1x56.0)

DRG. No.: VSPL/1718-081/DPR/PKG-4/NH-515/SEC-3/MNB-05 (Sht. 2 of 2) REVISION: January, 2023



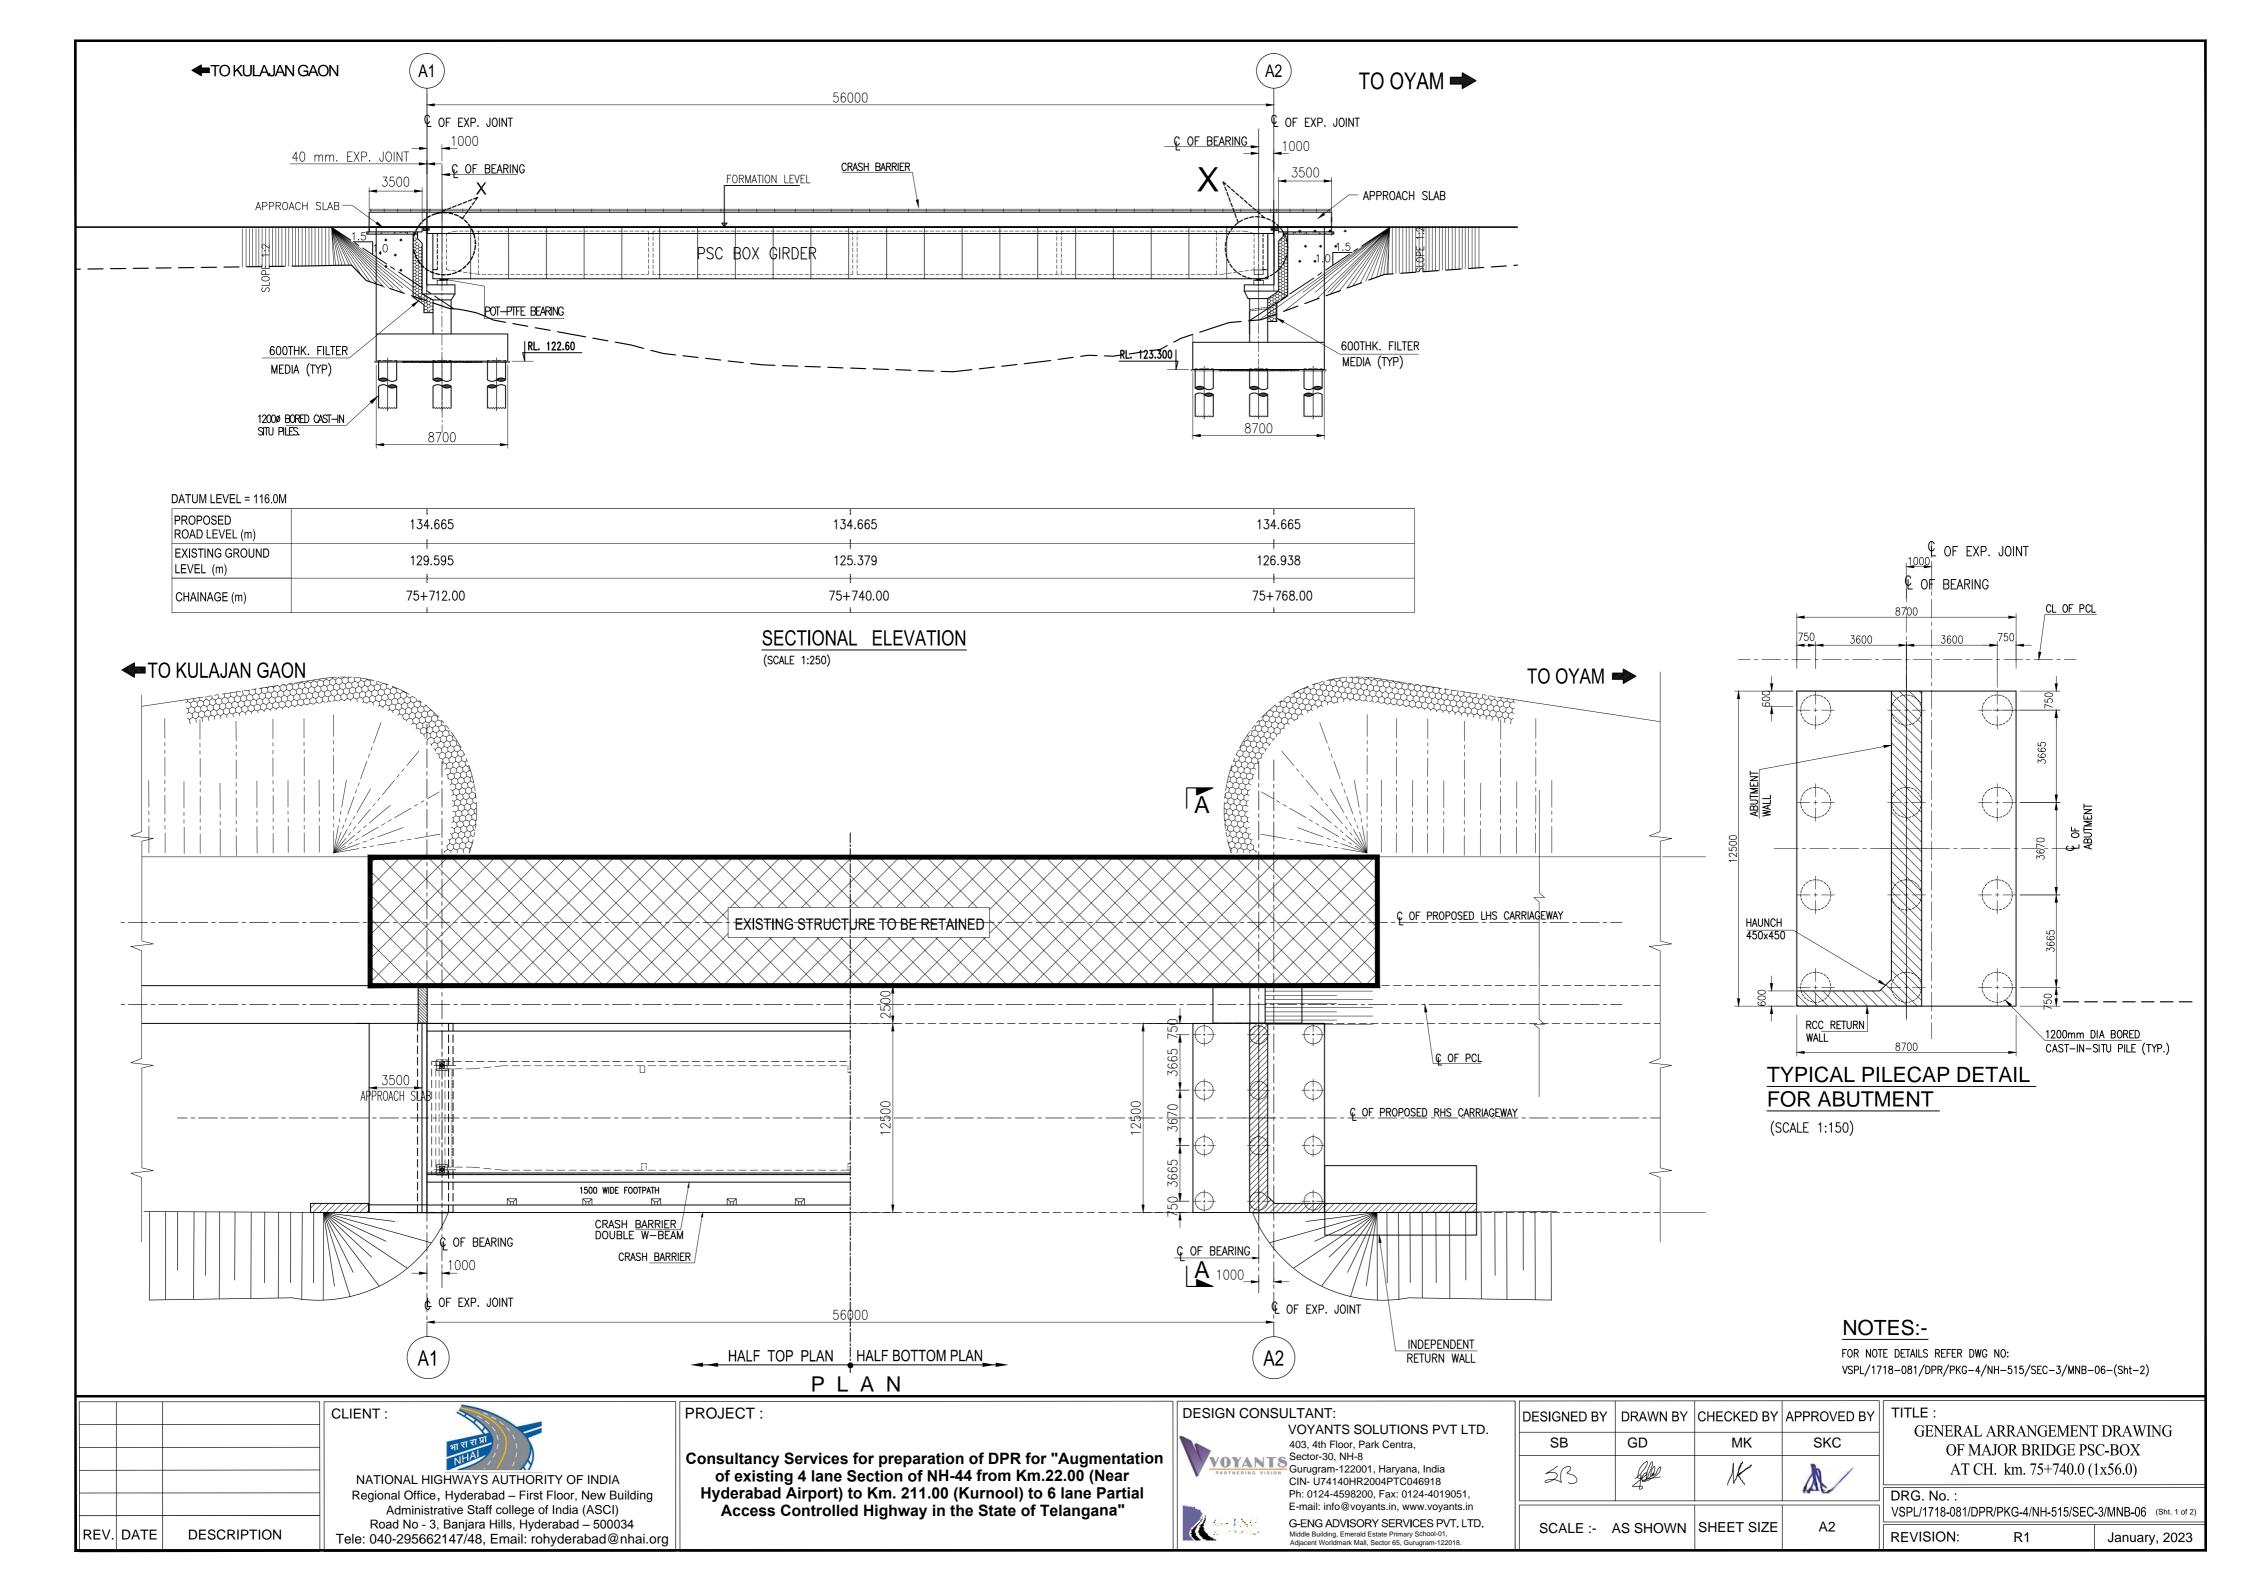

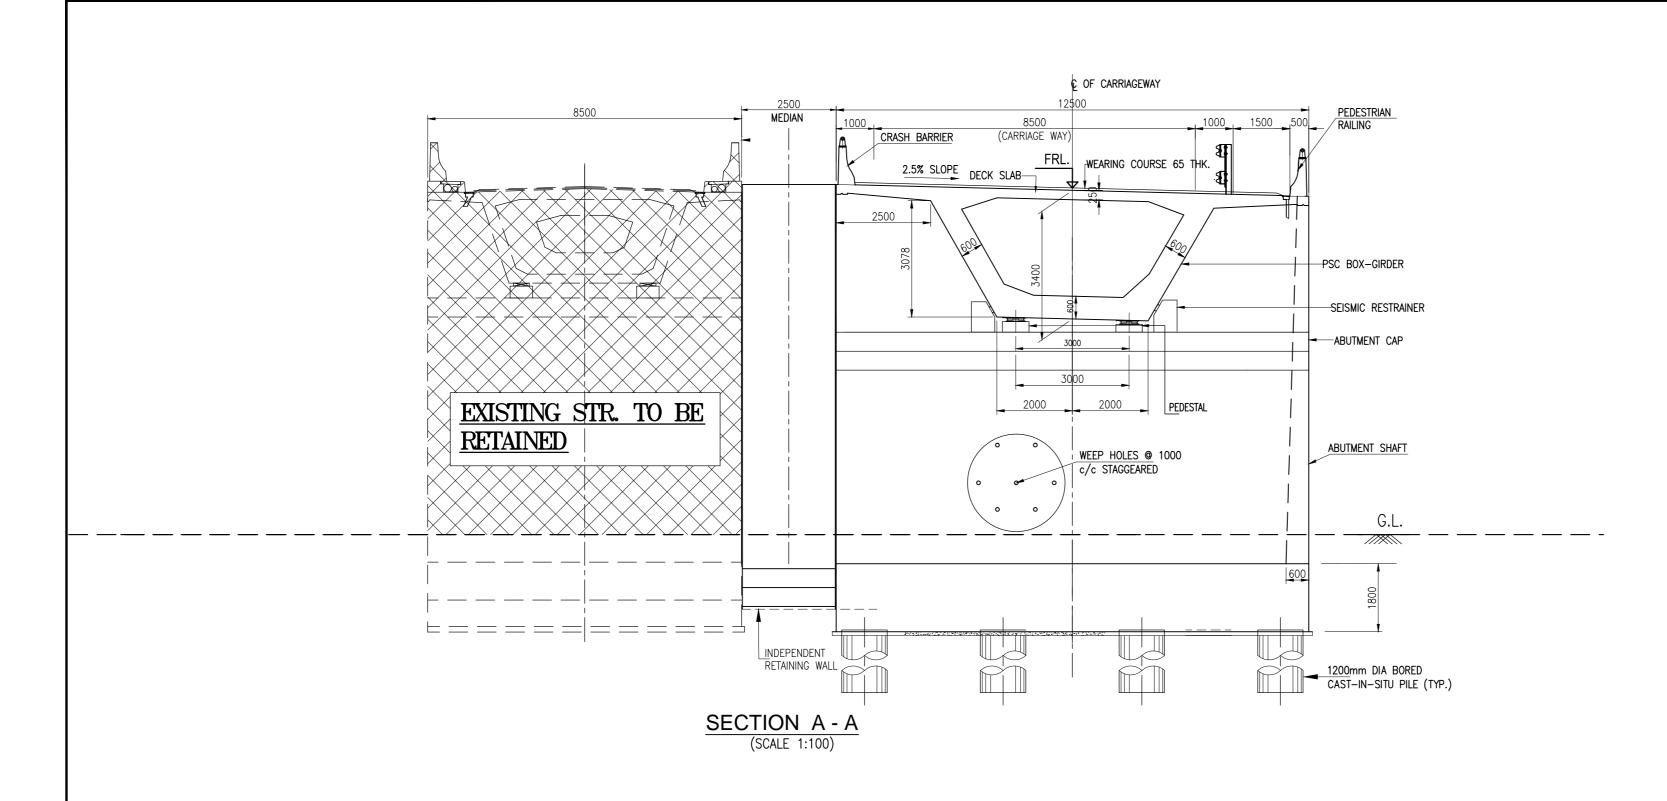

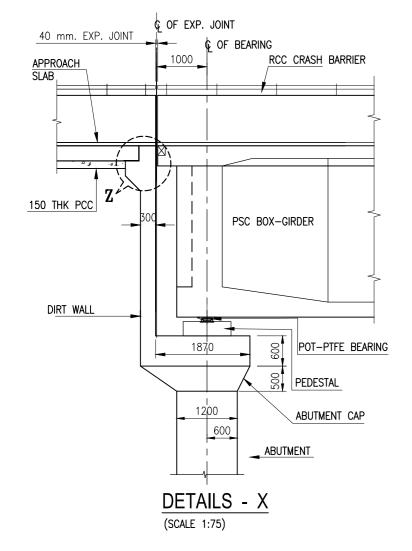

DETAILS - Z (SCALE 1:25)

NOTES:

- 1. ALL DIMENSIONS ARE IN MILLIMETRES AND LEVELS ARE IN METRES. UNLESS OTHERWISE SPECIFIED.
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- 3. EXPANSION JOINTS SHALL BE OF STRIP SEAL TYPE AS PER SPECIFICATION.
- 4. POT PTFE BEARING SHALL BE USED.
- 5. GRADE OF CONCRETE :-
- PSC BOX RCC CRASH BARRIER M40
- ABUTMENT, ABUTMENT CAP PIER, PIER CAP
- APPROACH SLAB PCC LEVELING COURSE
- 6. HIGH STRENGTH DEFORMED BARS SHALL BE OF GRADE Fe500 CONFORMING TO IS: 1786-1985.
- 7. EXPANSION JOINT SHALL BE OF STRIP SEAL TYPE AS PER SPECIFICATION.
- 8. DESIGN OF BRIDGE IS BASED ON LIVE LOAD COMBINATION OF 3-LANES OF CLASS A OR 70R + CLASS A OR SVWHICHEVER PRODUCE SEVER EFFECT.
- 9. LAYING, COMPACTION & EXTENT OF BACKFILL BEHIND ABUTMENT & RETAINING WALLS SHALL CONSIST OF SELECTED EARTH CONFIRMING TO THE APPENDIX-6 OF IRC:78-2014 HAVING PROPERTIES C=0, Ø=>30° & DENSITY=20KN/m.
- 10. WEEP HOLES ON THE ABUTMENT & RETAINING WALLS SHALL BE SPACED 1000 c/c HORIZANTALY & VERTICALLY IN STAGGERED MANNER FROM 500MM ABOVE LWL TO HFL.
- 11. THIS DRAWING SHALL BE READ IN CONJUNCTION WITH DRG. No. VSPL/1718-081/DPR/PKG-4/NH-515/SEC-3/MNB-06-(Sht-1)



PROJECT:

Consultancy Services for preparation of DPR for "Augmentation of existing 4 lane Section of NH-44 from Km.22.00 (Near Hyderabad Airport) to Km. 211.00 (Kurnool) to 6 lane Partial Access Controlled Highway in the State of Telangana"




VOYANTS SOLUTIONS PVT LTD. 403, 4th Floor, Park Centra, Sector-30, NH-8
Gurugram-122001, Haryana, India CIN- U74140HR2004PTC046918 Ph: 0124-4598200, Fax: 0124-4019051, E-mail: info@voyants.in, www.voyants.in G-ENG ADVISORY SERVICES PVT. LTD. Middle Building, Emerald Estate Primary School-01, Adiacent Worldmark Mall. Sector 65. Gurugram-122018.

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SCALE :-	AS SHOWN	SHEET SIZE	A2	Ľ

TITLE: GENERAL ARRANGEMENT DRAWING OF MAJOR BRIDGE PSC-BOX AT CH. km. 75+740.0 (1x56.0)

DRG. No.: VSPL/1718-081/DPR/PKG-4/NH-515/SEC-3/MNB-06 (Sht. 2 of 2) REVISION: January, 2023

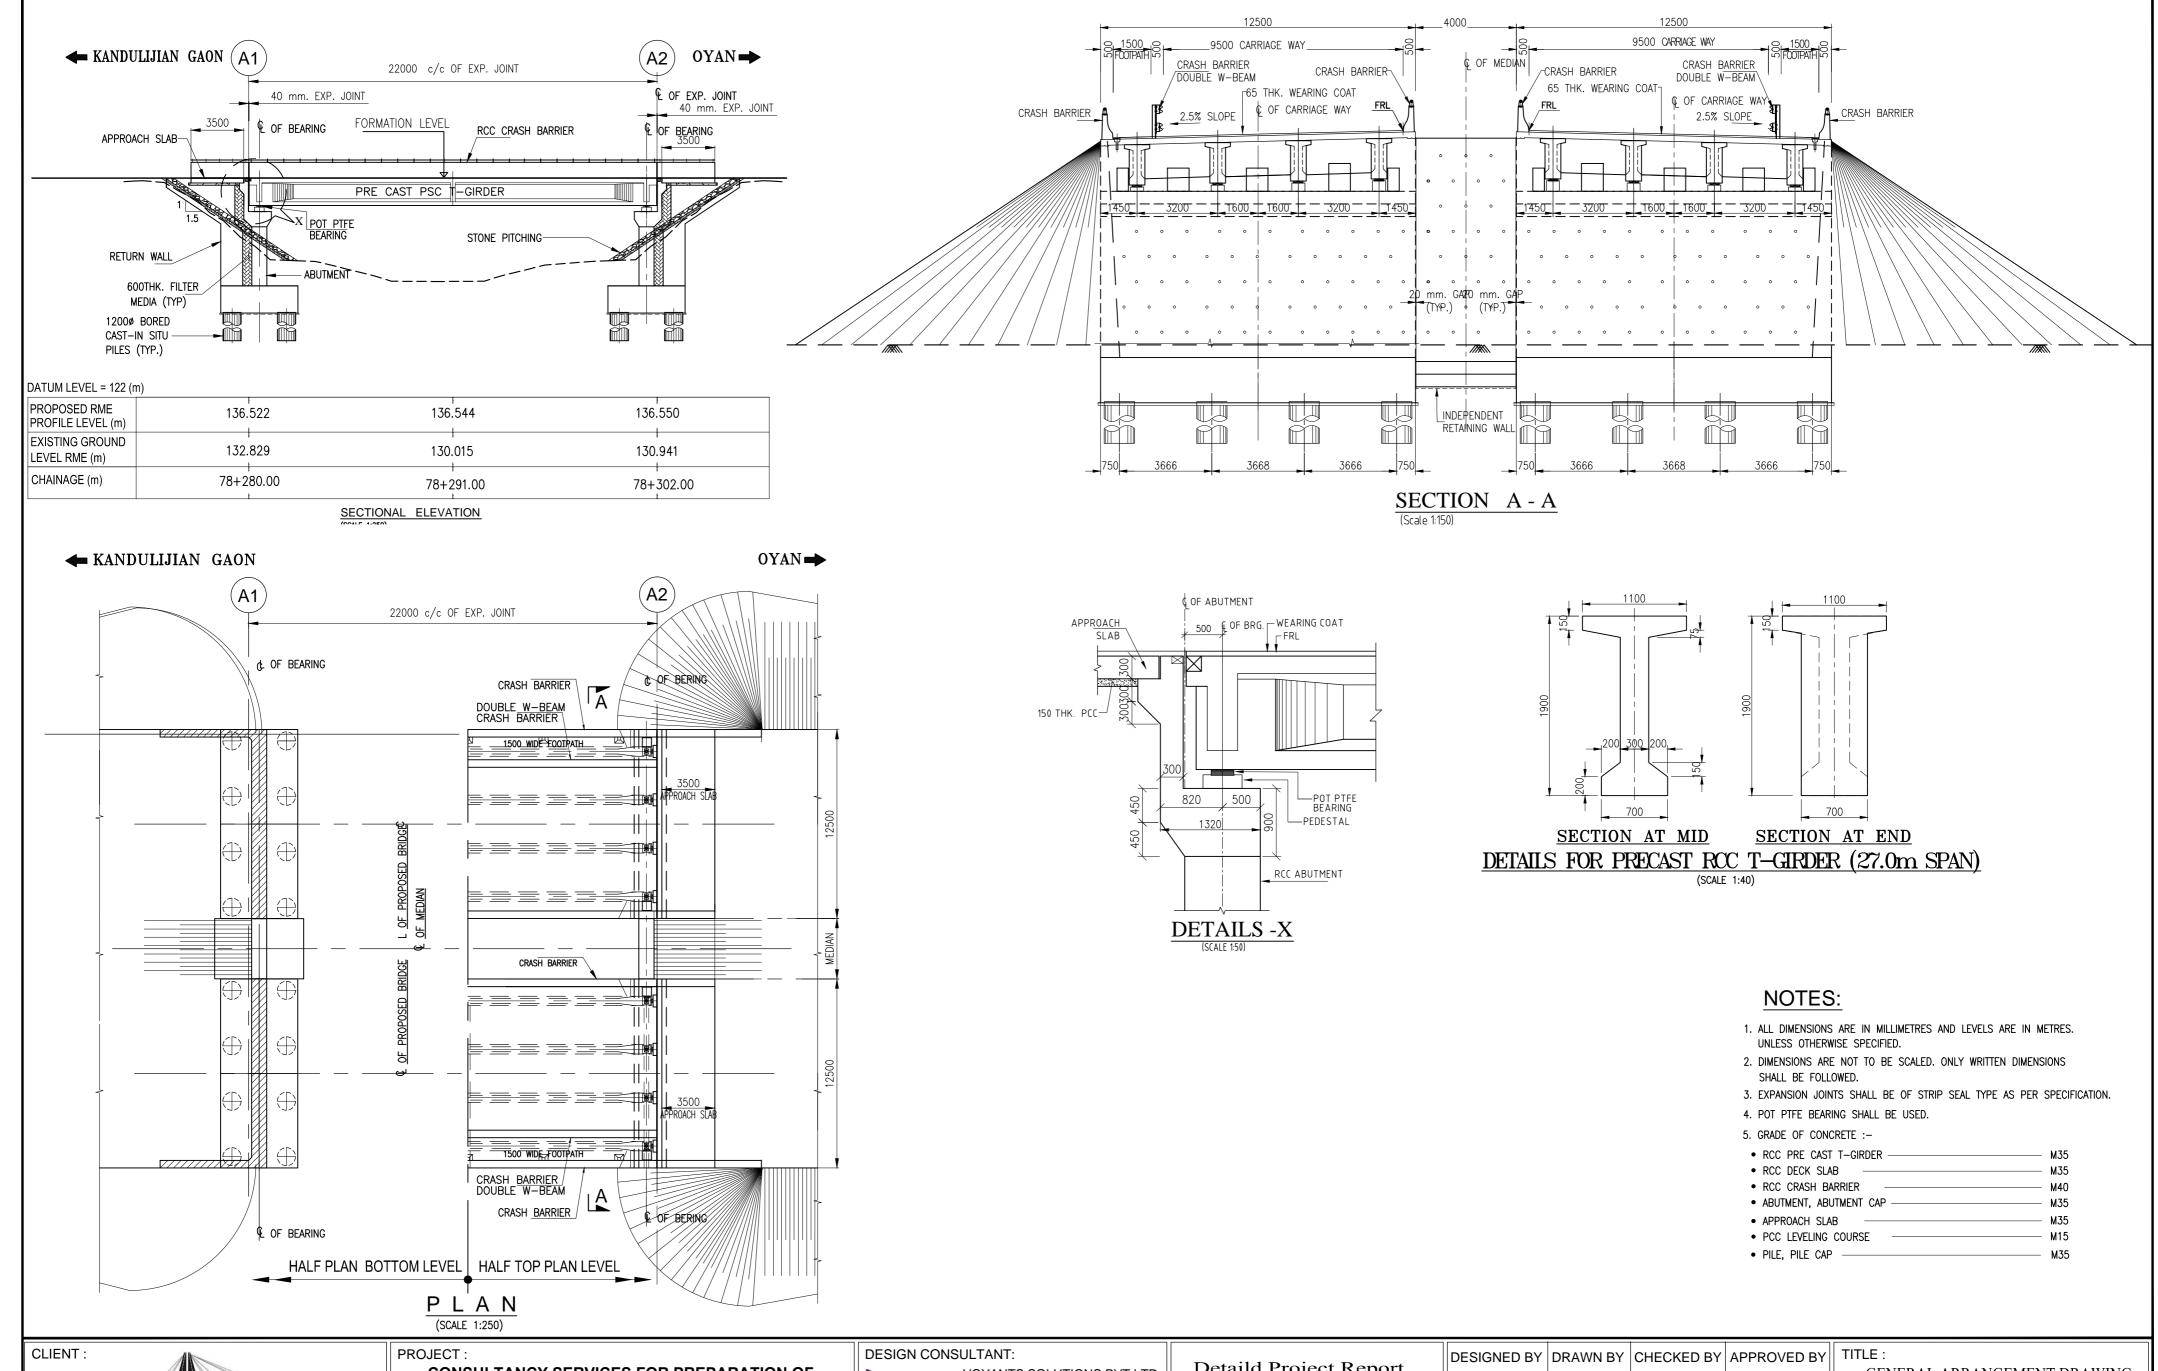

NATIONAL HIGHWAYS AND INFRASTRUCTURE **DEVELOPMENT CORPORATION LTD. (MINISTRY** OF ROAD TRANSPORT AND HIGHWAYS) **GOVERNMENT OF INDIA**

CONSULTANCY SERVICES FOR PREPARATION OF DETAILED PROJECT REPORT FOR DEVELOPMENT OF ECONOMIC CORRIDORS, INTER CORRIDORS AND FEEDER ROUTES TO IMPROVE THE EFFICIENCY OF FREIGHT MOVEMENTS IN INDIA UNDER BHARATMALA PARIYOJANA (LOT-1:PACKAGE IV)

VOYANTS SOLUTIONS PY VOYANTS 403, 4th Floor, Park Centra, Sector-30, NH-8 Gurugram-122001, Haryana, India CIN- U74140HR2004PTC046918 Ph: 0124-4598200, Fax: 0124-401 E-mail: info@voyants.in, www.voy

VT LTD.	D	Detaild Project Repor								
ia 3 119051, yants.in										
	REV.	DATE	DESCRIPTION							

Detaild Project Report	DESIGNED BY	DRAWN BY	CHECKED BY	APPROVED BY	
Betana Project Report	SLM	G. Das	MK	SKC	
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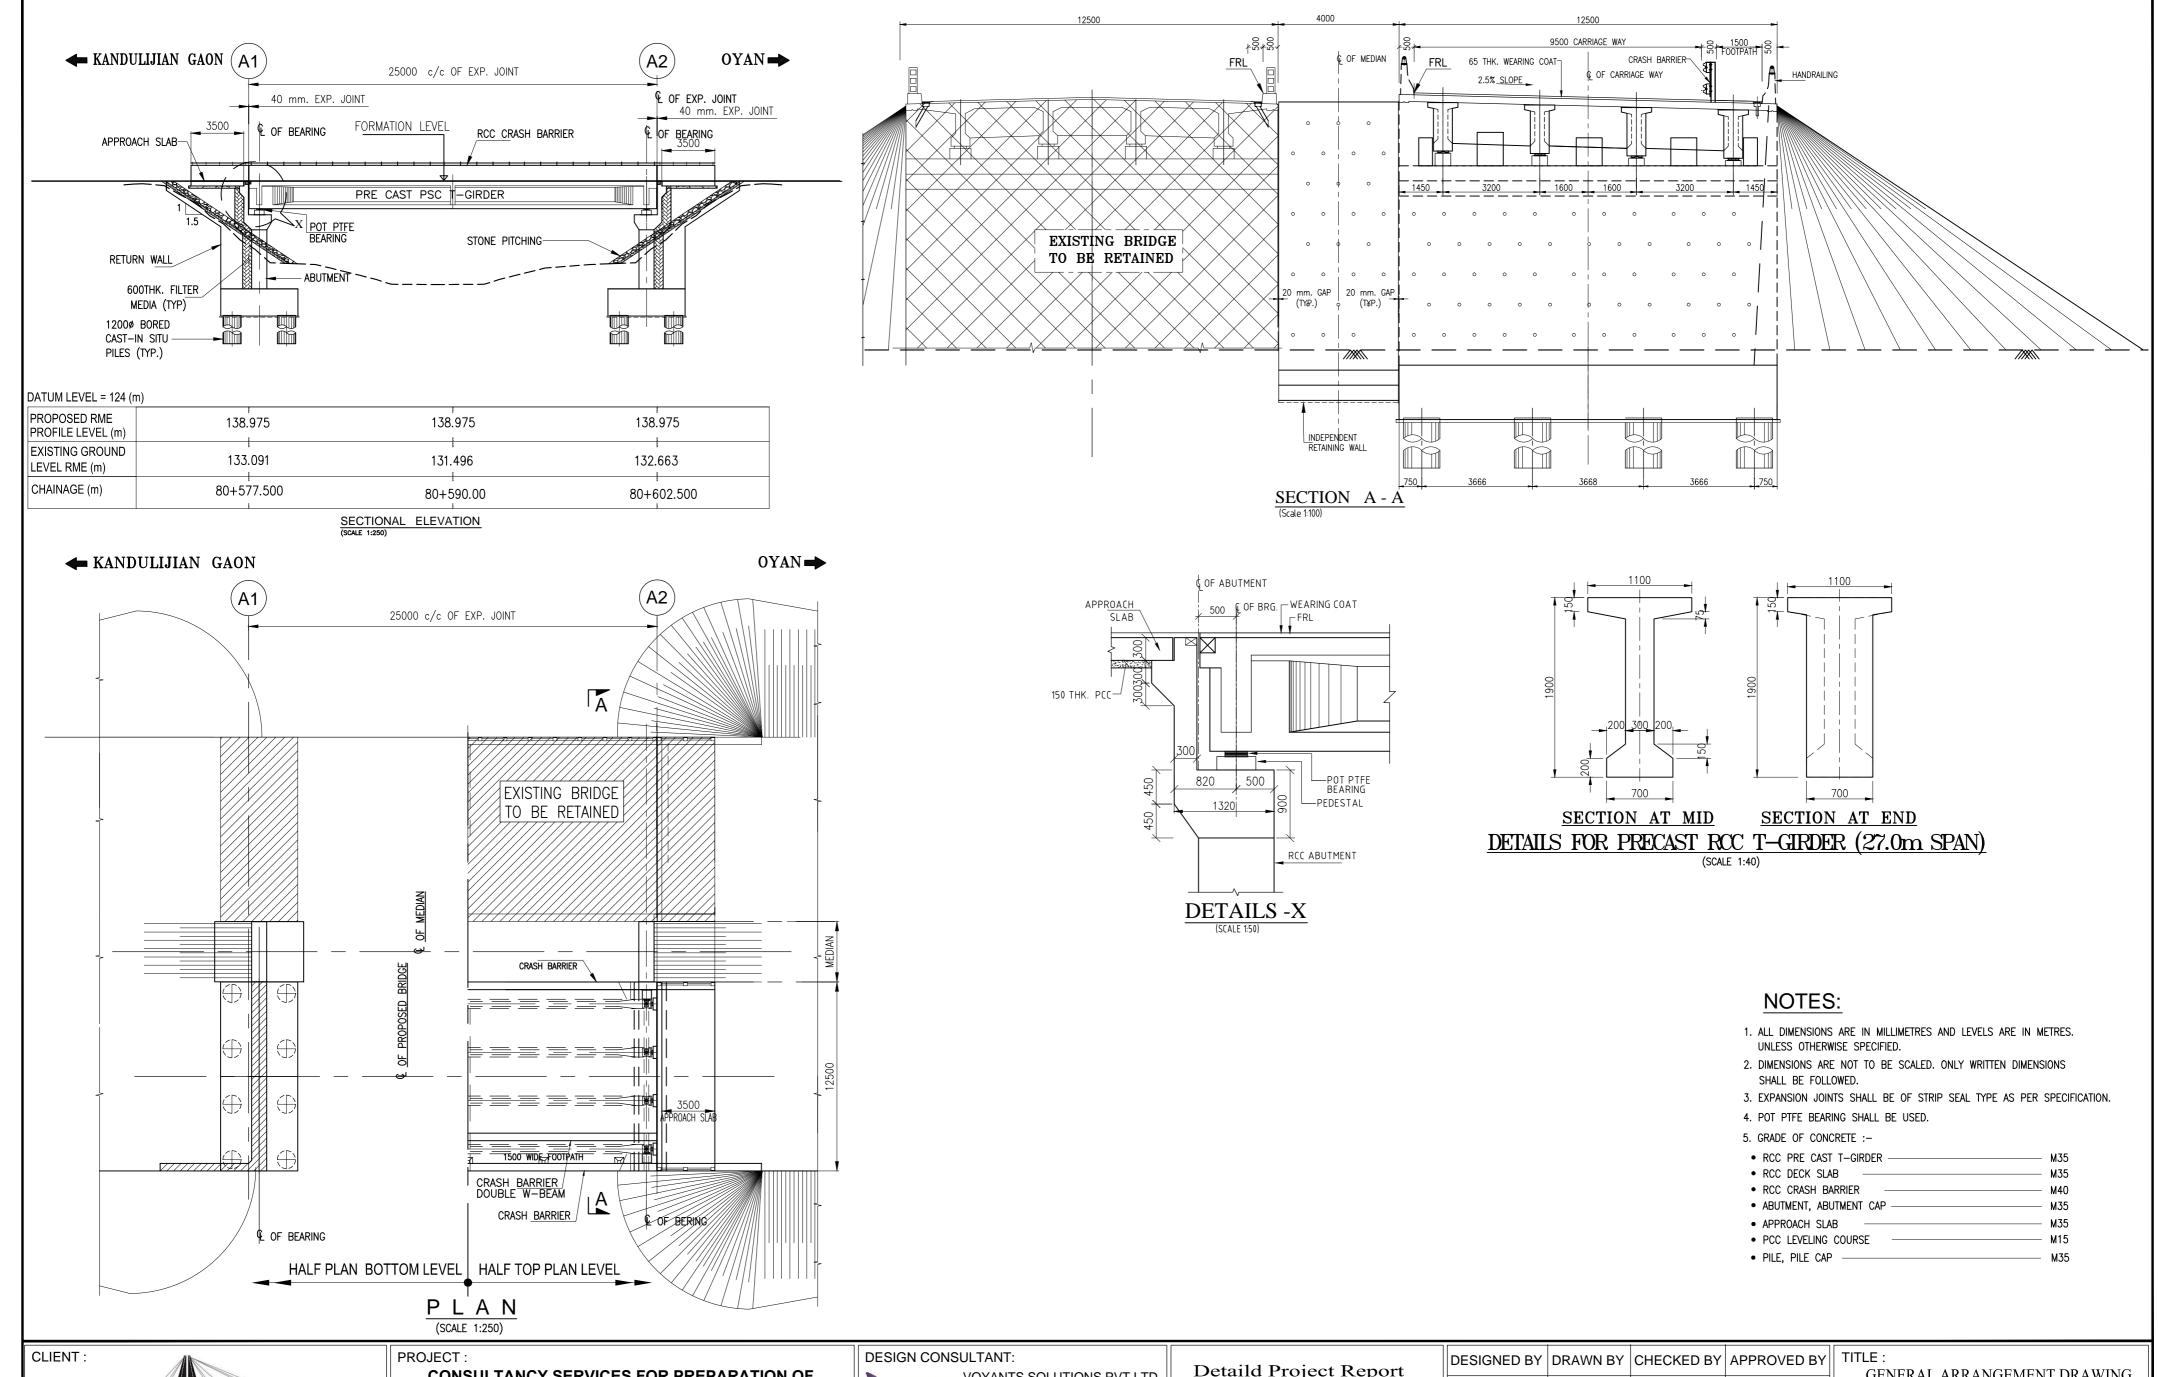
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GENERAL ARRANGEMENT DRAWING OF MINOR BRIDGE AT Ch. Km.78+291.00 DRG. No.

VSPL/1718-081/DPR/PKG-4/NH-515/SEC-3/MNB-07. (Sht. 1 of 1) **REVISION:** January, 2023



NATIONAL HIGHWAYS AND INFRASTRUCTURE DEVELOPMENT CORPORATION LTD. (MINISTRY OF ROAD TRANSPORT AND HIGHWAYS) GOVERNMENT OF INDIA CONSULTANCY SERVICES FOR PREPARATION OF DETAILED PROJECT REPORT FOR DEVELOPMENT OF ECONOMIC CORRIDORS, INTER CORRIDORS AND FEEDER ROUTES TO IMPROVE THE EFFICIENCY OF FREIGHT MOVEMENTS IN INDIA UNDER BHARATMALA PARIYOJANA (LOT-1:PACKAGE IV)

VOYANTS SOLUTIONS PVT LTD.


403, 4th Floor, Park Centra,
Sector-30, NH-8
Gurugram-122001, Haryana, India
CIN- U74140HR2004PTC046918
Ph: 0124-4598200, Fax: 0124-4019051,
E-mail: info@voyants.in, www.voyants.in


	Detaild Project	Report	DESIGNED BY	DRAWN BY	CHECKED BY	APPROVED BY	'
).	Betaile 1 reject	report	SLM	G. Das	MK	SKC	
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	REV. DATE DESC	RIPTION	SCALE :	AS SHOWN	SHEET SIZE	A2	F

TITLE:
GENERAL ARRANGEMENT DRAWING
OF MINOR BRIDGE AT Ch. 80+590.0
(RETAINED+NEW)

DRG. No. : VSPL/1718-081/DPR/PKG-4/NH-515/SEC-3/MNB-08. (Sht. 1 of 2) REVISION: R1 January, 2023

									Structur	e List : N	H-515_PK	(G-3								
	Chaina	ge (KM)			Existing Detail	ls					Pro	posal				Вох	data		CLEAR	
No.	Existing (km)	Design (km)	Name of Stream	Category of Structure	Type of Superstructure	Span Arrangement (m)	1	Total Width (m)	Remarks	Improvement Proposal	Span Arrangement S (m)	Total Length (m)	ı	Type of Superstructure	Top Slab (a) m	Bottom Slab (b) m	Side Wall (C)m	Middle Wall (d) m		FRL m
1	60+200	57+030	Amarpur	MNB	RCC Box	2 x 3 x 3.3	19.8	8.6	Existing Retain	New 2Lane on LHS	3 x 7.5	22.5	12.5	RCC Box	0.500	0.530	0.550	0.400	3.500	120.068

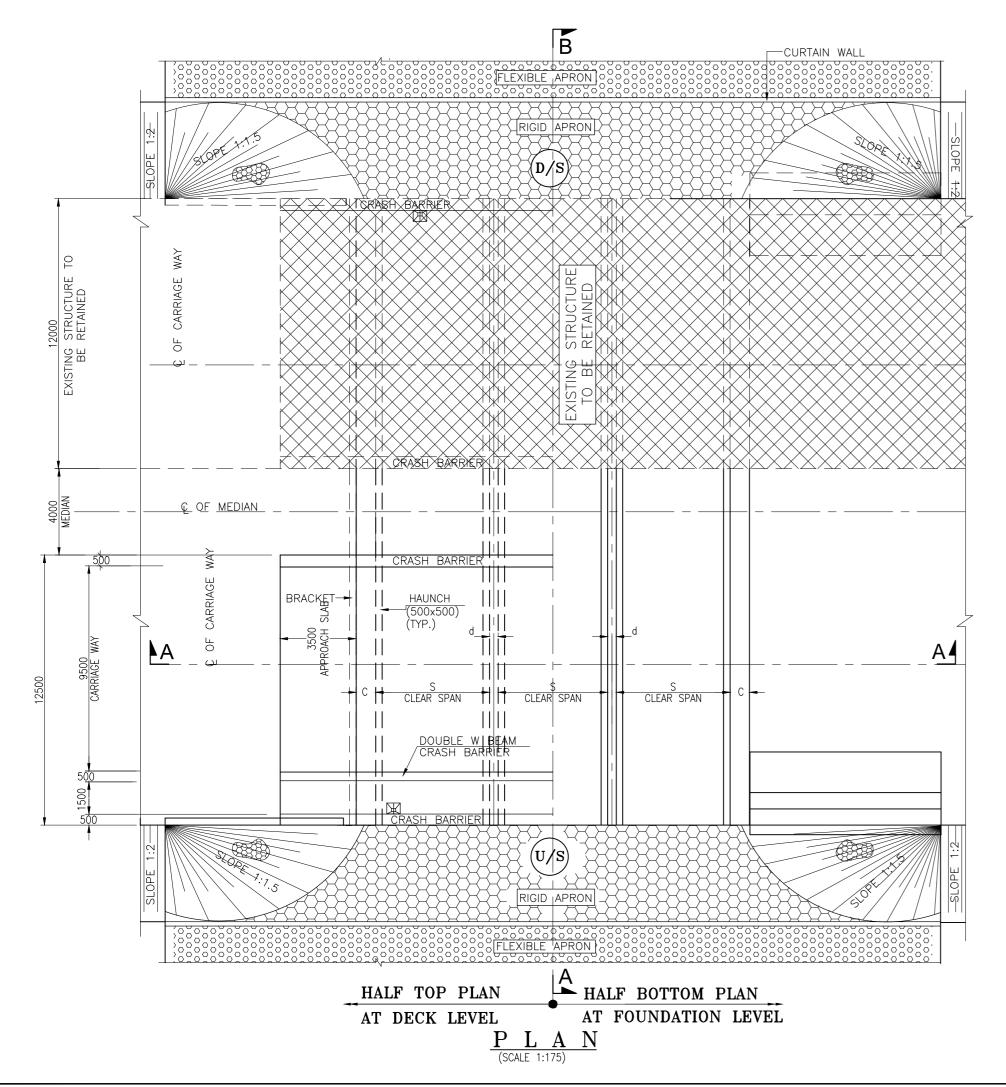

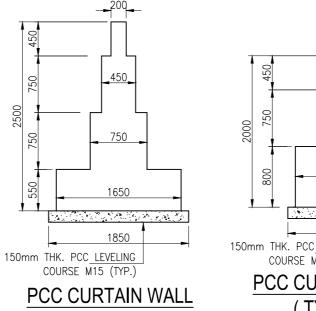

1500 150mm THK. PCC LEVELING COURSE M15 (TYP.)

(TYPE-I) (SCALE 1:50)

PCC CURTAIN WALL (TYPE-II) (SCALE 1:50)

NOTES :-

- 1. ALL DIMENSIONS ARE IN MM AND LEVELS ARE IN M UNLESS MENTIONED OTHERWISE.
- 2. DIMENSIONS ARE NOT TO BE SCALED, ONLY WRITTEN DIMENSIONS ARE TO BE FOLLOWED.
- 3. FOR KEY PLAN, PROPOSED CHAINAGE & LOCATION REFER RELEVANT HIGHWAY DRAWING.
- 4. GRADE OF CONCRETE USED:
- ..M35 a) RCC BOX, RETURN WALL
- b) CRASH BARRIER... .M40
- c) APPROACH SLAB...
- d) PCC LEVELLING COURSE...
- 5. ALL REINFORCEMENT STEEL SHALL BE HIGH STRENGTH DEFORMED BARS OF
- GRADE Fe500 CONFORMING TO IS: 1786-1985 6. THE STRUCTURE IS DESIGNED TO CATER LIVE LOAD COMBINATION OF 3-LANES OF CLASS A OR 1-LANE OF 70R WHILE + 1 LANE A OR IRC SV WHICHEVER PRODUCE
- SEVER EFFECT.
- 7. VARIOUS LEVELS (FRL,EGL) & SUPER ELEVATIONS SHOWN IN DRAWINGS SHALL BE VERIFIED WITH THE HIGHWAY PLAN & PROFILE PRIOR TO ACTUAL EXECUTION IN SITE.
- 8. LAYING, COMPACTION & EXTENT OF BACKFILL BEHIND ABUTMENT & RETAINING WALLS SHALL CONSIST OF SELECTED EARTH CONFIRMING TO THE APPENDIX-6 OF IRC:78-2014 HAVING PROPERTIES C=0, $\phi \ge 30^{\circ}$ & DENSITY=20KN/m³
- 9. WEEP HOLES ON THE ABUTMENT & RETAINING WALLS SHALL BE SPACED 1000 c/c HORIZANTALY & VERTICALLY IN STAGGERED MANNER FROM 500MM ABOVE LWL TO HFL.
- 10. SOFT AND LOOSE PATCHES IN THE BEARING AREA ARE TO BE REPLACED BY COMPACTED GRANULAR FILLS WITH LAYERS NOT EXCEEDING 300MM.
- 11. COMPRESSIBLE FILLER BOARD SHALL BE PROVIDED IN ALL EXPANSION GAPS AND SEALED WITH POLY—SULPHIDE SEALANT.

CLIENT:



NATIONAL HIGHWAYS AND INFRASTRUCTURE **DEVELOPMENT CORPORATION LTD.** (MINISTRY OF ROAD TRANSPORT AND HIGHWAYS) **GOVERNMENT OF INDIA**

PROJECT:

CONSULTANCY SERVICES FOR PREPARATION OF DETAILED PROJECT REPORT FOR DEVELOPMENT OF ECONOMIC CORRIDORS, INTER CORRIDORS AND FEEDER **ROUTES TO IMPROVE THE EFFICIENCY OF FREIGHT** MOVEMENTS IN INDIA UNDER BHARATMALA PARIYOJANA (LOT-1:PACKAGE II) (FROM KM 38+500 TO KM 56+084)

DESIGN CONSULTANT:

VOYANTS SOLUTIONS PVT LT VOYANTS 403, 4th Floor, Park Centra, Sector-30, NH-8 Gurugram-122001, Haryana, India CIN- U74140HR2004PTC046918 Ph: 0124-4598200, Fax: 0124-4019051, E-mail: info@voyants.in, www.voyants.in


	Detaile	ed Project Report	DESIGNED BY	DRAWN BY	CHECKED BY	APPROVED BY	
LTD.		<i>J</i>	SB	GD	SG	SKC	
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	REV. DATE	DESCRIPTION	SCALE :	AS SHOWN	SHEET SIZE	A2	


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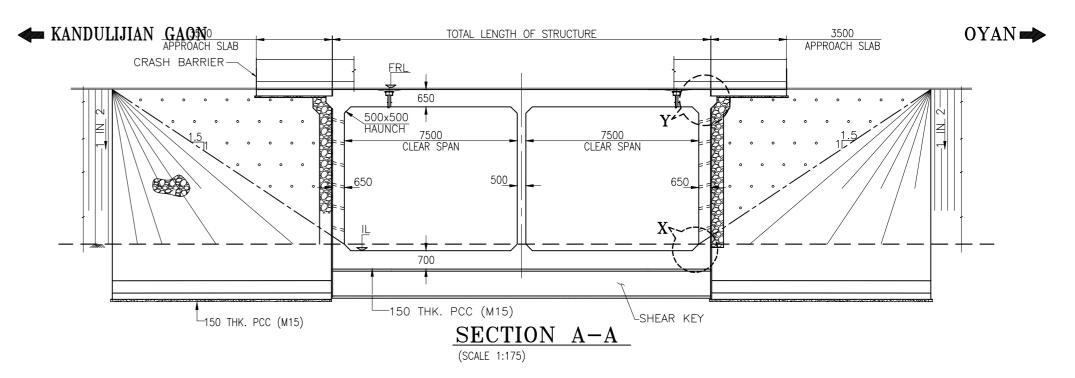
GENERAL ARRANGEMENT DRAWING OF THREE CELL BOX TYPE MINOR BRIDGE AT Ch. Km. 57+030.00 (RETAINED + NEW)

DRG. No.:

VSPL/1718-081/DPR/PKG-4/NH-515/SEC-3/MNB-09(Sht. 1 of 2) REVISION: R1 January, 2023



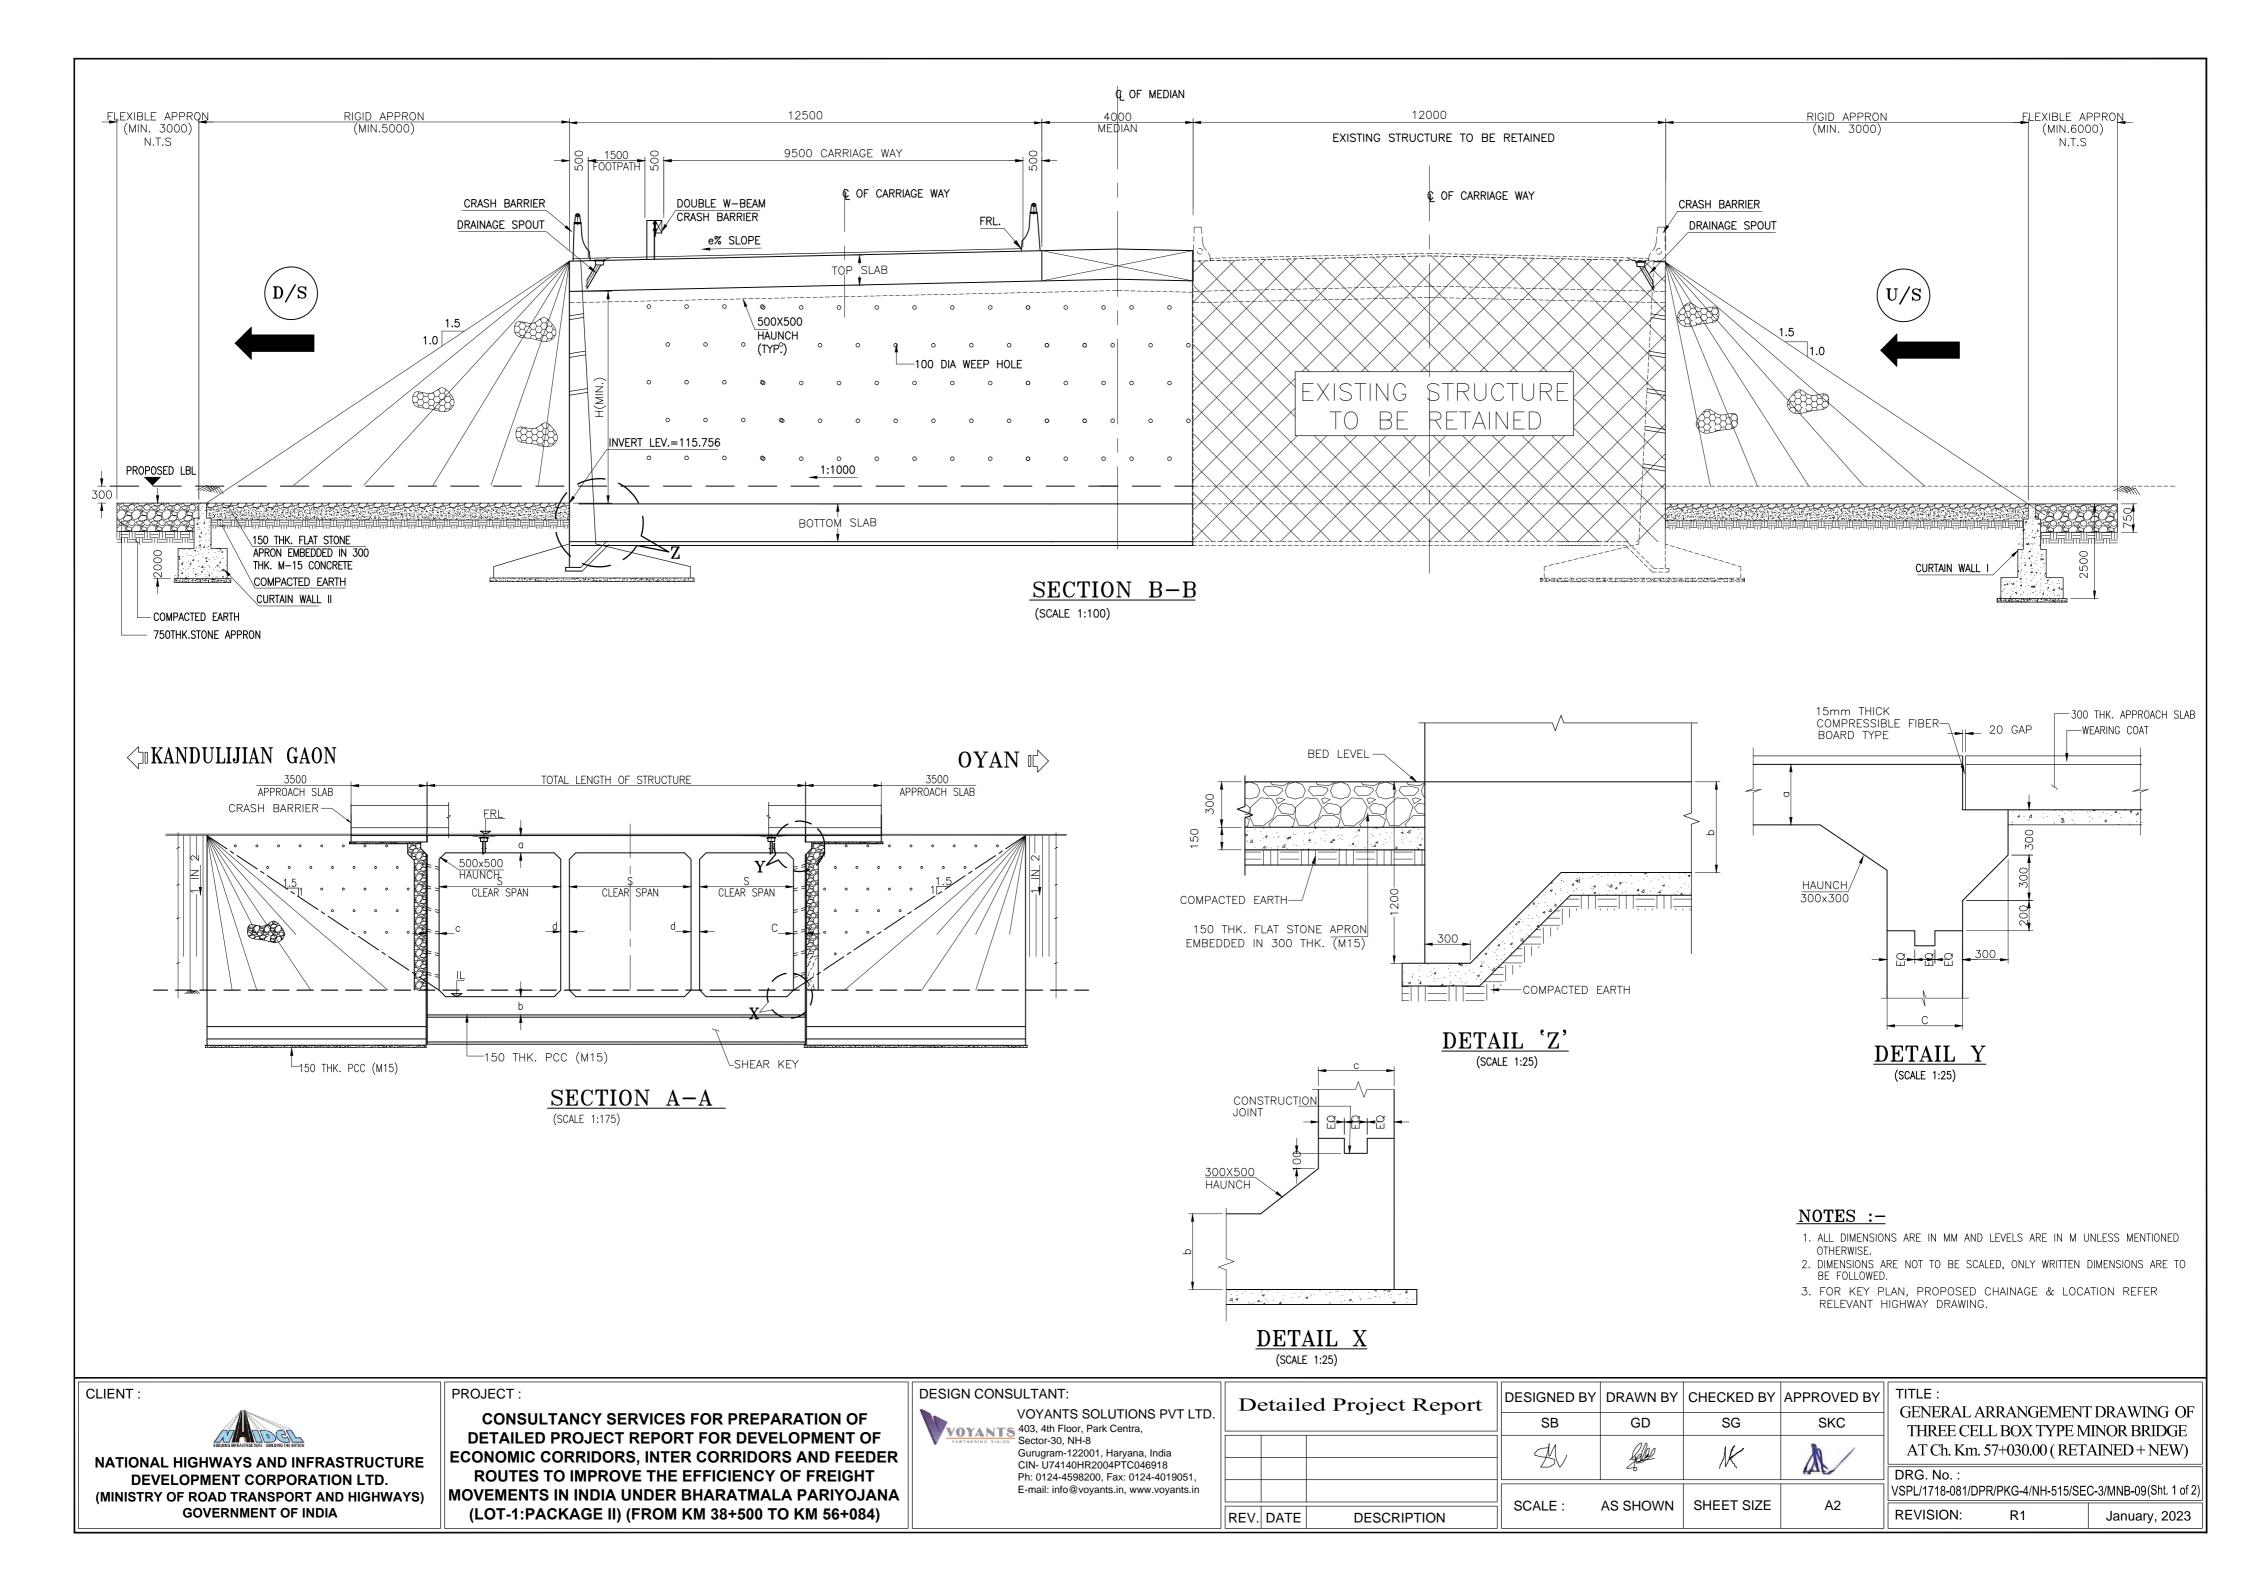

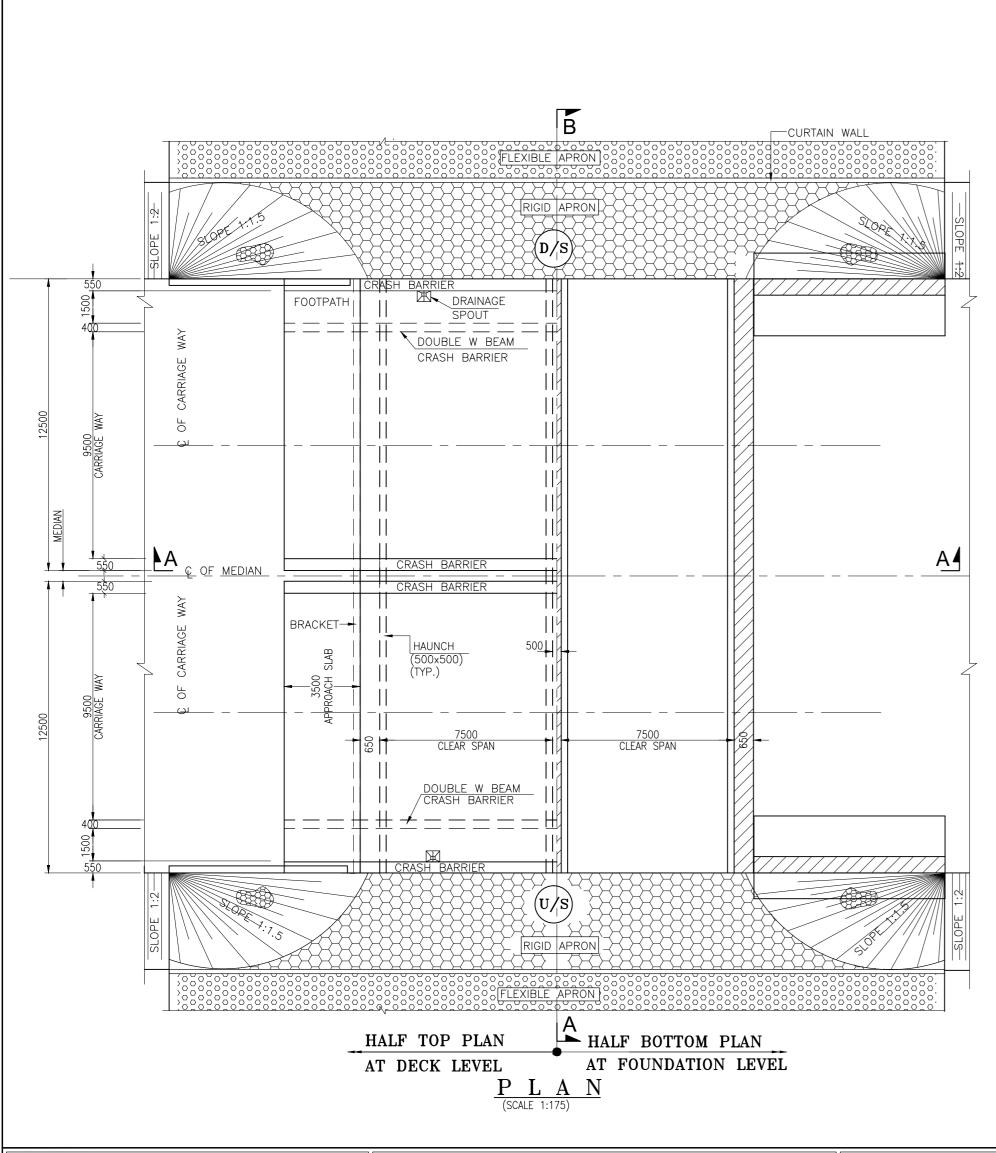

	Structure List: NH-515_PKG-3													
	Proposal						OGL				FRL	CLEAR HEIGHT		
SI. No.	Design (km)	Category of Structure	Improvement Proposal	Span Arrangement (m)	Total Length (m)	Total Width (m)	Type of Superstructure	A1	CENTER	A2	A1	CENTER	A2	IN METRE (H)
1	69+570	MNB	New 2Lane on LHS & RHS	2 x 7.5	15	2 x 12.5	RCC Box	122.553	122.391	122.66	124.886	124.856	124.876	3.600
2	70+150	MNB	New 2Lane on LHS & RHS	2 x 7.5	15	2 x 12.5	RCC Box	122.732	122.761	122.807	127.469	127.353	127.232	7.200
3	73+910	MNB	New 2Lane on LHS & RHS	2 x 7.5	15	2 x 12.5	RCC Box	128.992	128.971	128.97	131.479	131.487	131.494	3.400

- 1. ALL DIMENSIONS ARE IN MM AND LEVELS ARE IN M UNLESS MENTIONED OTHERWISE.
- 2. DIMENSIONS ARE NOT TO BE SCALED, ONLY WRITTEN DIMENSIONS ARE TO BE FOLLOWED.
- 3. FOR KEY PLAN, PROPOSED CHAINAGE & LOCATION REFER RELEVANT HIGHWAY DRAWING.

4. GRADE OF CONCRETE USED:

 a) RCC BOX, RETURN WALL
 M35

 b) CRASH BARRIER
 M40

 c) APPROACH SLAB
 M30

 d) PCC LEVELLING COURSE
 M15

- 5. ALL REINFORCEMENT STEEL SHALL BE HIGH STRENGTH DEFORMED BARS OF GRADE Fe500 CONFORMING TO IS: 1786-1985
- 6. THE STRUCTURE IS DESIGNED TO CATER LIVE LOAD COMBINATION OF 3-LANES OF CLASS A OR 1-LANE OF 70R WHEEL + 1 LANE OF CLASS A OR IRC SV WHICHEVER PRODUCE SEVER EFFECT.
- 7. VARIOUS LEVELS (FRL,EGL) & SUPER ELEVATIONS SHOWN IN DRAWINGS SHALL BE VERIFIED WITH THE HIGHWAY PLAN & PROFILE PRIOR TO ACTUAL EXECUTION IN SITE.
- 8. LAYING, COMPACTION & EXTENT OF BACKFILL BEHIND SIDE WALL & RETAINING WALLS SHALL CONSIST OF SELECTED EARTH CONFIRMING TO THE APPENDIX-6 OF IRC:78-2014 HAVING PROPERTIES C=0, ϕ >=30 $^{\circ}$ & DENSITY=20KN/m 3 .
- 9. WEEP HOLES ON THE ABUTMENT & RETAINING WALLS SHALL BE SPACED 1000 c/c HORIZANTALY & VERTICALLY IN STAGGERED MANNER FROM 500MM ABOVE LWL.
- 10. SOFT AND LOOSE PATCHES IN THE BEARING AREA ARE TO BE REPLACED BY COMPACTED GRANULAR FILLS WITH LAYERS NOT EXCEEDING 300MM.
- 11. COMPRESSIBLE FILLER BOARD SHALL BE PROVIDED IN ALL EXPANSION GAPS AND SEALED WITH POLY-SULPHIDE SEALANT.

CLIENT :

NATIONAL HIGHWAYS AND INFRASTRUCTURE
DEVELOPMENT CORPORATION LTD.

(MINISTRY OF ROAD TRANSPORT AND HIGHWAYS)
GOVERNMENT OF INDIA

PROJECT:

CONSULTANCY SERVICES FOR PREPARATION OF DETAILED PROJECT REPORT FOR DEVELOPMENT OF ECONOMIC CORRIDORS, INTER CORRIDORS AND FEEDER ROUTES TO IMPROVE THE EFFICIENCY OF FREIGHT MOVEMENTS IN INDIA UNDER BHARATMALA PARIYOJANA (LOT-1:PACKAGE II) DESIGN CONSULTANT:

VOYANTS SOLUTIONS PVT LTD.
403, 4th Floor, Park Centra,
Sector-30, NH-8
Gurugram-122001, Haryana, India
CIN- U74140HR2004PTC046918
Ph: 0124-4598200, Fax: 0124-4019051,
E-mail: info@voyants.in, www.voyants.in


	Detailed Project Report		DESIGNED BY	DRAWN BY	CHECKED BY	APPROVED BY	
٠.				SLM	G.Das	MK	SKC
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	REV.	DATE	DESCRIPTION	SCALE:	AS SHOWN	SHEET SIZE	A2


TITLE:
GENERAL ARRANGEMENT DRAWING OF
DOUBLE CELL BOX TYPE MINOR BRIDGE

(TYPICAL)

 DRG. No. :
 VSPL/1718-081/DPR/PKG-4/NH-515/SEC-3/MNB-10 (Sht. 1 of 2)

 REVISION:
 R1
 January, 2023

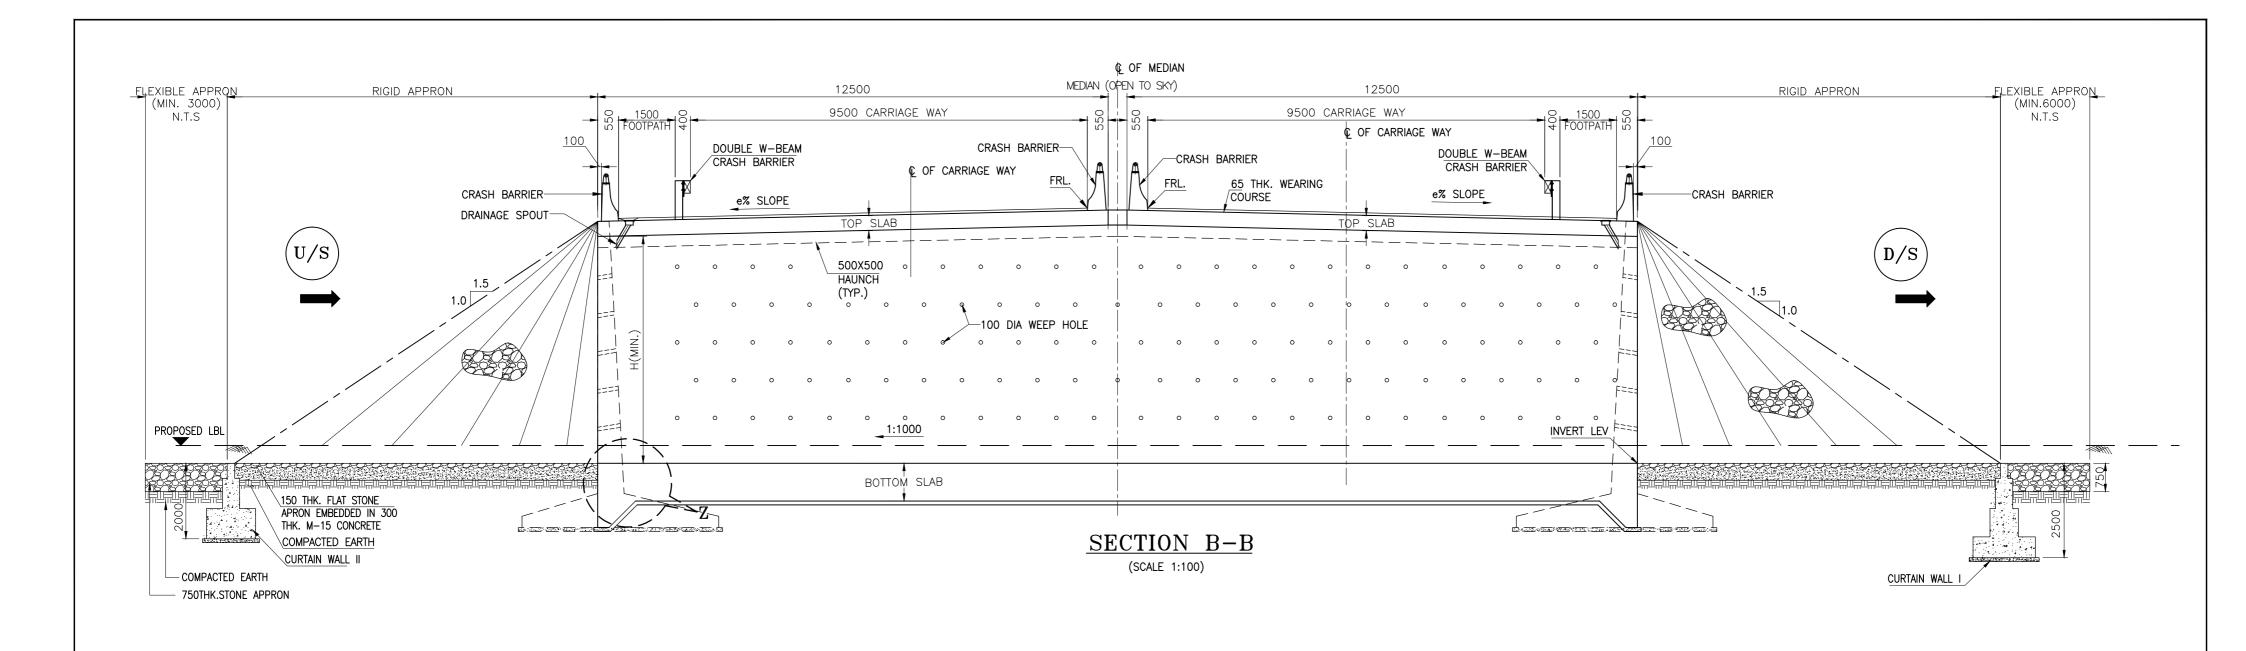

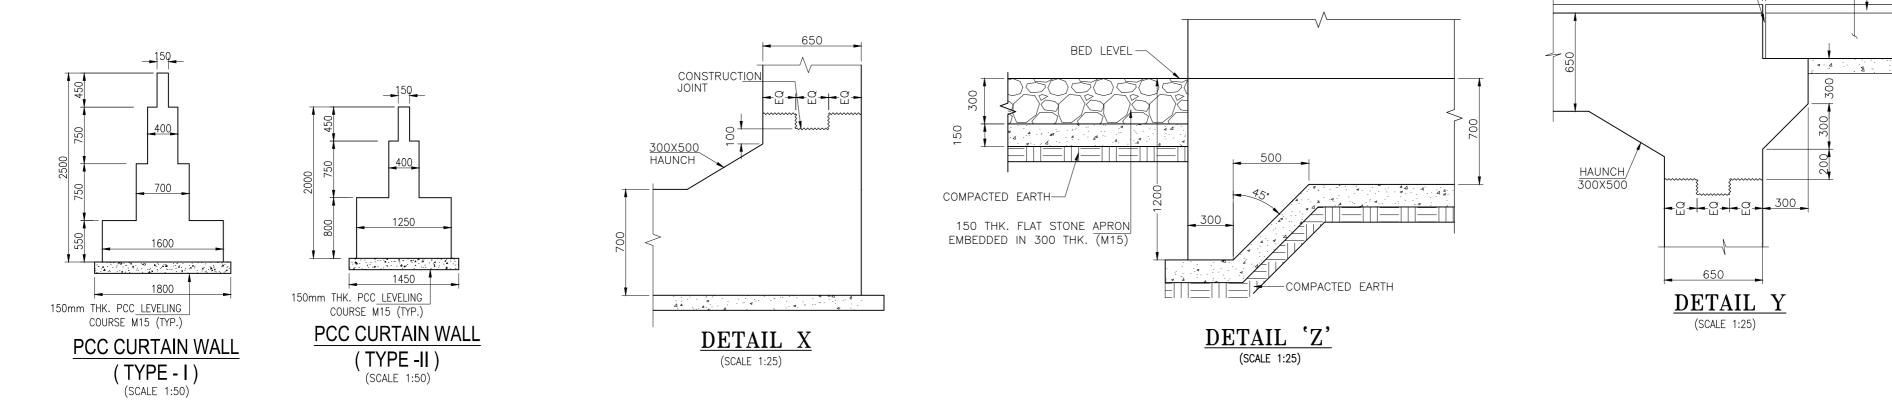

15mm THICK

COMPRESSIBLE FIBER-BOARD TYPE

20 GAP

1. ALL DIMENSIONS ARE IN MM AND LEVELS ARE IN M UNLESS MENTIONED OTHERWISE.

300 THK. APPROACH SLAB

---WEARING COAT

- 2. DIMENSIONS ARE NOT TO BE SCALED, ONLY WRITTEN DIMENSIONS ARE TO BE FOLLOWED.
- 3. FOR KEY PLAN, PROPOSED CHAINAGE & LOCATION REFER RELEVANT HIGHWAY DRAWING.





NATIONAL HIGHWAYS AND INFRASTRUCTURE
DEVELOPMENT CORPORATION LTD.
(MINISTRY OF ROAD TRANSPORT AND HIGHWAYS)
GOVERNMENT OF INDIA

PROJECT :

CONSULTANCY SERVICES FOR PREPARATION OF DETAILED PROJECT REPORT FOR DEVELOPMENT OF ECONOMIC CORRIDORS, INTER CORRIDORS AND FEEDER ROUTES TO IMPROVE THE EFFICIENCY OF FREIGHT MOVEMENTS IN INDIA UNDER BHARATMALA PARIYOJANA (LOT-1:PACKAGE II)

DESIGN CONSULTANT:


VOYANTS SOLUTIONS PVT LTD.
403, 4th Floor, Park Centra,
Sector-30, NH-8
Gurugram-122001, Haryana, India
CIN- U74140HR2004PTC046918
Ph: 0124-4598200, Fax: 0124-4019051,
E-mail: info@voyants.in, www.voyants.in


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вү	TITLE :
	GENERAL ARRANGEMENT DRAWING C
	DOUBLE CELL BOX TYPE MINOR BRIDG


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PRG. No. :
SPL/1718-081/DPR/PKG-4/NH-515/SEC-3/N

DRG. No. :		
SPL/1718-081/DF	PR/PKG-4/NH-515/	SEC-3/MNB-10 (Sht. 1 of
REVISION:	R1	January 2023



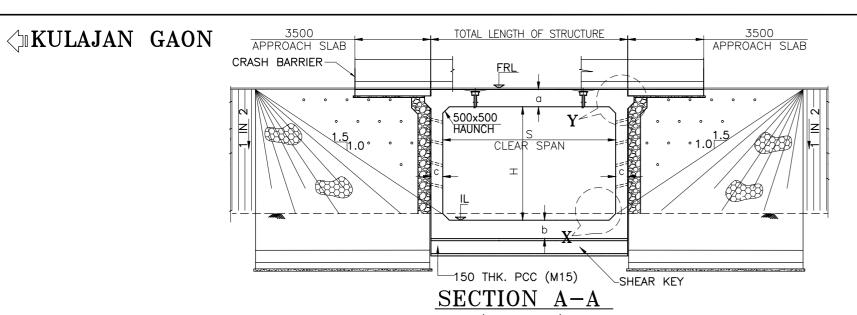

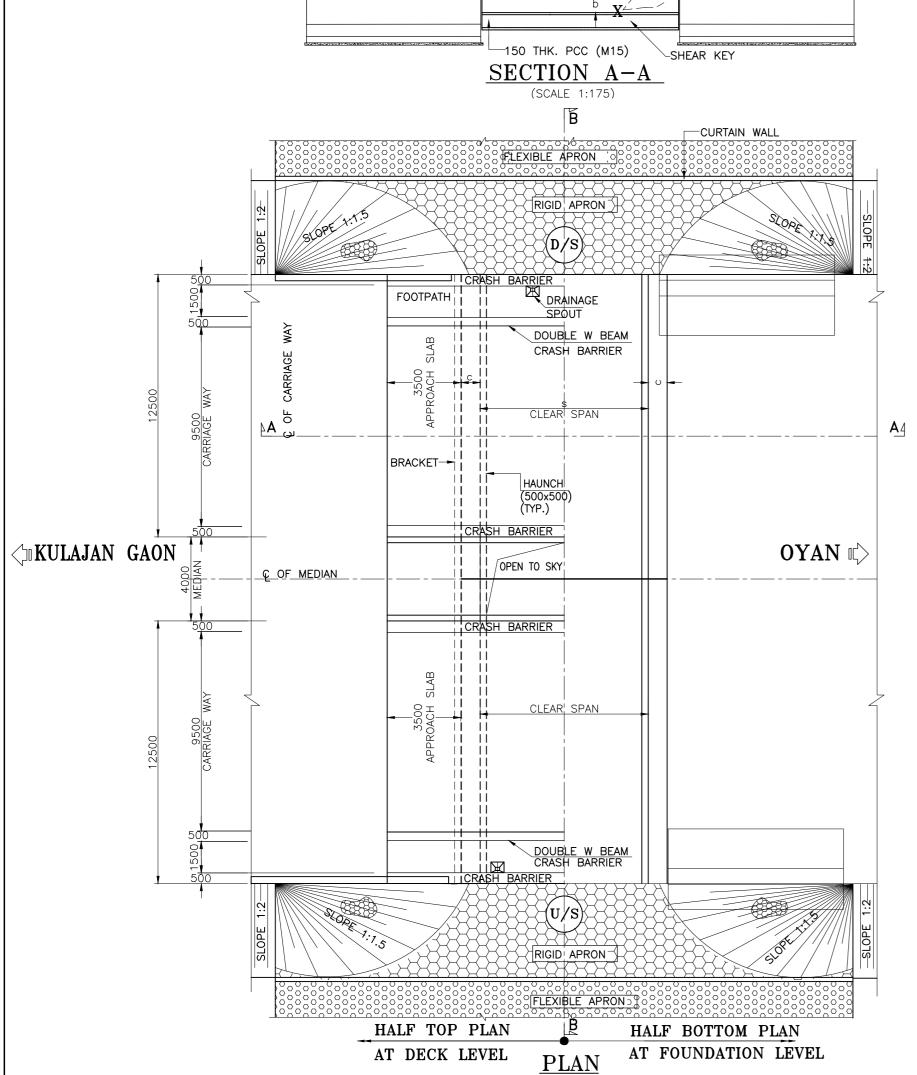	Structure List: NH-515_PKG-3													
	Proposal						Box data			CLEAR				
SI. No.	Doolers	Name of Stream	Category of Structure	Improvement Proposal	Span Arrangement (m)	Total Length (m)	Total Width (m)	Type of Superstructure	Top Slab (a) m	Bottom Slab (b) m	Side Wall (C) m	Middle Wall (d) m	HEIGHT - (H)	FRL m
1	69+570	Amarpur	MNB	New 2Lane on	3 x 7.5	22.5	2x12.5	RCC Box	0.750	0.850	0.650		4.500	122.219

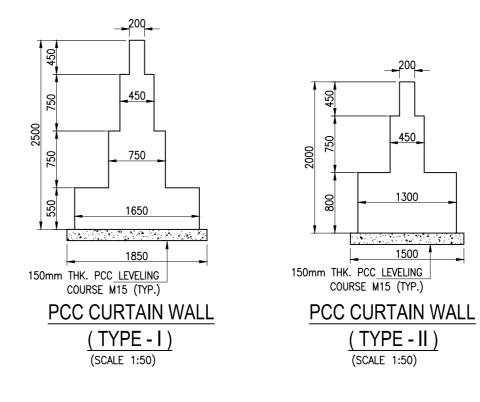

- ALL DIMENSIONS ARE IN MM AND LEVELS ARE IN M UNLESS MENTIONED OTHERWISE.
- 2. DIMENSIONS ARE NOT TO BE SCALED, ONLY WRITTEN DIMENSIONS ARE TO BE FOLLOWED.
- FOR KEY PLAN, PROPOSED CHAINAGE & LOCATION REFER RELEVANT HIGHWAY DRAWING.
- 4. GRADE OF CONCRETE USED:
- a) RCC BOX, RETURN WALLM3
- b) CRASH BARRIER.....
- c) APPROACH SLAB......M
- d) PCC LEVELLING COURSE......M15
- 5. ALL REINFORCEMENT STEEL SHALL BE HIGH STRENGTH DEFORMED BARS OF GRADE Fe500 CONFORMING TO IS: 1786-1985
- 6. THE STRUCTURE IS DESIGNED TO CATER LIVE LOAD COMBINATION OF 3-LANES OF CLASS A OR 1-LANE OF 70R WHILE + 1 LANE A OR IRC SV WHICHEVER PRODUCE
- 7. VARIOUS LEVELS (FRL,EGL) & SUPER ELEVATIONS SHOWN IN DRAWINGS SHALL BE VERIFIED WITH THE HIGHWAY PLAN & PROFILE PRIOR TO ACTUAL EXECUTION IN SITE.
- 8. LAYING, COMPACTION & EXTENT OF BACKFILL BEHIND ABUTMENT & RETAINING WALLS SHALL CONSIST OF SELECTED EARTH CONFIRMING TO THE APPENDIX-6 OF IRC:78-2014 HAVING PROPERTIES C=0, Ø≥=30° & DENSITY=20KN/m³.
- 9. WEEP HOLES ON THE ABUTMENT & RETAINING WALLS SHALL BE SPACED 1000 c/c HORIZANTALY & VERTICALLY IN STAGGERED MANNER FROM 500MM ABOVE LWL TO HFL.
- 10. SOFT AND LOOSE PATCHES IN THE BEARING AREA ARE TO BE REPLACED BY COMPACTED GRANULAR FILLS WITH LAYERS NOT EXCEEDING 300MM.
- 11. COMPRESSIBLE FILLER BOARD SHALL BE PROVIDED IN ALL EXPANSION GAPS AND SEALED WITH POLY—SULPHIDE SEALANT.

CLIENT :



NATIONAL HIGHWAYS AND INFRASTRUCTURE
DEVELOPMENT CORPORATION LTD.
(MINISTRY OF ROAD TRANSPORT AND HIGHWAYS)
GOVERNMENT OF INDIA

PROJECT :

CONSULTANCY SERVICES FOR PREPARATION OF DETAILED PROJECT REPORT FOR DEVELOPMENT OF ECONOMIC CORRIDORS, INTER CORRIDORS AND FEEDER ROUTES TO IMPROVE THE EFFICIENCY OF FREIGHT MOVEMENTS IN INDIA UNDER BHARATMALA PARIYOJANA (LOT-1:PACKAGE II)

(SCALE 1:175)

DESIGN CONSULTANT:

VOYANTS SOLUTIONS PVT LT
403, 4th Floor, Park Centra,
Sector-30, NH-8
Gurugram-122001, Haryana, India
CIN- U74140HR2004PTC046918
Ph: 0124-4598200, Fax: 0124-4019051,
E-mail: info@voyants.in, www.voyants.in

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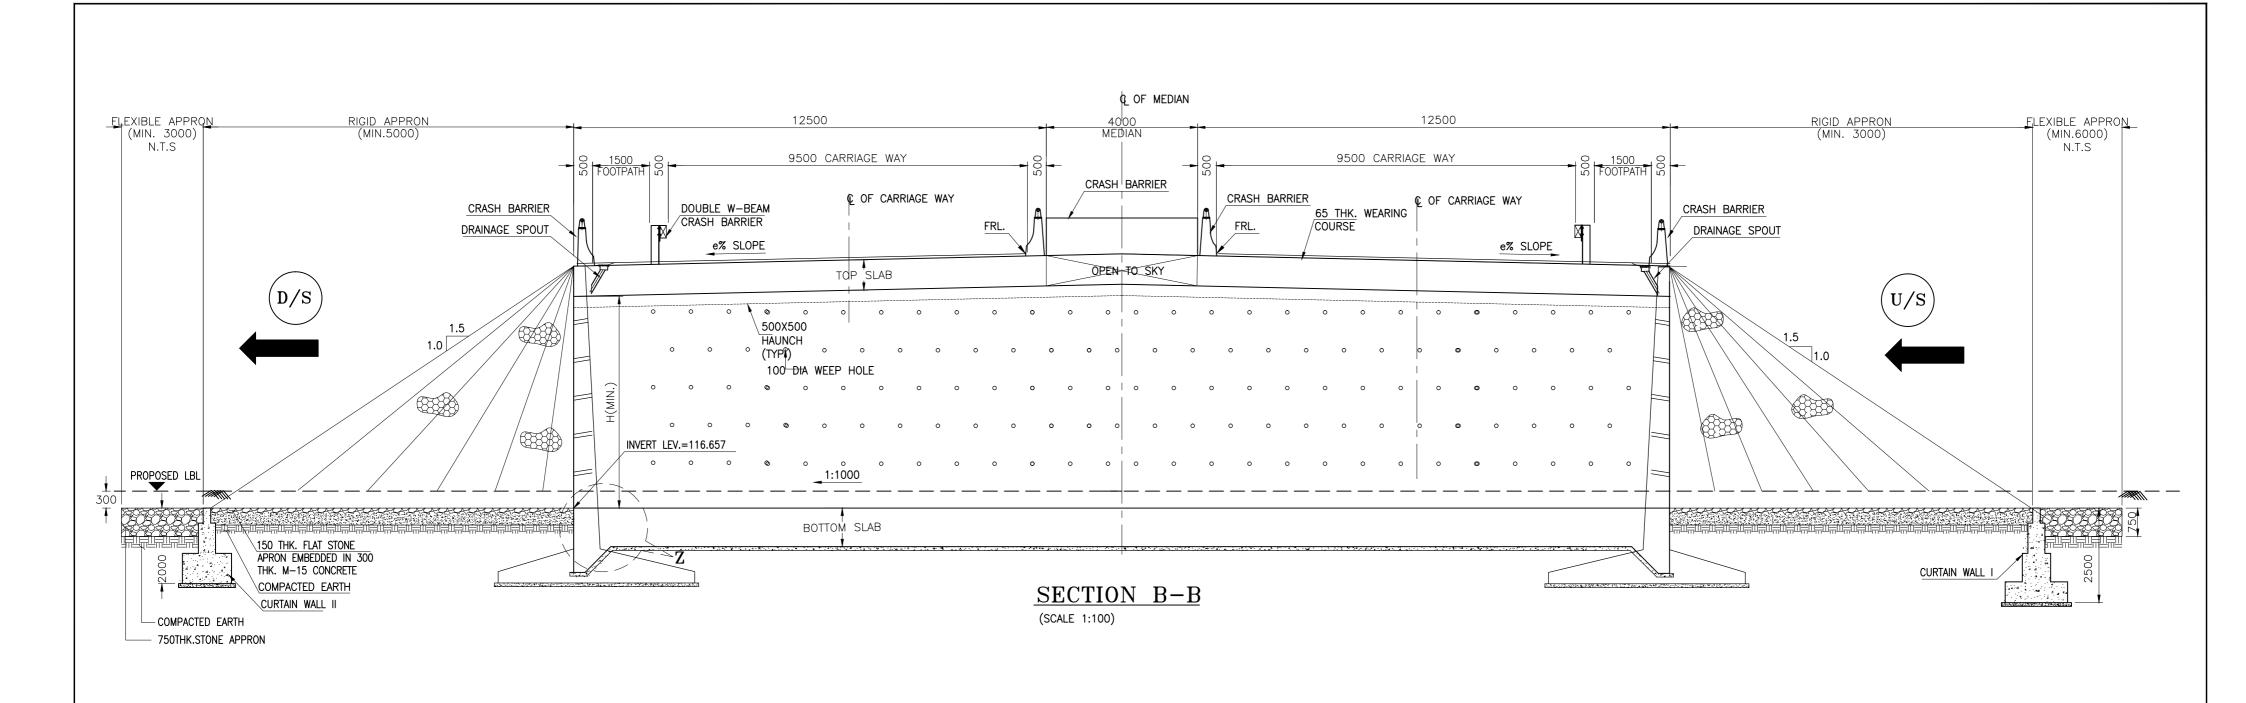
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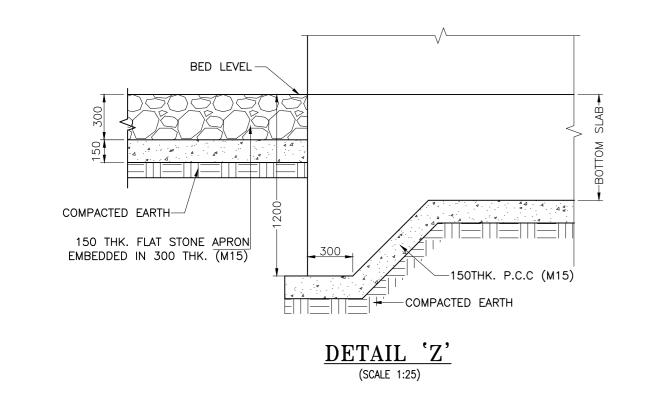
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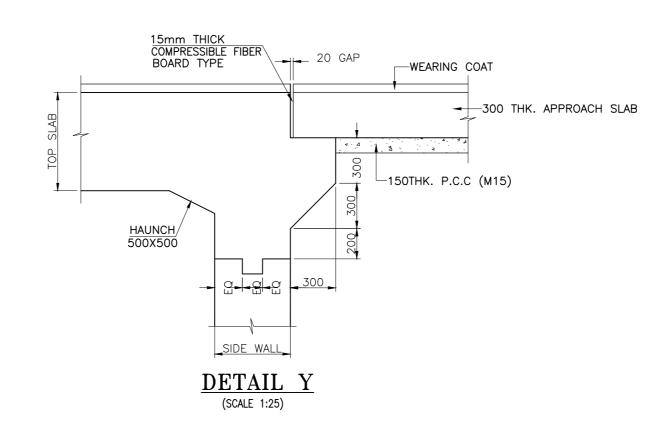
GENERAL ARRANGEMENT DRAWING OF SINGLE CELL BOX TYPE MINOR BRIDGE (TYPICAL)


DC No.

DRG. No. :
| VSPL/1718-081/DPR/PKG-4/NH-515/SEC-3/MNB-11(Sht. 1 of 2)
| REVISION: R1 January, 2023







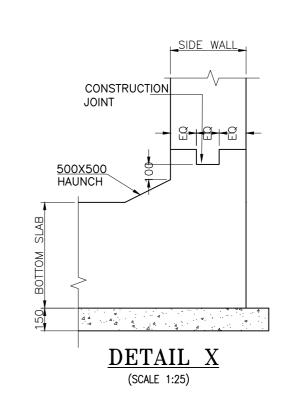

- ALL DIMENSIONS ARE IN MM AND LEVELS ARE IN M UNLESS MENTIONED OTHERWISE.

 OTHERWISE.
- 2. DIMENSIONS ARE NOT TO BE SCALED, ONLY WRITTEN DIMENSIONS ARE TO BE FOLLOWED.
- 3. FOR KEY PLAN, PROPOSED CHAINAGE & LOCATION REFER RELEVANT HIGHWAY DRAWING.

CLIENT:



NATIONAL HIGHWAYS AND INFRASTRUCTURE
DEVELOPMENT CORPORATION LTD.
(MINISTRY OF ROAD TRANSPORT AND HIGHWAYS)
GOVERNMENT OF INDIA

PROJECT:

CONSULTANCY SERVICES FOR PREPARATION OF DETAILED PROJECT REPORT FOR DEVELOPMENT OF ECONOMIC CORRIDORS, INTER CORRIDORS AND FEEDER ROUTES TO IMPROVE THE EFFICIENCY OF FREIGHT MOVEMENTS IN INDIA UNDER BHARATMALA PARIYOJANA (LOT-1:PACKAGE II) DESIGN CONSULTANT:

VOYANTS SOLUTIONS PVT LTD.


403, 4th Floor, Park Centra,
Sector-30, NH-8


403, 4th Floor, Park Centra, Sector-30, NH-8 Gurugram-122001, Haryana, India CIN- U74140HR2004PTC046918 Ph: 0124-4598200, Fax: 0124-4019051, E-mail: info@voyants.in, www.voyants.in


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		SV		K	
	REV. DATE DESCRIPTION	SCALE :	AS SHOWN	SHEET SIZE	A2


TITLE:
GENERAL ARRANGEMENT DRAWING OF
SINGLE CELL BOX TYPE MINOR BRIDGE
(TYPICAL)


DRG. No. :
| VSPL/1718-081/DPR/PKG-4/NH-515/SEC-3/MNB-11(Sht. 2 of 2)
| REVISION: R1 January, 2023

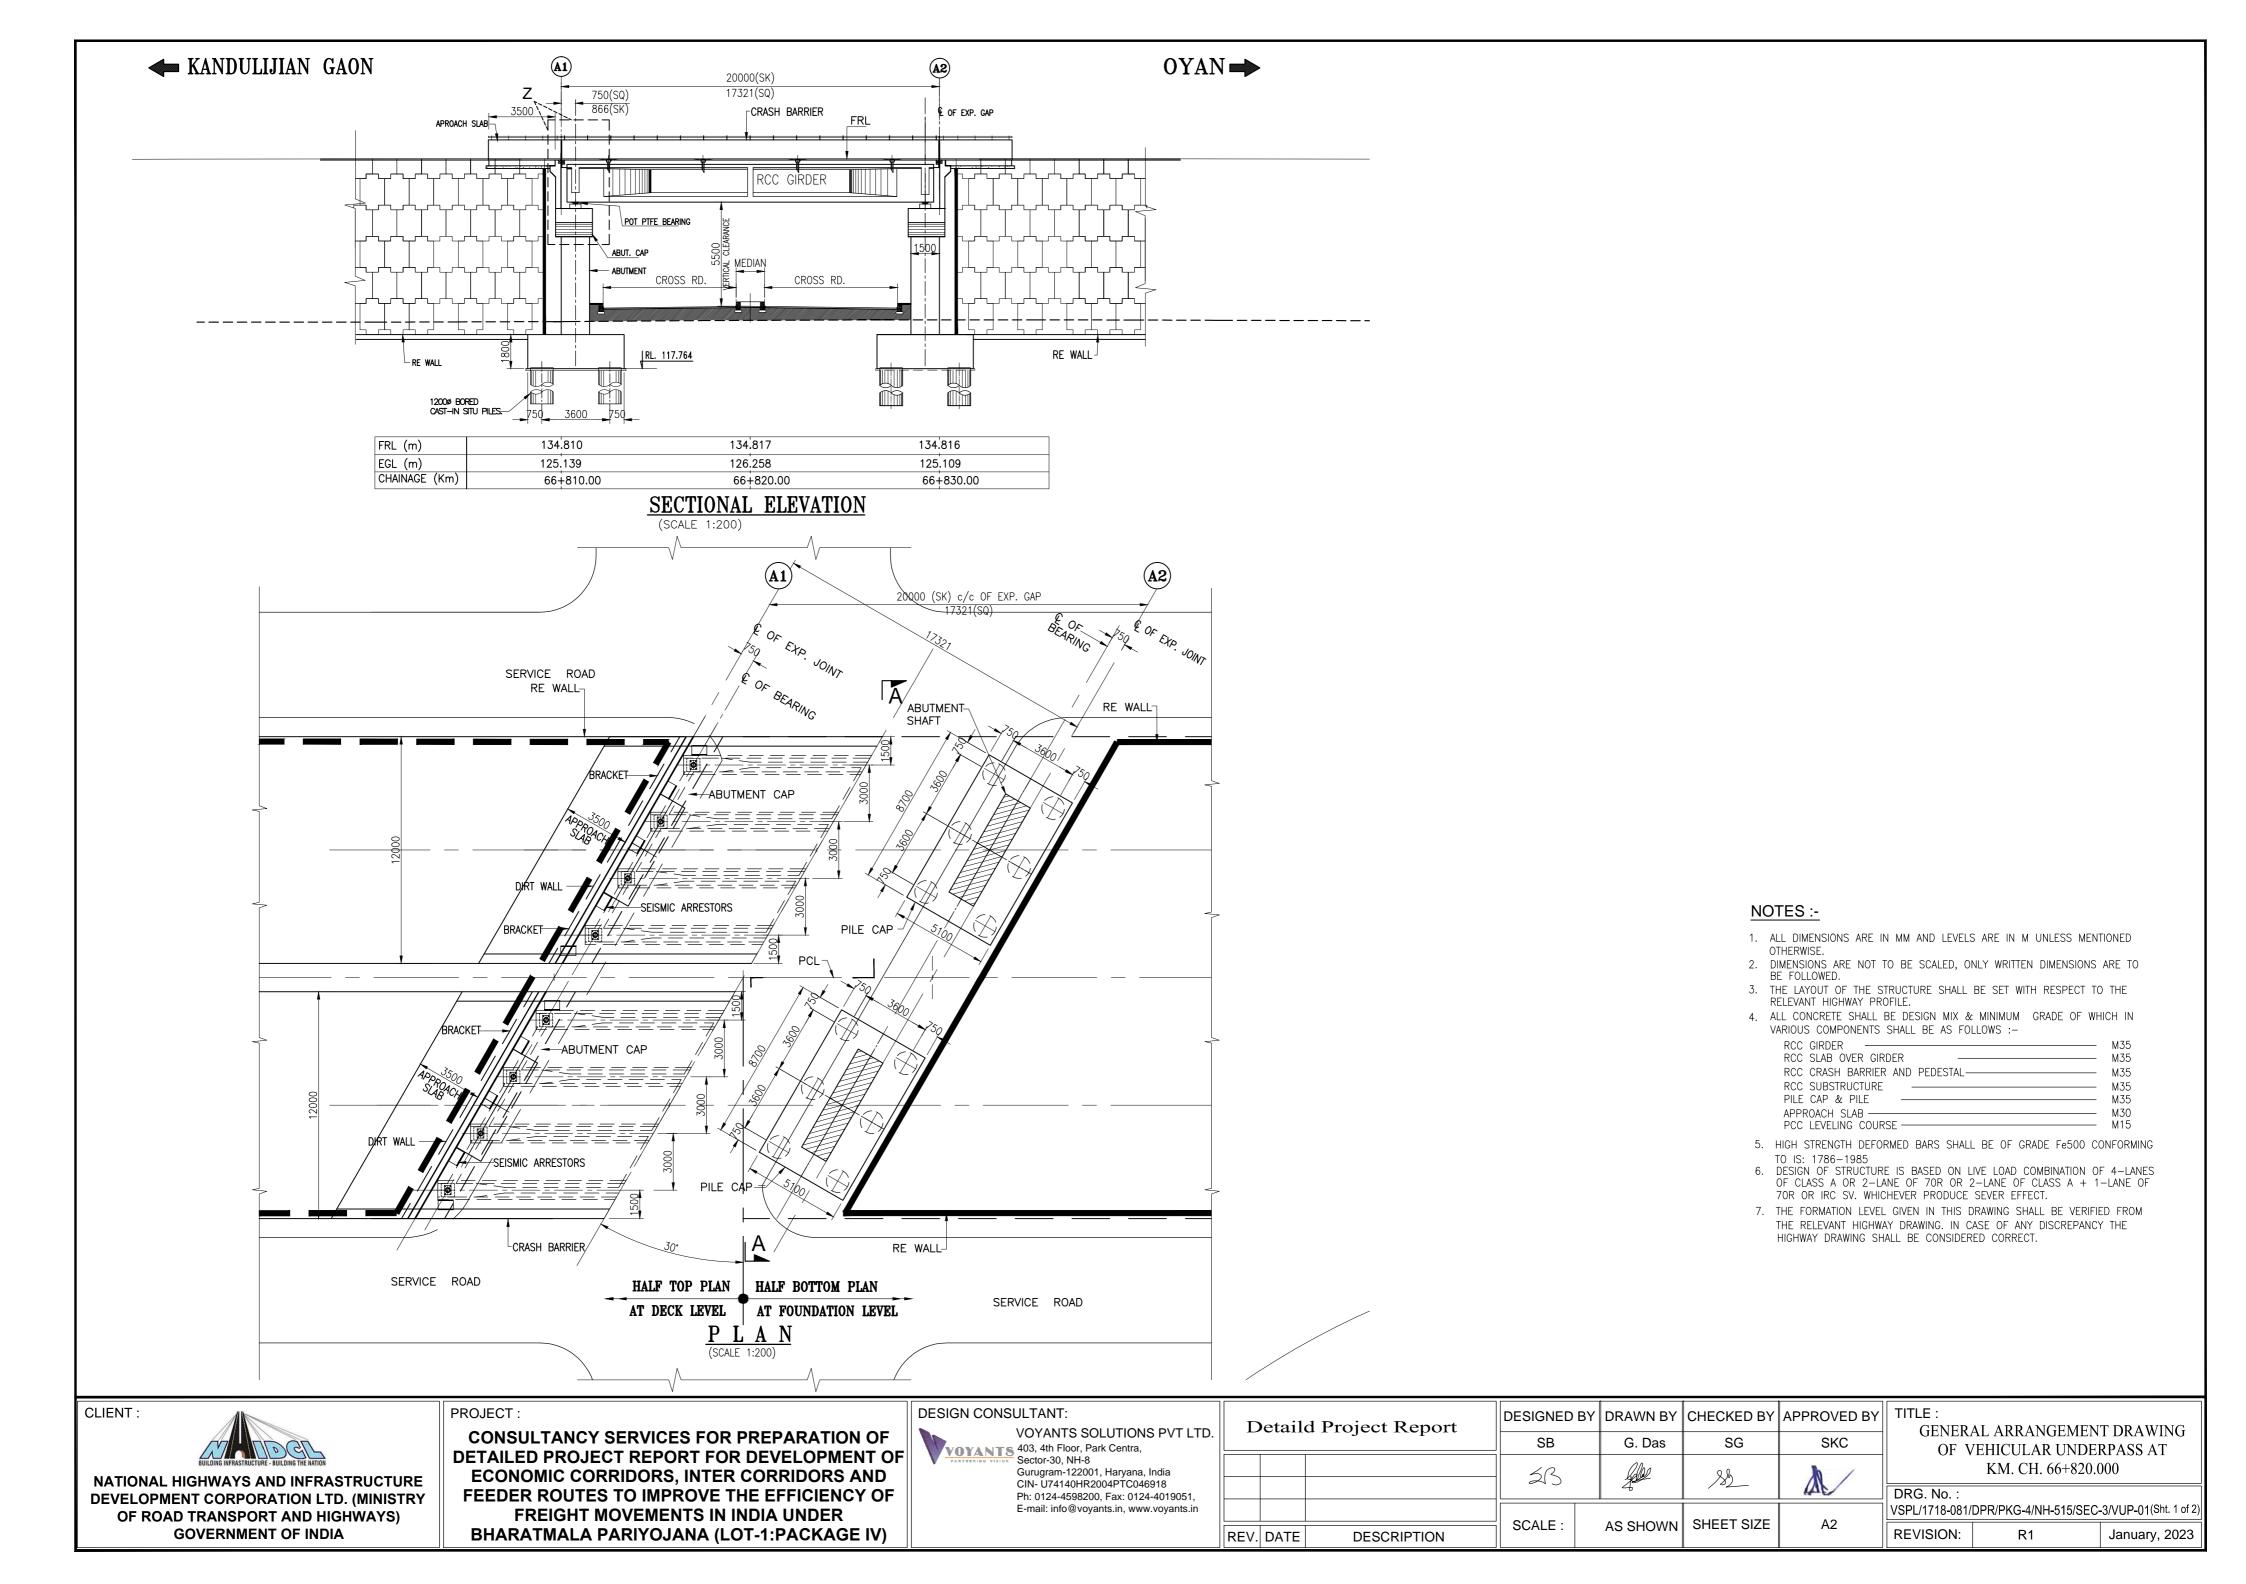

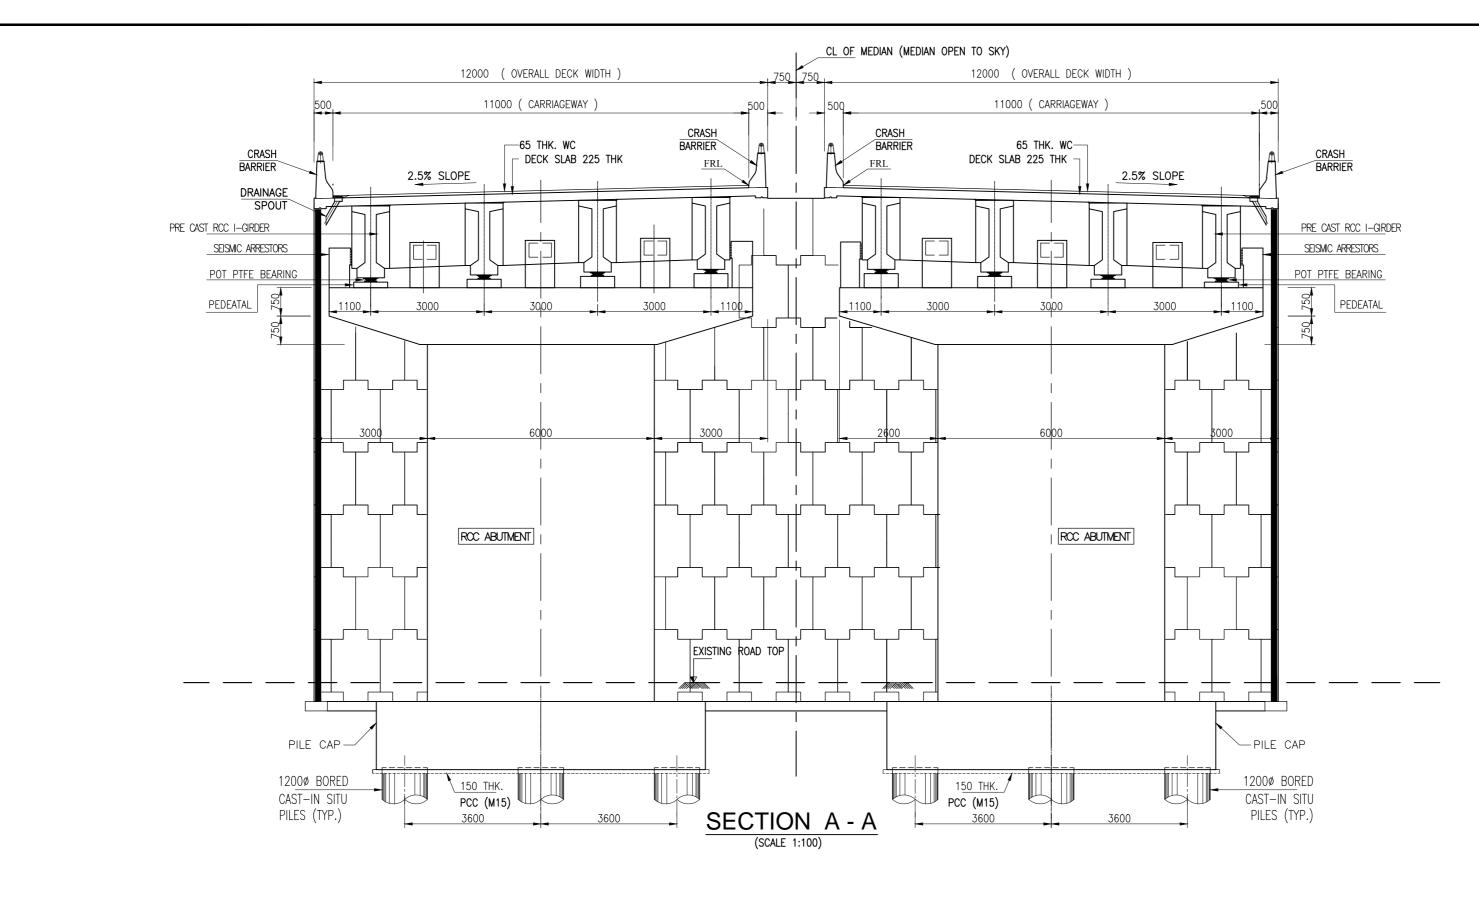

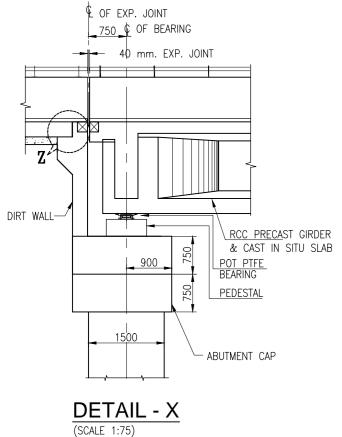

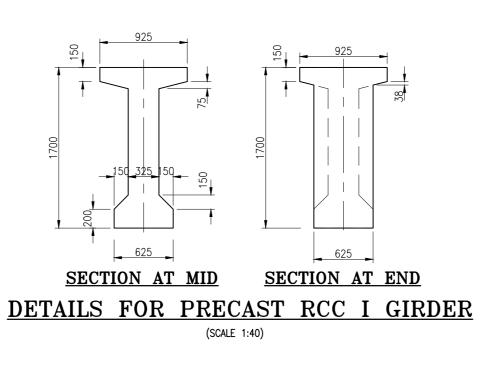

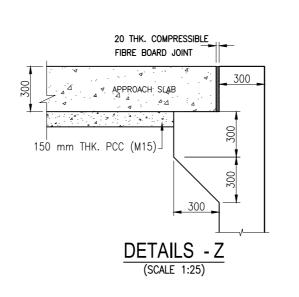

NOTES:

- ALL DIMENSIONS ARE IN MILLIMETRES UNLESS OTHERWISE STATED.
- 2. DIMENSIONS ARE NOT TO BE SCALED. ONLY WRITTEN DIMENSIONS SHALL BE FOLLOWED.

CLIENT:



NATIONAL HIGHWAYS AND INFRASTRUCTURE DEVELOPMENT CORPORATION LTD. (MINISTRY OF ROAD TRANSPORT AND HIGHWAYS) GOVERNMENT OF INDIA PROJECT:


CONSULTANCY SERVICES FOR PREPARATION OF DETAILED PROJECT REPORT FOR DEVELOPMENT OF ECONOMIC CORRIDORS, INTER CORRIDORS AND FEEDER ROUTES TO IMPROVE THE EFFICIENCY OF FREIGHT MOVEMENTS IN INDIA UNDER BHARATMALA PARIYOJANA (LOT-1:PACKAGE IV)


	DESIGN CONSULTANT:
	VOYANTS SOLUTIONS PVT LTD
l	VOYANTS 403, 4th Floor, Park Centra,
l	PARTNERING VISION Sector-30, NH-8
l	Gurugram-122001, Haryana, India
l	CIN- U74140HR2004PTC046918
l	Ph: 0124-4598200, Fax: 0124-4019051,
۱	E-mail: info@voyants.in, www.voyants.in


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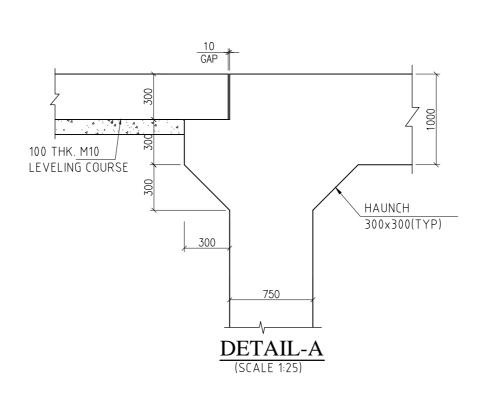
Υ	TITLE:
\dashv	GENERAL ARRANGEMENT DRAWING
	OF VEHICULAR UNDERPASS AT
	KM. CH. 66+820.000

DRG. No.:		
VSPL/1718-081/	DPR/PKG-4/NH-515/SEC	-3/VUP-01(Sht. 1 of 2)
REVISION:	R1	January, 2023



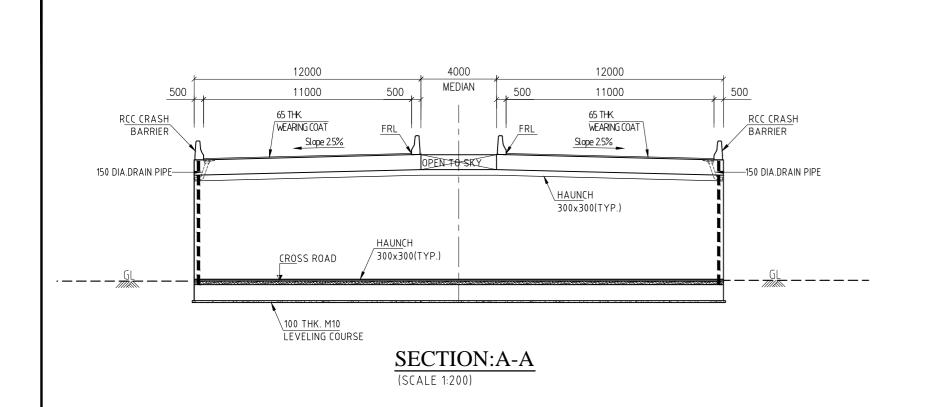

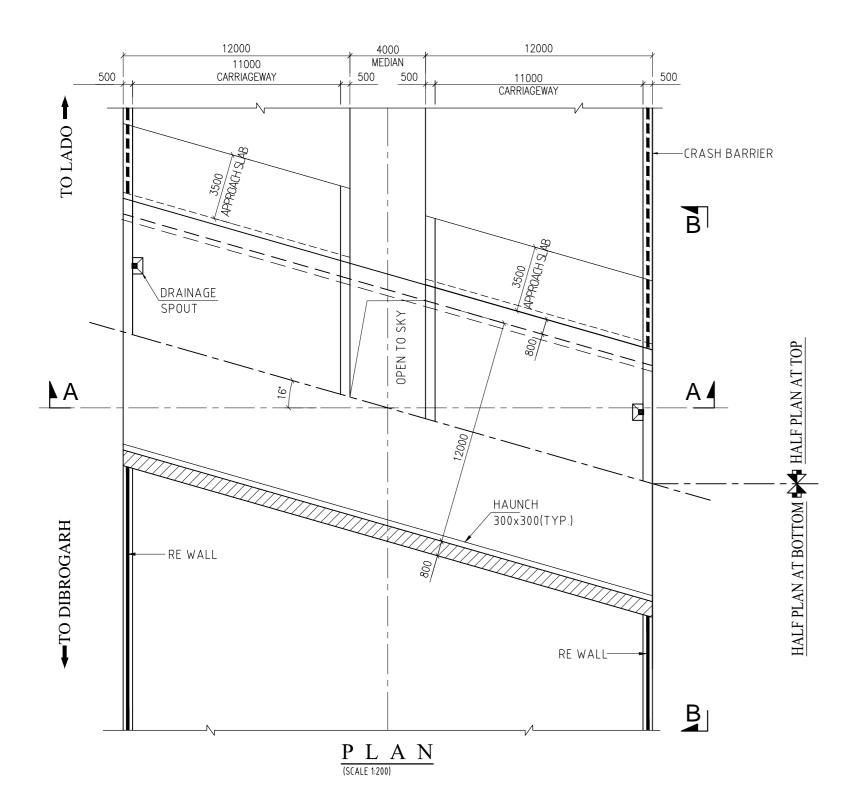

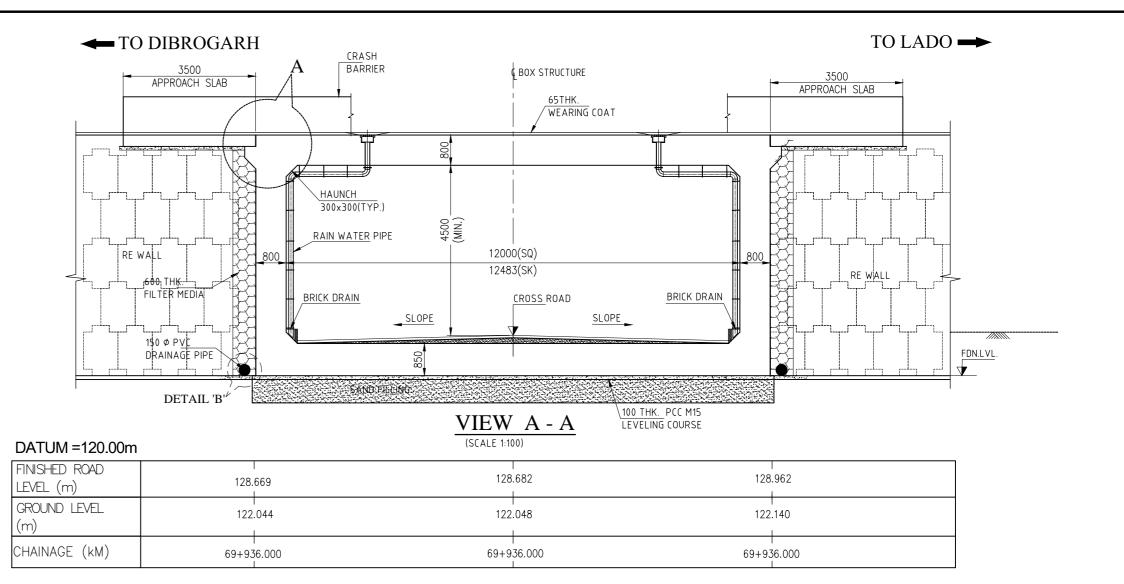

- 1. ALL DIMENSIONS ARE IN MM AND LEVELS ARE IN M UNLESS MENTIONED OTHERWISE.
- 2. DIMENSIONS ARE NOT TO BE SCALED, ONLY WRITTEN DIMENSIONS ARE TO BE FOLLOWED.
- 3. FOR KEY PLAN, PROPOSED CHAINAGE & LOCATION REFER RELEVANT HIGHWAY DRAWING.
- 4. GRADE OF CONCRETE USED: a) RCC BOX, RETURN WALL
- b) CRASH BARRIER. c) APPROACH SLAB.
- d) PCC LEVELLING COURSE. ..M15
- 5. ALL REINFORCEMENT STEEL SHALL BE HIGH STRENGTH DEFORMED BARS OF GRADE Fe500 CONFORMING TO IS: 1786-1985
- 6. THE STRUCTURE IS DESIGNED TO CATER LIVE LOAD COMBINATION OF 3-LANES OF CLASS A OR 1-LANE OF 70R WHILE + 1 LANE A OR IRC SV WHICHEVER PRODUCE
- 7. VARIOUS LEVELS (FRL,EGL) & SUPER ELEVATIONS SHOWN IN DRAWINGS SHALL BE VERIFIED WITH THE HIGHWAY PLAN & PROFILE PRIOR TO ACTUAL EXECUTION IN SITE.
- 8. LAYING, COMPACTION & EXTENT OF BACKFILL BEHIND ABUTMENT & RETAINING WALLS SHALL CONSIST OF SELECTED EARTH CONFIRMING TO THE APPENDIX-6 OF IRC:78-2014 HAVING PROPERTIES C=0, Ø>=30° & DENSITY=20KN/m.
- 9. WEEP HOLES ON THE ABUTMENT & RETAINING WALLS SHALL BE SPACED 1000 c/c HORIZANTALY & VERTICALLY IN STAGGERED MANNER FROM 500MM ABOVE LWL TO HFL.
- 10. SOFT AND LOOSE PATCHES IN THE BEARING AREA ARE TO BE REPLACED BY COMPACTED GRANULAR FILLS WITH LAYERS NOT EXCEEDING 300MM.
- 11. COMPRESSIBLE FILLER BOARD SHALL BE PROVIDED IN ALL EXPANSION GAPS AND SEALED WITH POLY-SULPHIDE SEALANT.

LEGENDS:

- SQ SQUAIRE
- SK. SKEW
- FRL FORMATION LEVEL

CLIENT:

NATIONAL HIGHWAYS AND INFRASTRUCTURE **DEVELOPMENT CORPORATION LTD. (MINISTRY** OF ROAD TRANSPORT AND HIGHWAYS) **GOVERNMENT OF INDIA**

PROJECT:

CONSULTANCY SERVICES FOR PREPARATION OF DETAILED PROJECT REPORT FOR DEVELOPMENT OF **ECONOMIC CORRIDORS, INTER CORRIDORS AND** FEEDER ROUTES TO IMPROVE THE EFFICIENCY OF FREIGHT MOVEMENTS IN INDIA UNDER BHARATMALA PARIYOJANA (LOT-1:PACKAGE IV)

DESIGN CONSULTANT: VOYANTS SOLUTIONS PVT VOYANTS 403, 4th Floor, Park Centra, Sector-30, NH-8 Gurugram-122001, Haryana, India CIN- U74140HR2004PTC046918 Ph: 0124-4598200, Fax: 0124-4019051 E-mail: info@voyants.in, www.voyants.

LTD.	D	etail	d Project Report
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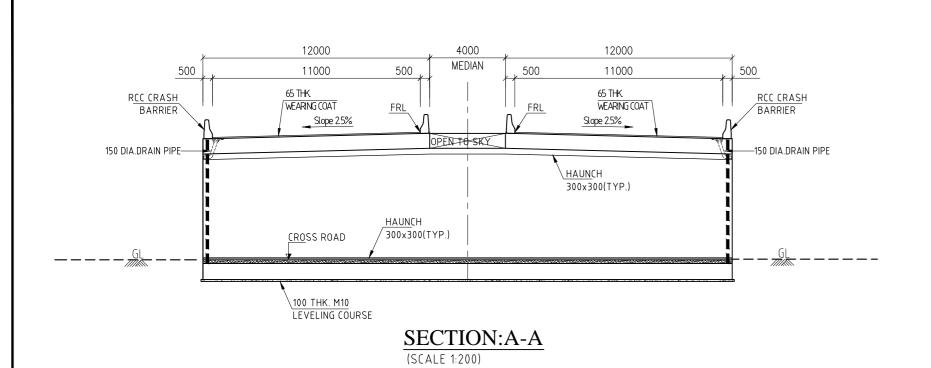
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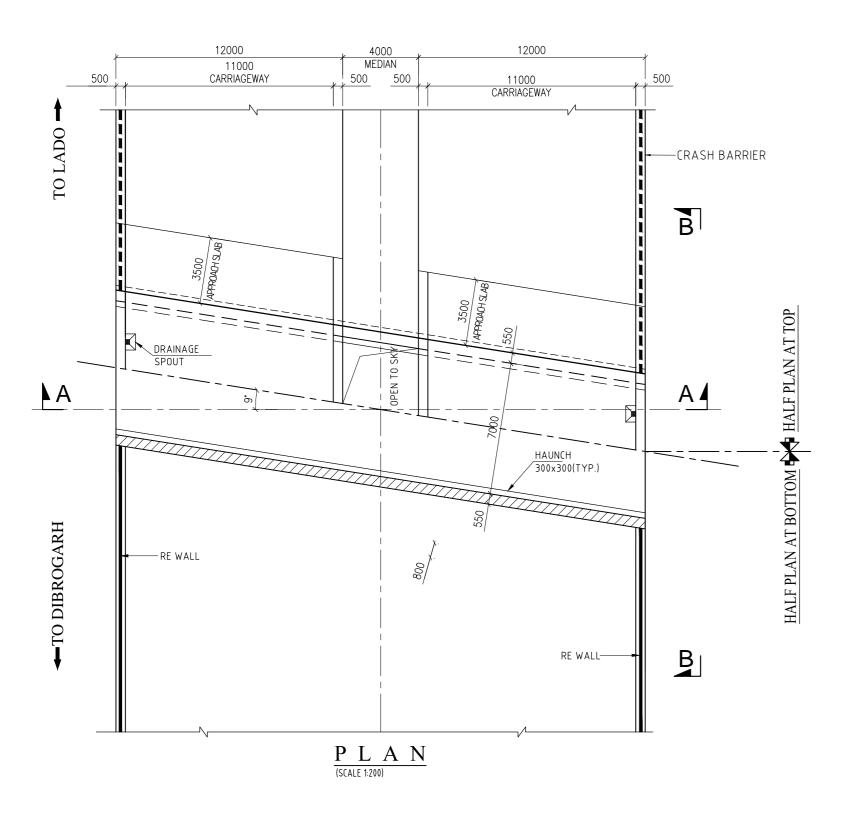
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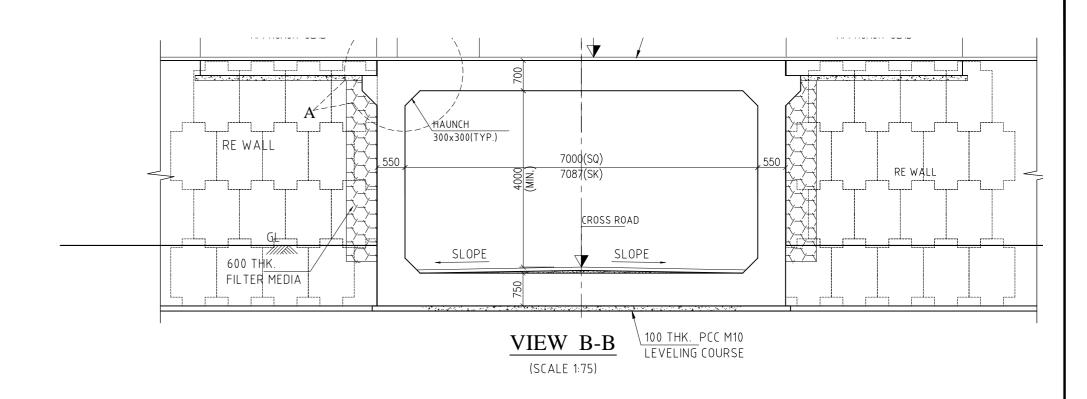
Г)etail	d Project Report	DESIGNED BY	DRAWN BY	CHECKED BY	APPROVED BY
		a rieject report	SB	G. Das	SG	SKC
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DEV	DATE	DECODIDATION	SCALE :	AS SHOWN	SHEET SIZE	A2

TITLE:
GENERAL ARRANGEMENT DRAWING OF LIGHT VEHICULAR UNDERPASS AT Ch. Km. 69+936.00 $(1 \times 12.0 \times 4.5)$

DRG. No. VSPL/1718-081/DPR/PKG-4/NH-515/SEC-3/LVUP-01 (Sht. 1 of 1 **REVISION:** January, 2023








DATUM =122.00m

FINISHED ROAD				
LEVEL (m)	129.777	129.779	129.779	

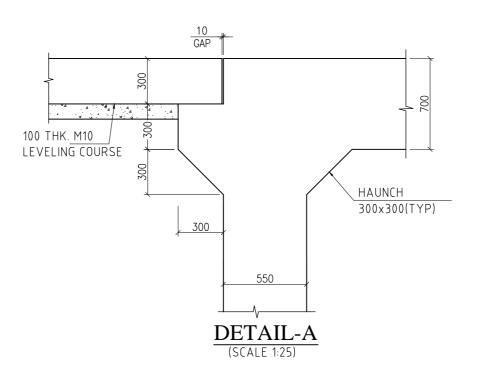

NOTES:-

- 1. ALL DIMENSIONS ARE IN mm, LEVELS ARE IN m. & CHAINAGE ARE IN KILOMETER + METER. UNLESS OTHERWISE SPECIFIED. ONLY WRITTEN DIMENSIONS SHALL BE FOLLOWED.
- 2. STRUCTURE LOCATION REFER TO THE CHAINAGE AT STRUCTURE CENTER AND LEVELS AT MEDIAN EDGE.
- 3. THIS DRAWING TO BE READ IN CONJUCTION TO THE HIGHWAY DRAWINGS. IF THERE IS ANY DIFFERENCE IN CHAINAGE OR LEVELS H/W DRAWINGS WILL PREVAIL.
- 5. THE STRUCTURE IS DESIGNED TO CATER TO MAXIMUM OF:-
 - ONE LANE, TWO LANE, THREE AND FOUR LANE OF CLASS A.
 - b. TWO LANE OF CLASS A IN ADDITION OF ONE LANE OF 70R WHEEL OR ONE LANE OF CLASS 70R TRACKED WHICHEVER IS GOVERNING
- 6. SEISMIC ZONE = III AS PER IRC:SP:114-2018 HAS BEEN CONSIDERED.
- 7. GRADE OF CONCRETE:-
- FOR RCC BOX... ...M35 FOR LEVELING COURSE ..M10 CRASH BARRIER. .M40 APPROACH SLAB..
- 7. GRADE OF STEEL SHALL BE Fe-500 CONFIRMING TO IS:1786.

- 8. ALL CONSTRUCTION SHALL CONFIRM TO CONTRACT SPECIFICATIONS.
- 9. COMPACTED EARTH SHOULD CONFORM TO CLAUSE 305.2.1.5 OF MORTH SPECIFICATIONS.
- 10. SOFT AND LOOSE PATCHES UNDER THE FOUNDING AREA ARE TO BE REPLACED BY COMPACTED GRANULAR FILLS WITH LAYERS NOT EXCEEDING 300mm.
- 11. BACKFILL GRANULAR SOIL MATERIAL BEHIND BOX STRUCTURE SHALL HAVE THE FOLLOWS PROPERTIES AS $.\gamma = 1800 \text{ Kg/M}^3 \text{ g C} = 0, \phi = 30^\circ$,
- 12. 600mm THICK. FILTER MATERIAL BEHIND BOX/RETAINING WALL SHALL BE LAID AS PER APPENDIX 6 OF IRC 78-2000.
- 13. THE STRUCTURE IS DESIGNED FOR NET SAFE BEARING CAPACITY OF 10.0 t/m² GROUND IMPROVEMENT UP TO 900mm BELOW THE FOUNDATION TO BE PROVIDED TO ACHIEVE REQUIRED SBC AS PER GEOTECH REPORT.
- 14. PERFORATED P.V.C. PIPE 150¢ TO BE PROVIDED OF GROUND LEVEL BEHIND WALL FOR

CLIENT:

NATIONAL HIGHWAYS AND INFRASTRUCTURE **DEVELOPMENT CORPORATION LTD. (MINISTRY** OF ROAD TRANSPORT AND HIGHWAYS) **GOVERNMENT OF INDIA**

PROJECT:

CONSULTANCY SERVICES FOR PREPARATION OF DETAILED PROJECT REPORT FOR DEVELOPMENT OF **ECONOMIC CORRIDORS, INTER CORRIDORS AND** FEEDER ROUTES TO IMPROVE THE EFFICIENCY OF FREIGHT MOVEMENTS IN INDIA UNDER BHARATMALA PARIYOJANA (LOT-1:PACKAGE IV)

DESIGN CONSULTANT: VOYANTS SOLUTIONS PVT LT

VOYANTS 403, 4th Floor, Park Centra, Sector-30, NH-8 Gurugram-122001, Haryana, India CIN- U74140HR2004PTC046918 Ph: 0124-4598200, Fax: 0124-4019051, E-mail: info@voyants.in, www.voyants.in


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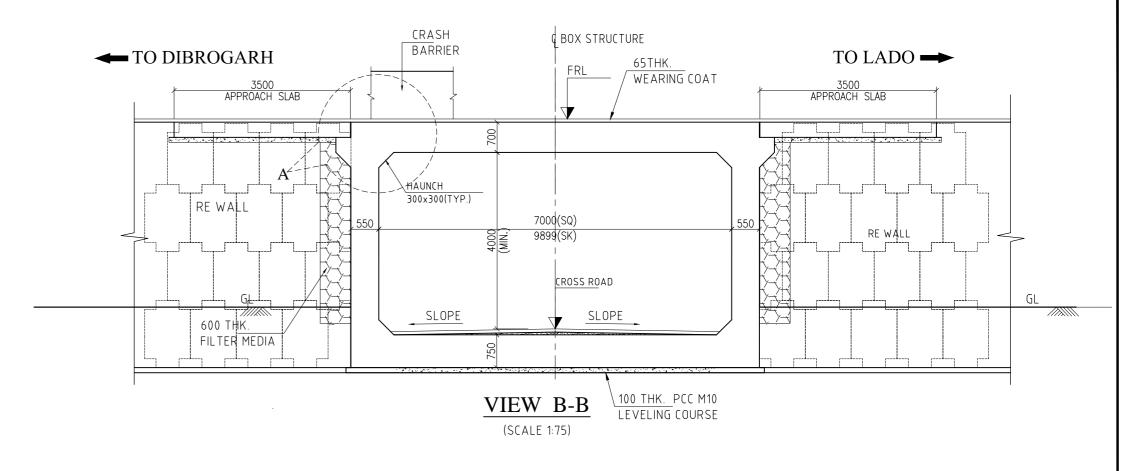
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in	DEV DATE DESCRIPTION	SCALE :	AS SHOWN	SHEET SIZE	A2	

GENERAL ARRANGEMENT DRAWING OF SMALL VEHICULAR UNDERPASS AT Ch. Km. 68+083.00 $(1 \times 7.0 \times 4.5)$


DRG. No. VSPL/1718-081/DPR/PKG-4/NH-515/SEC-3/SVUP-01(Sht. 1 of 1 **REVISION:** January, 2023



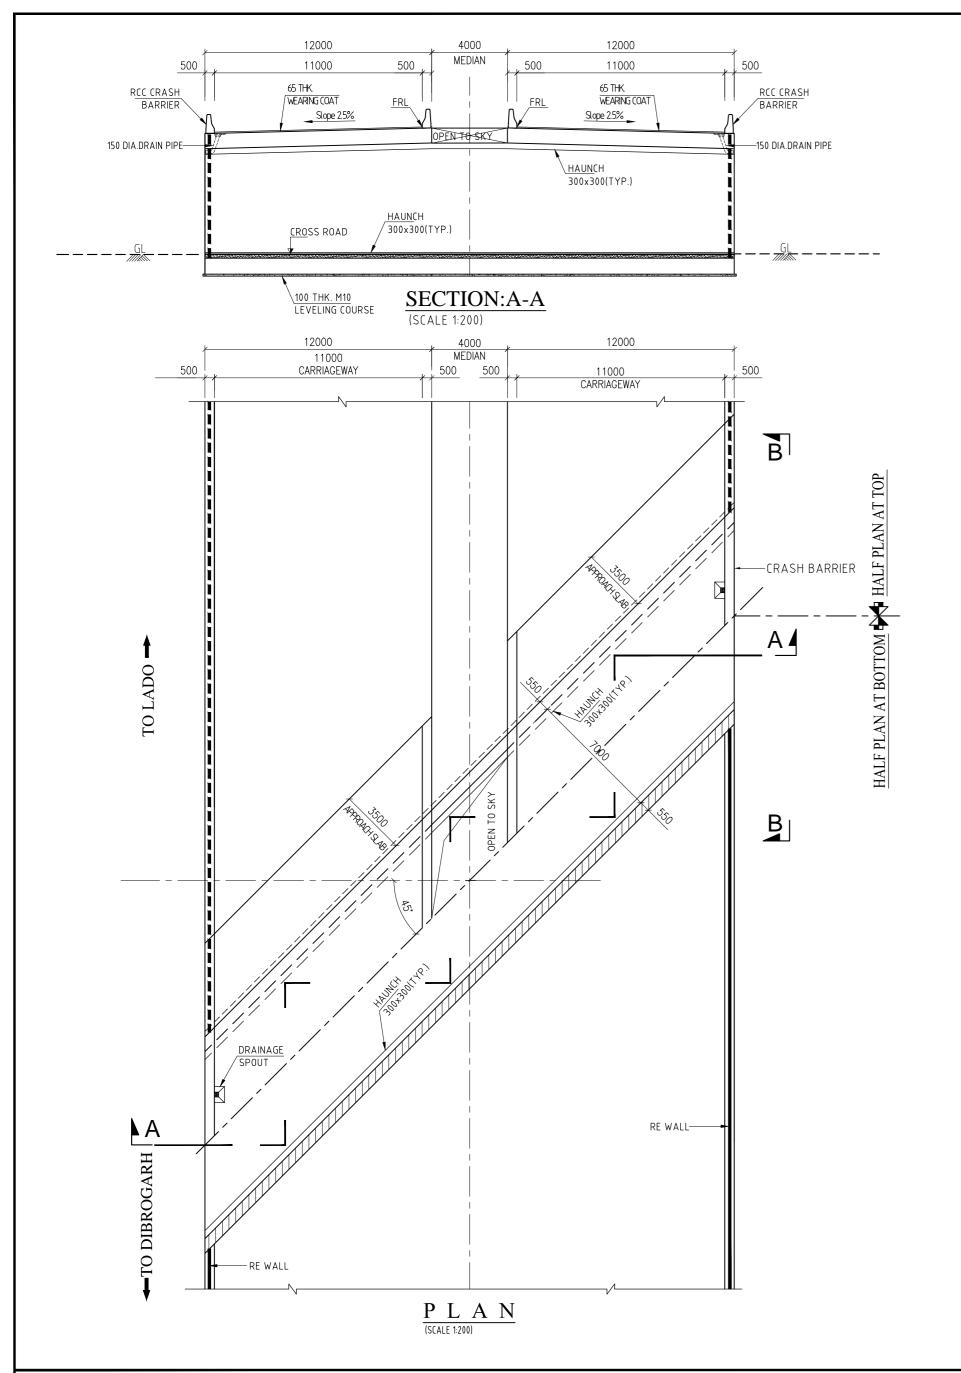

DATUM =123.00m

FINISHED ROAD LEVEL (m)	130.634	1 130.671	1 130.698	
GROUND LEVEL (m)	124.338	1 124.671	1 124.883	
CHAINAGE (kM)	70+803.180	70+807.260 I	70+811.310	

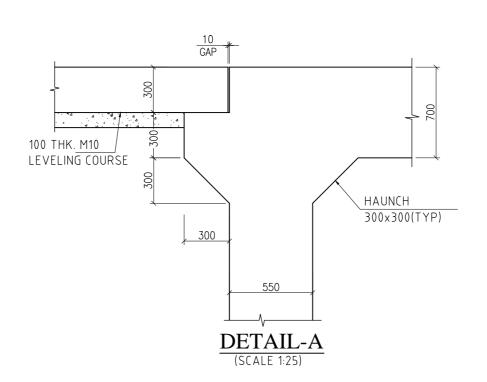

NOTES:-

- 1. ALL DIMENSIONS ARE IN mm, LEVELS ARE IN m. & CHAINAGE ARE IN KILOMETER + METER. UNLESS OTHERWISE SPECIFIED. ONLY WRITTEN DIMENSIONS SHALL BE FOLLOWED.
- 2. STRUCTURE LOCATION REFER TO THE CHAINAGE AT STRUCTURE CENTER AND LEVELS
- 3. THIS DRAWING TO BE READ IN CONJUCTION TO THE HIGHWAY DRAWINGS. IF THERE IS ANY DIFFERENCE IN CHAINAGE OR LEVELS H/W DRAWINGS WILL PREVAIL.
- 5. THE STRUCTURE IS DESIGNED TO CATER TO MAXIMUM OF:-
 - ONE LANE, TWO LANE, THREE AND FOUR LANE OF CLASS A.
 - TWO LANE OF CLASS A IN ADDITION OF ONE LANE OF 70R WHEEL OR ONE LANE OF CLASS 70R TRACKED WHICHEVER IS GOVERNING
- 6. SEISMIC ZONE = III AS PER IRC:SP:114-2018 HAS BEEN CONSIDERED.
- 7. GRADE OF CONCRETE:-
- FOR RCC BOX.. ...M35 FOR LEVELING COURSE ..M10 CRASH BARRIER. .M40 APPROACH SLAB.. ..M30
- 7. GRADE OF STEEL SHALL BE Fe-500 CONFIRMING TO IS:1786.
- 8. ALL CONSTRUCTION SHALL CONFIRM TO CONTRACT SPECIFICATIONS.
- 9. COMPACTED EARTH SHOULD CONFORM TO CLAUSE 305.2.1.5 OF MORTH
- 10. SOFT AND LOOSE PATCHES UNDER THE FOUNDING AREA ARE TO BE REPLACED BY COMPACTED GRANULAR FILLS WITH LAYERS NOT EXCEEDING 300mm.
- 11. BACKFILL GRANULAR SOIL MATERIAL BEHIND BOX STRUCTURE SHALL HAVE THE
- FOLLOWS PROPERTIES AS $.\gamma = 1800 \text{ Kg/M}^3 \text{ g C} = 0, \phi = 30^\circ$ 12. 600mm THICK. FILTER MATERIAL BEHIND BOX/RETAINING WALL SHALL BE LAID AS
- PER APPENDIX 6 OF IRC 78-2000. 13. THE STRUCTURE IS DESIGNED FOR NET SAFE BEARING CAPACITY OF 10.0 t/m² GROUND IMPROVEMENT UP TO 900mm BELOW THE FOUNDATION TO BE PROVIDED TO
- ACHIEVE REQUIRED SBC AS PER GEOTECH REPORT. 14. PERFORATED P.V.C. PIPE 150¢ TO BE PROVIDED OF GROUND LEVEL BEHIND WALL FOR DRAINAGE.

CLIENT:



NATIONAL HIGHWAYS AND INFRASTRUCTURE **DEVELOPMENT CORPORATION LTD. (MINISTRY** OF ROAD TRANSPORT AND HIGHWAYS) **GOVERNMENT OF INDIA**

PROJECT:

CONSULTANCY SERVICES FOR PREPARATION OF DETAILED PROJECT REPORT FOR DEVELOPMENT OF **ECONOMIC CORRIDORS. INTER CORRIDORS AND** FEEDER ROUTES TO IMPROVE THE EFFICIENCY OF FREIGHT MOVEMENTS IN INDIA UNDER BHARATMALA PARIYOJANA (LOT-1:PACKAGE IV)

DESIGN CONSULTANT:

VOYANTS SOLUTIONS PVT LTD. VOYANTS 403, 4th Floor, Park Centra, Sector-30, NH-8 Gurugram-122001, Haryana, India CIN- U74140HR2004PTC046918 Ph: 0124-4598200, Fax: 0124-4019051, E-mail: info@voyants.in, www.voyants.in

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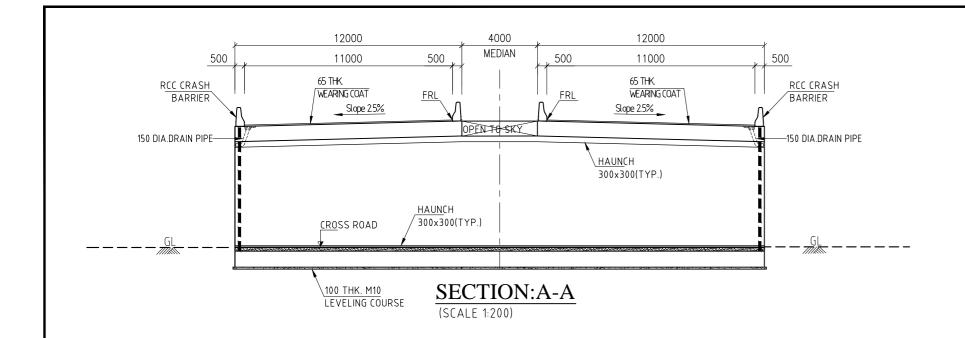
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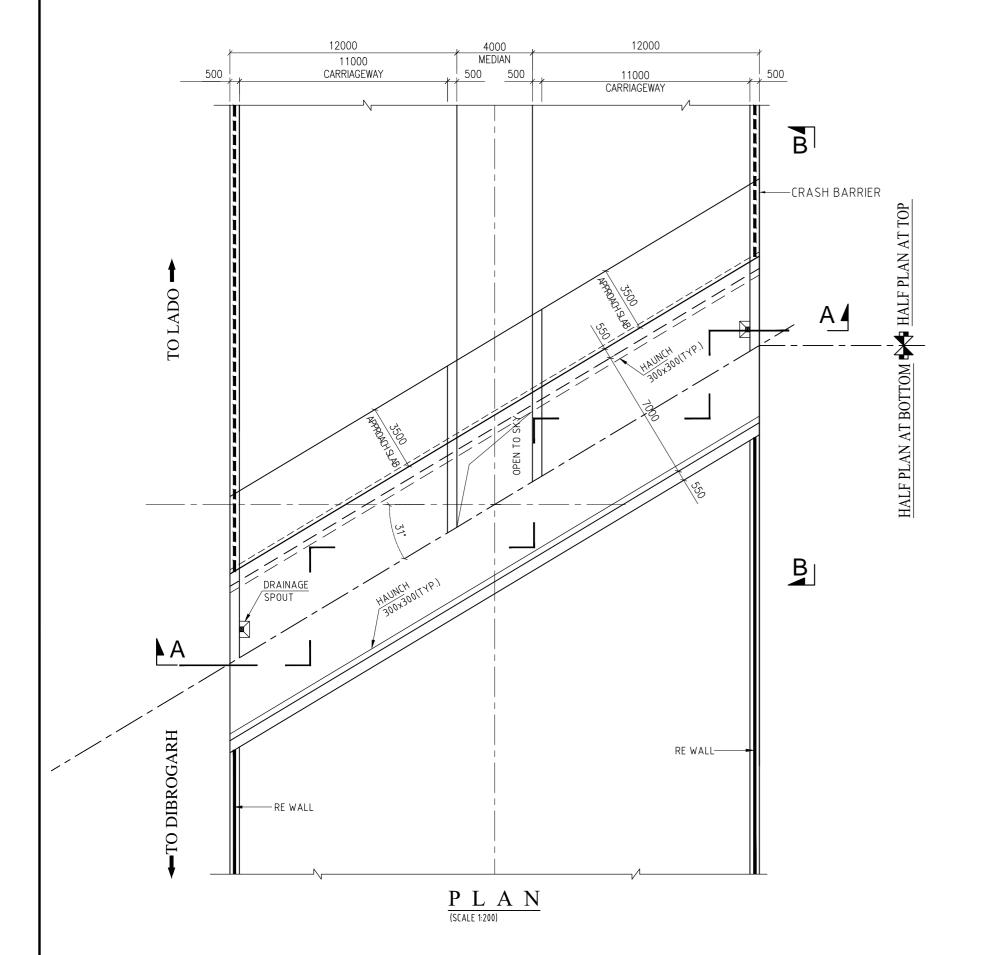
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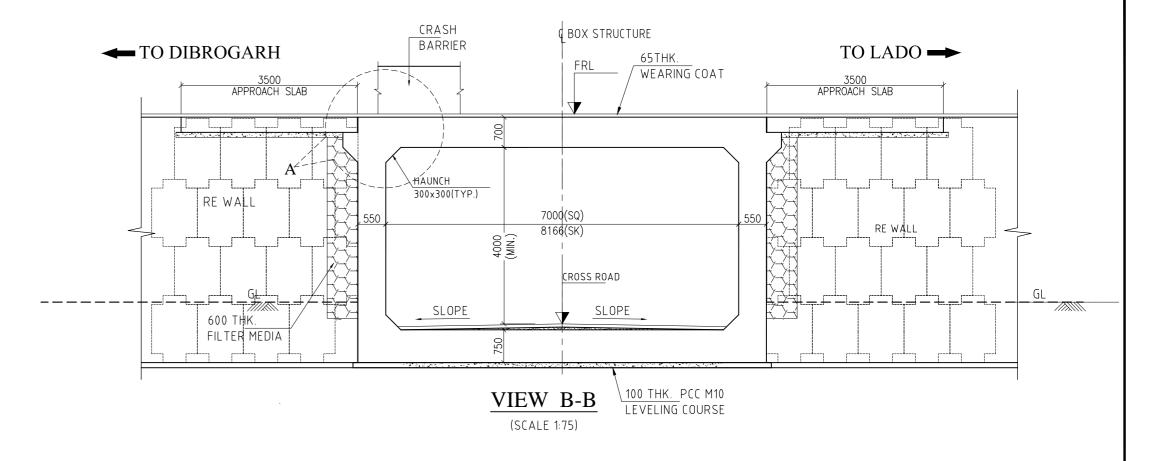
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GENERAL ARRANGEMENT DRAWING OF SMALL VEHICULAR UNDERPASS AT Ch. Km. 70+807.260 $(1 \times 7.0 \times 4.5)$

DRG. No. : VSPL/1718-081/DPR/PKG-4/NH-515/SEC-3/SVUP-02(Sht. 1 of 1 **REVISION:** January, 2023








DATUM =126.00m

FINISHED ROAD LEVEL (m)	133.564	133.570	1 133.576	
GROUND LEVEL (m)	126.740	126.739	126.789	
CHAINAGE (kM)	72+786.950	72+791.00 I	72+795.050 I	

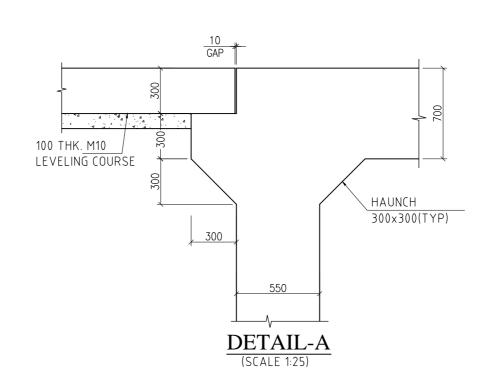

NOTES:-

- ALL DIMENSIONS ARE IN mm, LEVELS ARE IN m. & CHAINAGE ARE IN KILOMETER + METER. UNLESS OTHERWISE SPECIFIED. ONLY WRITTEN DIMENSIONS SHALL BE FOLLOWED.
- 2. STRUCTURE LOCATION REFER TO THE CHAINAGE AT STRUCTURE CENTER AND LEVELS AT MEDIAN EDGE.
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- 5. THE STRUCTURE IS DESIGNED TO CATER TO MAXIMUM OF:-
 - ONE LANE, TWO LANE, THREE AND FOUR LANE OF CLASS A.
 - TWO LANE OF CLASS A IN ADDITION OF ONE LANE OF 70R WHEEL OR ONE
- LANE OF CLASS 70R TRACKED WHICHEVER IS GOVERNING

 6. SEISMIC ZONE = III AS PER IRC:SP:114-2018 HAS BEEN CONSIDERED.
- 7. GRADE OF CONCRETE:-
- APPROACH SLAB......
 GRADE OF STEEL SHALL BE Fe-500 CONFIRMING TO IS:1786.
- 8. ALL CONSTRUCTION SHALL CONFIRM TO CONTRACT SPECIFICATIONS.
- 9. COMPACTED EARTH SHOULD CONFORM TO CLAUSE 305.2.1.5 OF MORTH SPECIFICATIONS.
- 10. SOFT AND LOOSE PATCHES UNDER THE FOUNDING AREA ARE TO BE REPLACED BY COMPACTED GRANULAR FILLS WITH LAYERS NOT EXCEEDING 300mm.
- 11. BACKFILL GRANULAR SOIL MATERIAL BEHIND BOX STRUCTURE SHALL HAVE THE FOLLOWS PROPERTIES AS γ-1800 Kα/M³ α C 0 φ 30°
- FOLLOWS PROPERTIES AS . γ = 1800 Kg/M 3 g C = 0, ϕ = 30°, 12. 600mm THICK. FILTER MATERIAL BEHIND BOX/RETAINING WALL SHALL BE LAID AS
- PER APPENDIX 6 OF IRC 78-2000.

 13. THE STRUCTURE IS DESIGNED FOR NET SAFE BEARING CAPACITY OF 10.0 $\rm t/m^2$. GROUND IMPROVEMENT UP TO 900mm BELOW THE FOUNDATION TO BE PROVIDED TO
- ACHIEVE REQUIRED SBC AS PER GEOTECH REPORT.

 14. PERFORATED P.V.C. PIPE 150¢ TO BE PROVIDED OF GROUND LEVEL BEHIND WALL FOR DRAINAGE.

CLIENT :



NATIONAL HIGHWAYS AND INFRASTRUCTURE DEVELOPMENT CORPORATION LTD. (MINISTRY OF ROAD TRANSPORT AND HIGHWAYS) GOVERNMENT OF INDIA PROJECT :

CONSULTANCY SERVICES FOR PREPARATION OF DETAILED PROJECT REPORT FOR DEVELOPMENT OF ECONOMIC CORRIDORS, INTER CORRIDORS AND FEEDER ROUTES TO IMPROVE THE EFFICIENCY OF FREIGHT MOVEMENTS IN INDIA UNDER BHARATMALA PARIYOJANA (LOT-1:PACKAGE IV)

DESIGN CONSULTANT:

VOYANTS SOLUTIONS
403, 4th Floor, Park Centra,
Sector-30, NH-8
Gurugram-122001, Haryana, In
CIN- U74140HR2004PTC0469

VOYANTS SOLUTIONS PVT LTI 403, 4th Floor, Park Centra, Sector-30, NH-8 Gurugram-122001, Haryana, India CIN- U74140HR2004PTC046918 Ph: 0124-4598200, Fax: 0124-4019051, E-mail: info@voyants.in, www.voyants.in

REV. DATE

DESCRIPTION

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n	DEV	DATE	DECODIFICAL	SCALE :	AS SHOWN	SHEET SIZE	A2	

GENERAL ARRANGEMENT DRAWING OF SMALL VEHICULAR UNDERPASS AT Ch. Km. 72+791.260 (1 x 7.0 x 4.5)


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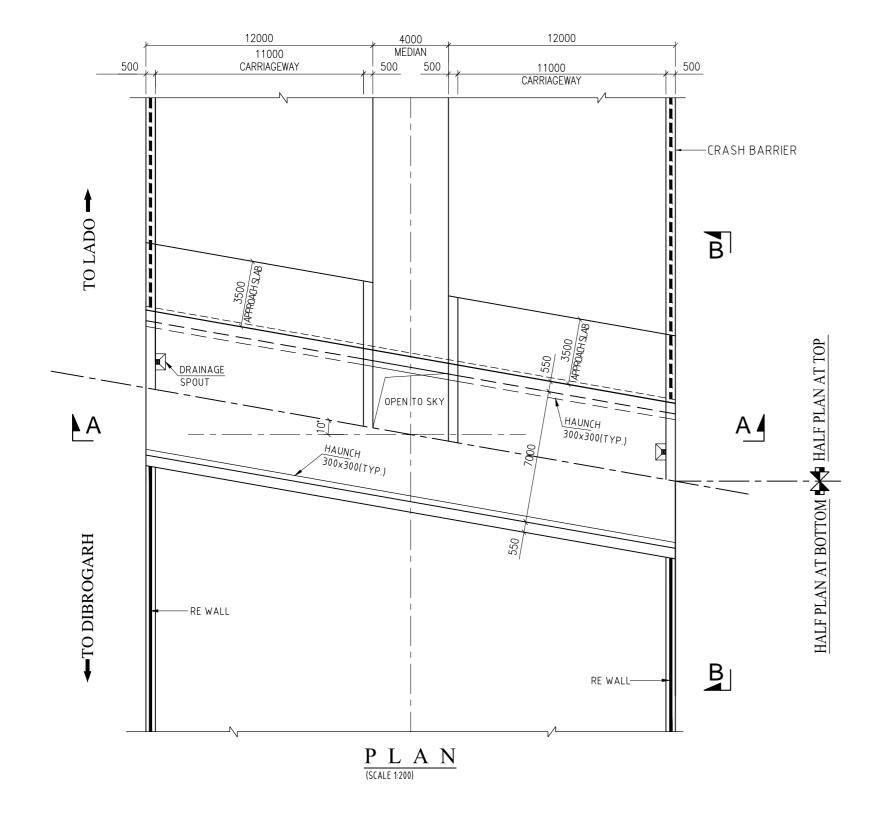
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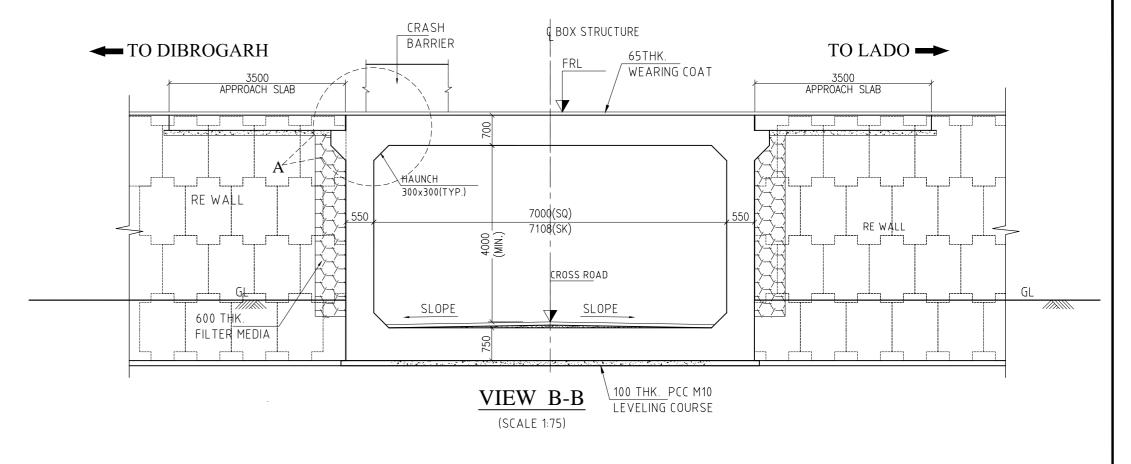
VSPL/1718-081/DPR/PKG-4/NH-515/SEC-3/SVUP-03(Sht. 1 of 1

REVISION:

January, 2023






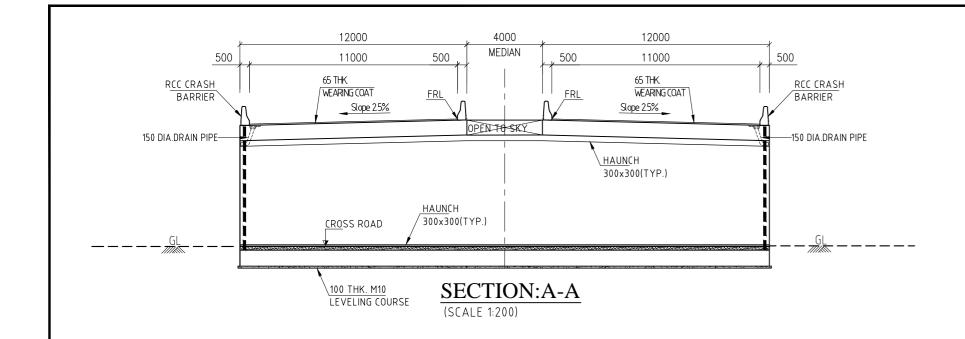

DATUM =126.00m

27 (1 0 111 1 2 0 1 0 0 1 1 1				
FINISHED ROAD LEVEL (m)	133.564	133.570	133.576	
GROUND LEVEL (m)	126.740	1 126.739	1 126.789	
CHAINAGE (kM)	72+786.950	1 72+791.00 I	1 72+795.050 I	

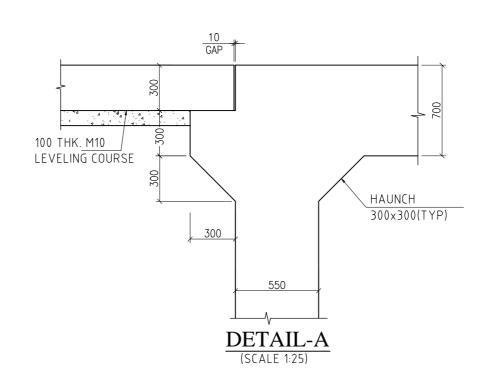

NOTES:-

- 1. ALL DIMENSIONS ARE IN mm, LEVELS ARE IN m. & CHAINAGE ARE IN KILOMETER + METER. UNLESS OTHERWISE SPECIFIED. ONLY WRITTEN DIMENSIONS SHALL BE FOLLOWED.
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 - b. TWO LANE OF CLASS A IN ADDITION OF ONE LANE OF 70R WHEEL OR ONE LANE OF CLASS 70R TRACKED WHICHEVER IS GOVERNING
- 6. SEISMIC ZONE = III AS PER IRC:SP:114-2018 HAS BEEN CONSIDERED.
- 7. GRADE OF CONCRETE:-
- FOR RCC BOX.. ...M35 FOR LEVELING COURSE ..M10 CRASH BARRIER. .M40 APPROACH SLAB.. ..M30
- 7. GRADE OF STEEL SHALL BE Fe-500 CONFIRMING TO IS:1786.
- 8. ALL CONSTRUCTION SHALL CONFIRM TO CONTRACT SPECIFICATIONS.
- 9. COMPACTED EARTH SHOULD CONFORM TO CLAUSE 305.2.1.5 OF MORTH
- 10. SOFT AND LOOSE PATCHES UNDER THE FOUNDING AREA ARE TO BE REPLACED BY COMPACTED GRANULAR FILLS WITH LAYERS NOT EXCEEDING 300mm.
- 11. BACKFILL GRANULAR SOIL MATERIAL BEHIND BOX STRUCTURE SHALL HAVE THE
- FOLLOWS PROPERTIES AS $.\gamma = 1800 \text{ Kg/M}^3 \text{ g C} = 0, \phi = 30^\circ$ 12. 600mm THICK. FILTER MATERIAL BEHIND BOX/RETAINING WALL SHALL BE LAID AS PER APPENDIX 6 OF IRC 78-2000.
- 13. THE STRUCTURE IS DESIGNED FOR NET SAFE BEARING CAPACITY OF 10.0 t/m² GROUND IMPROVEMENT UP TO 900mm BELOW THE FOUNDATION TO BE PROVIDED TO
- ACHIEVE REQUIRED SBC AS PER GEOTECH REPORT. 14. PERFORATED P.V.C. PIPE 150¢ TO BE PROVIDED OF GROUND LEVEL BEHIND WALL FOR DRAINAGE.

CLIENT:



NATIONAL HIGHWAYS AND INFRASTRUCTURE **DEVELOPMENT CORPORATION LTD. (MINISTRY** OF ROAD TRANSPORT AND HIGHWAYS) **GOVERNMENT OF INDIA**

PROJECT:

CONSULTANCY SERVICES FOR PREPARATION OF DETAILED PROJECT REPORT FOR DEVELOPMENT OF **ECONOMIC CORRIDORS. INTER CORRIDORS AND** FEEDER ROUTES TO IMPROVE THE EFFICIENCY OF FREIGHT MOVEMENTS IN INDIA UNDER BHARATMALA PARIYOJANA (LOT-1:PACKAGE IV)

DESIGN CONSULTANT:

VOYANTS SOLUTIO VOYANTS 403, 4th Floor, Park Centr Sector-30, NH-8 Gurugram-122001, Harya CIN- U74140HR2004PTC Ph: 0124-4598200, Fax: E-mail: info@voyants.in,

ONS PVT LTD.	Det
ana, India C046918 0124-4019051, www.voyants.in	


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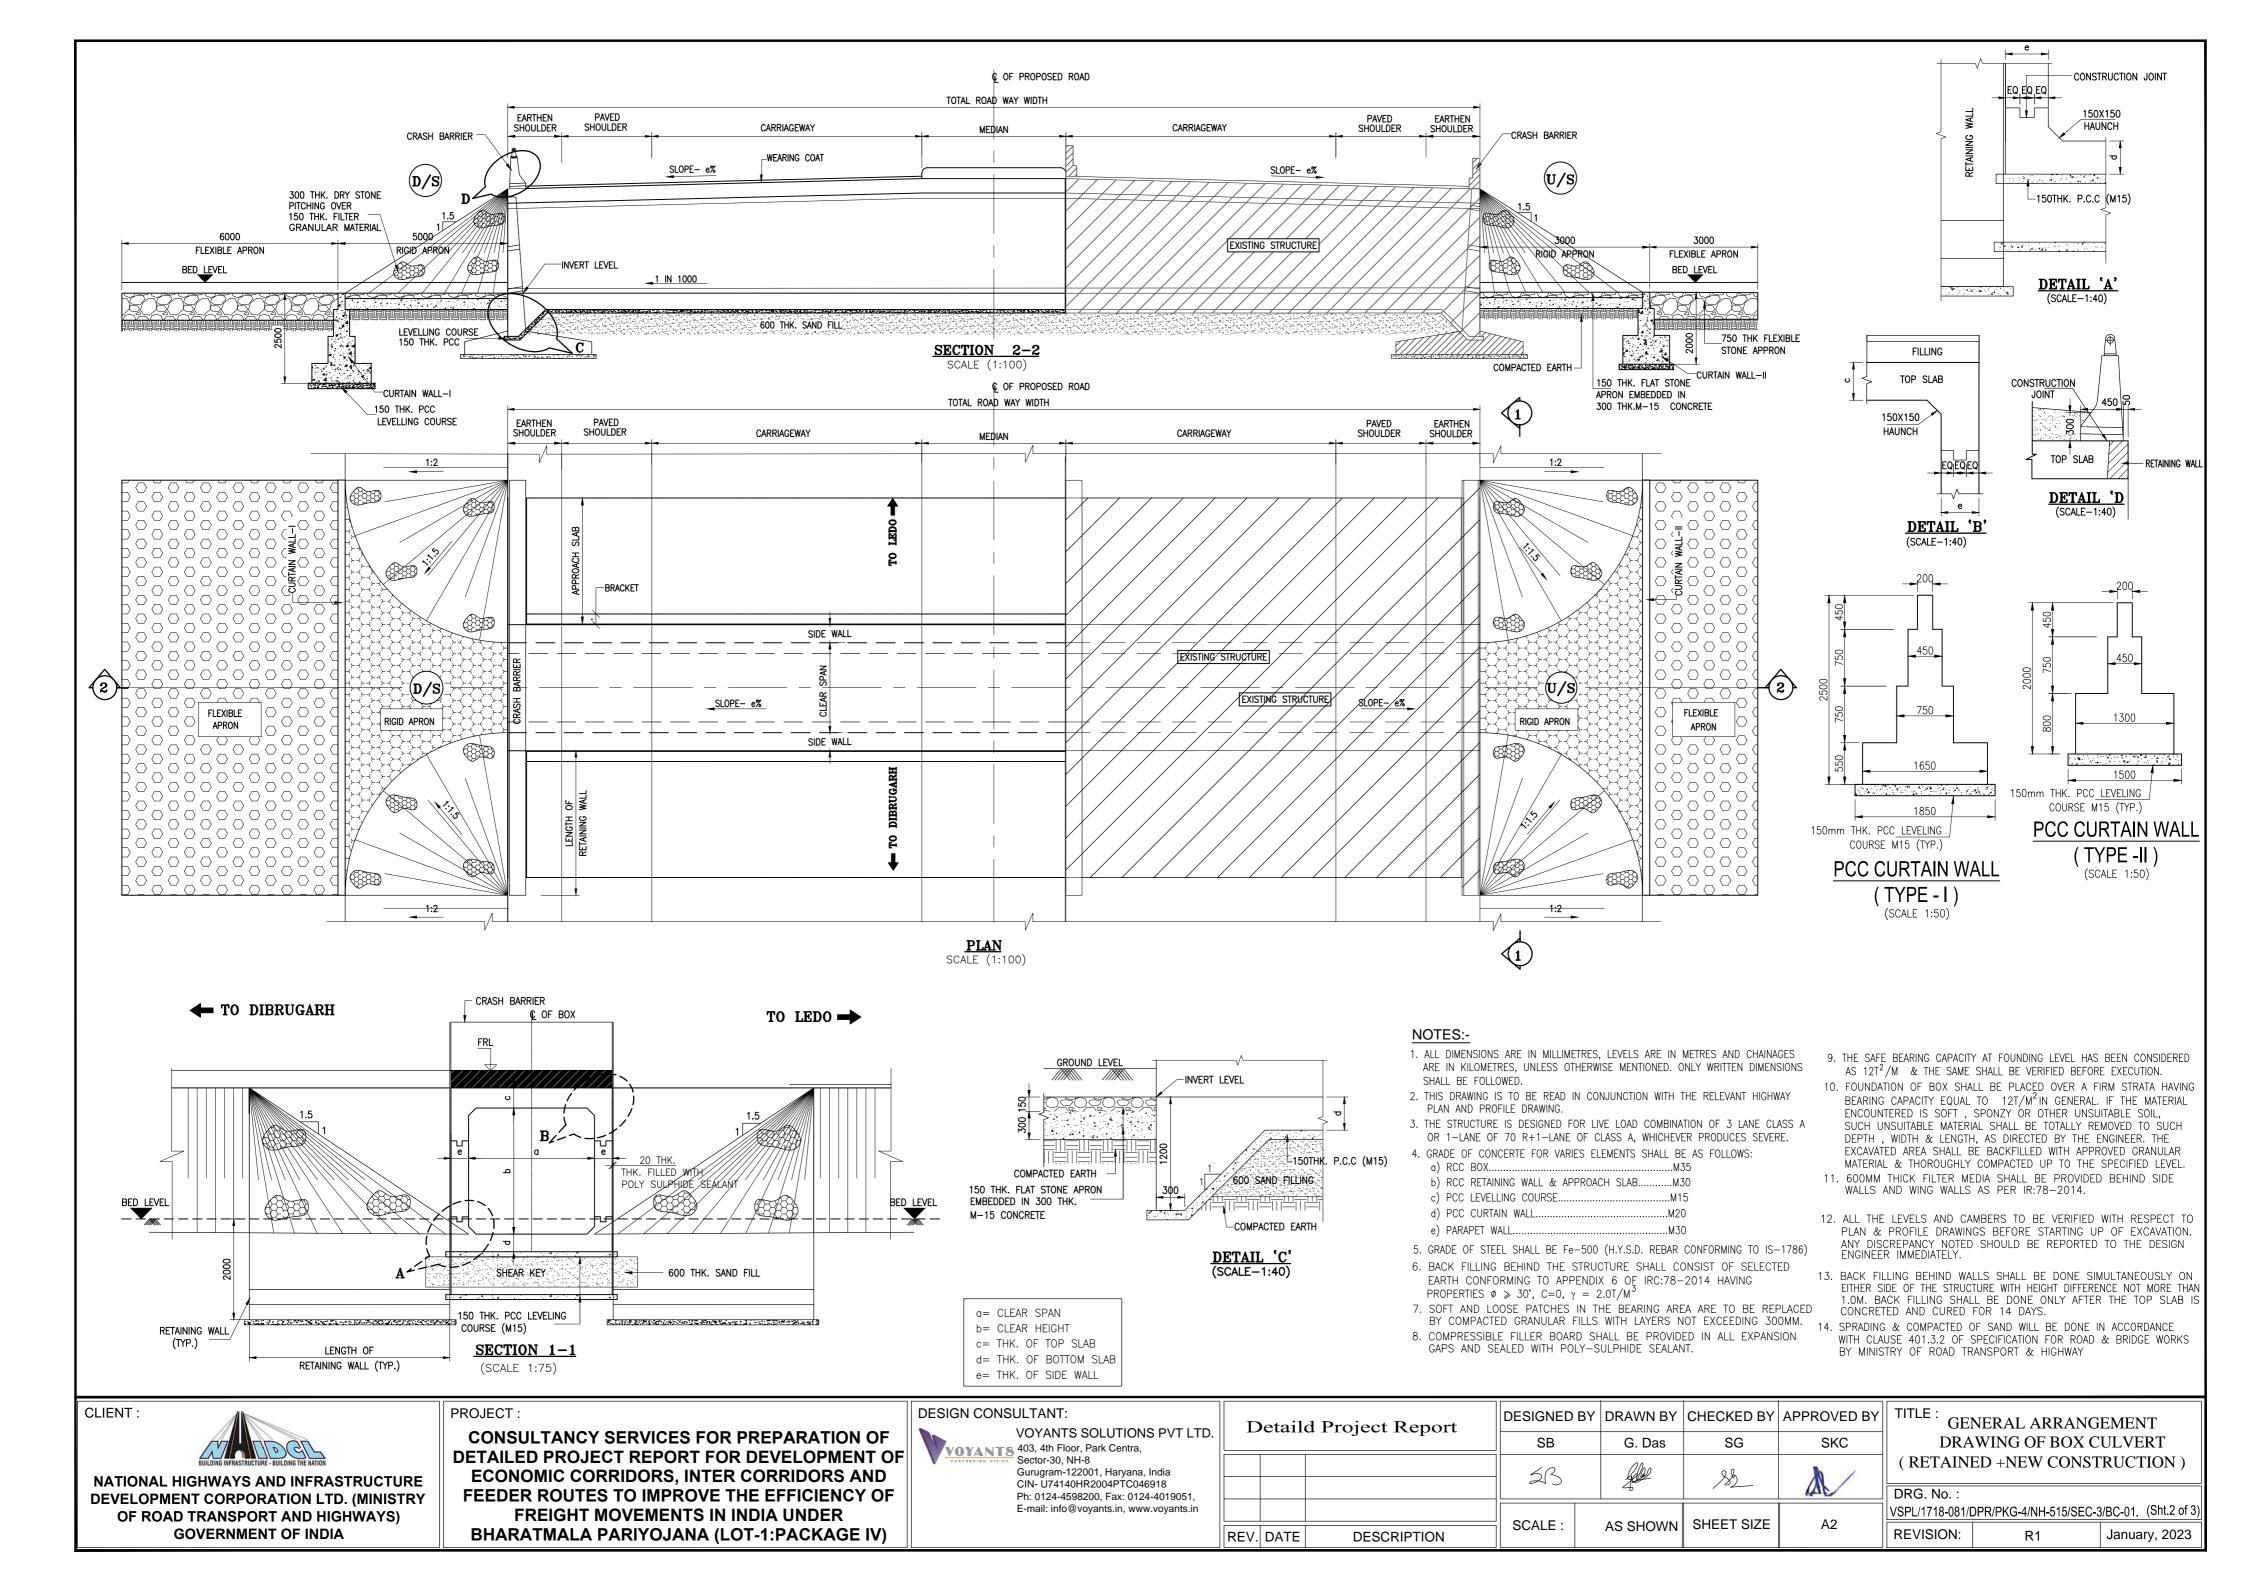
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•				SB	G. Das	SG	SKC
				3B		<u> }}</u>	
	DEV/		DESCRIPTION	SCALE :	AS SHOWN	SHEET SIZE	A2

DESCRIPTION

GENERAL ARRANGEMENT DRAWING OF SMALL VEHICULAR UNDERPASS AT Ch. Km. 74+609.000 $(1 \times 7.0 \times 4.5)$

DRG. No. VSPL/1718-081/DPR/PKG-4/NH-515/SEC-3/SVUP-04(Sht. 1 of 1 **REVISION:** January, 2023



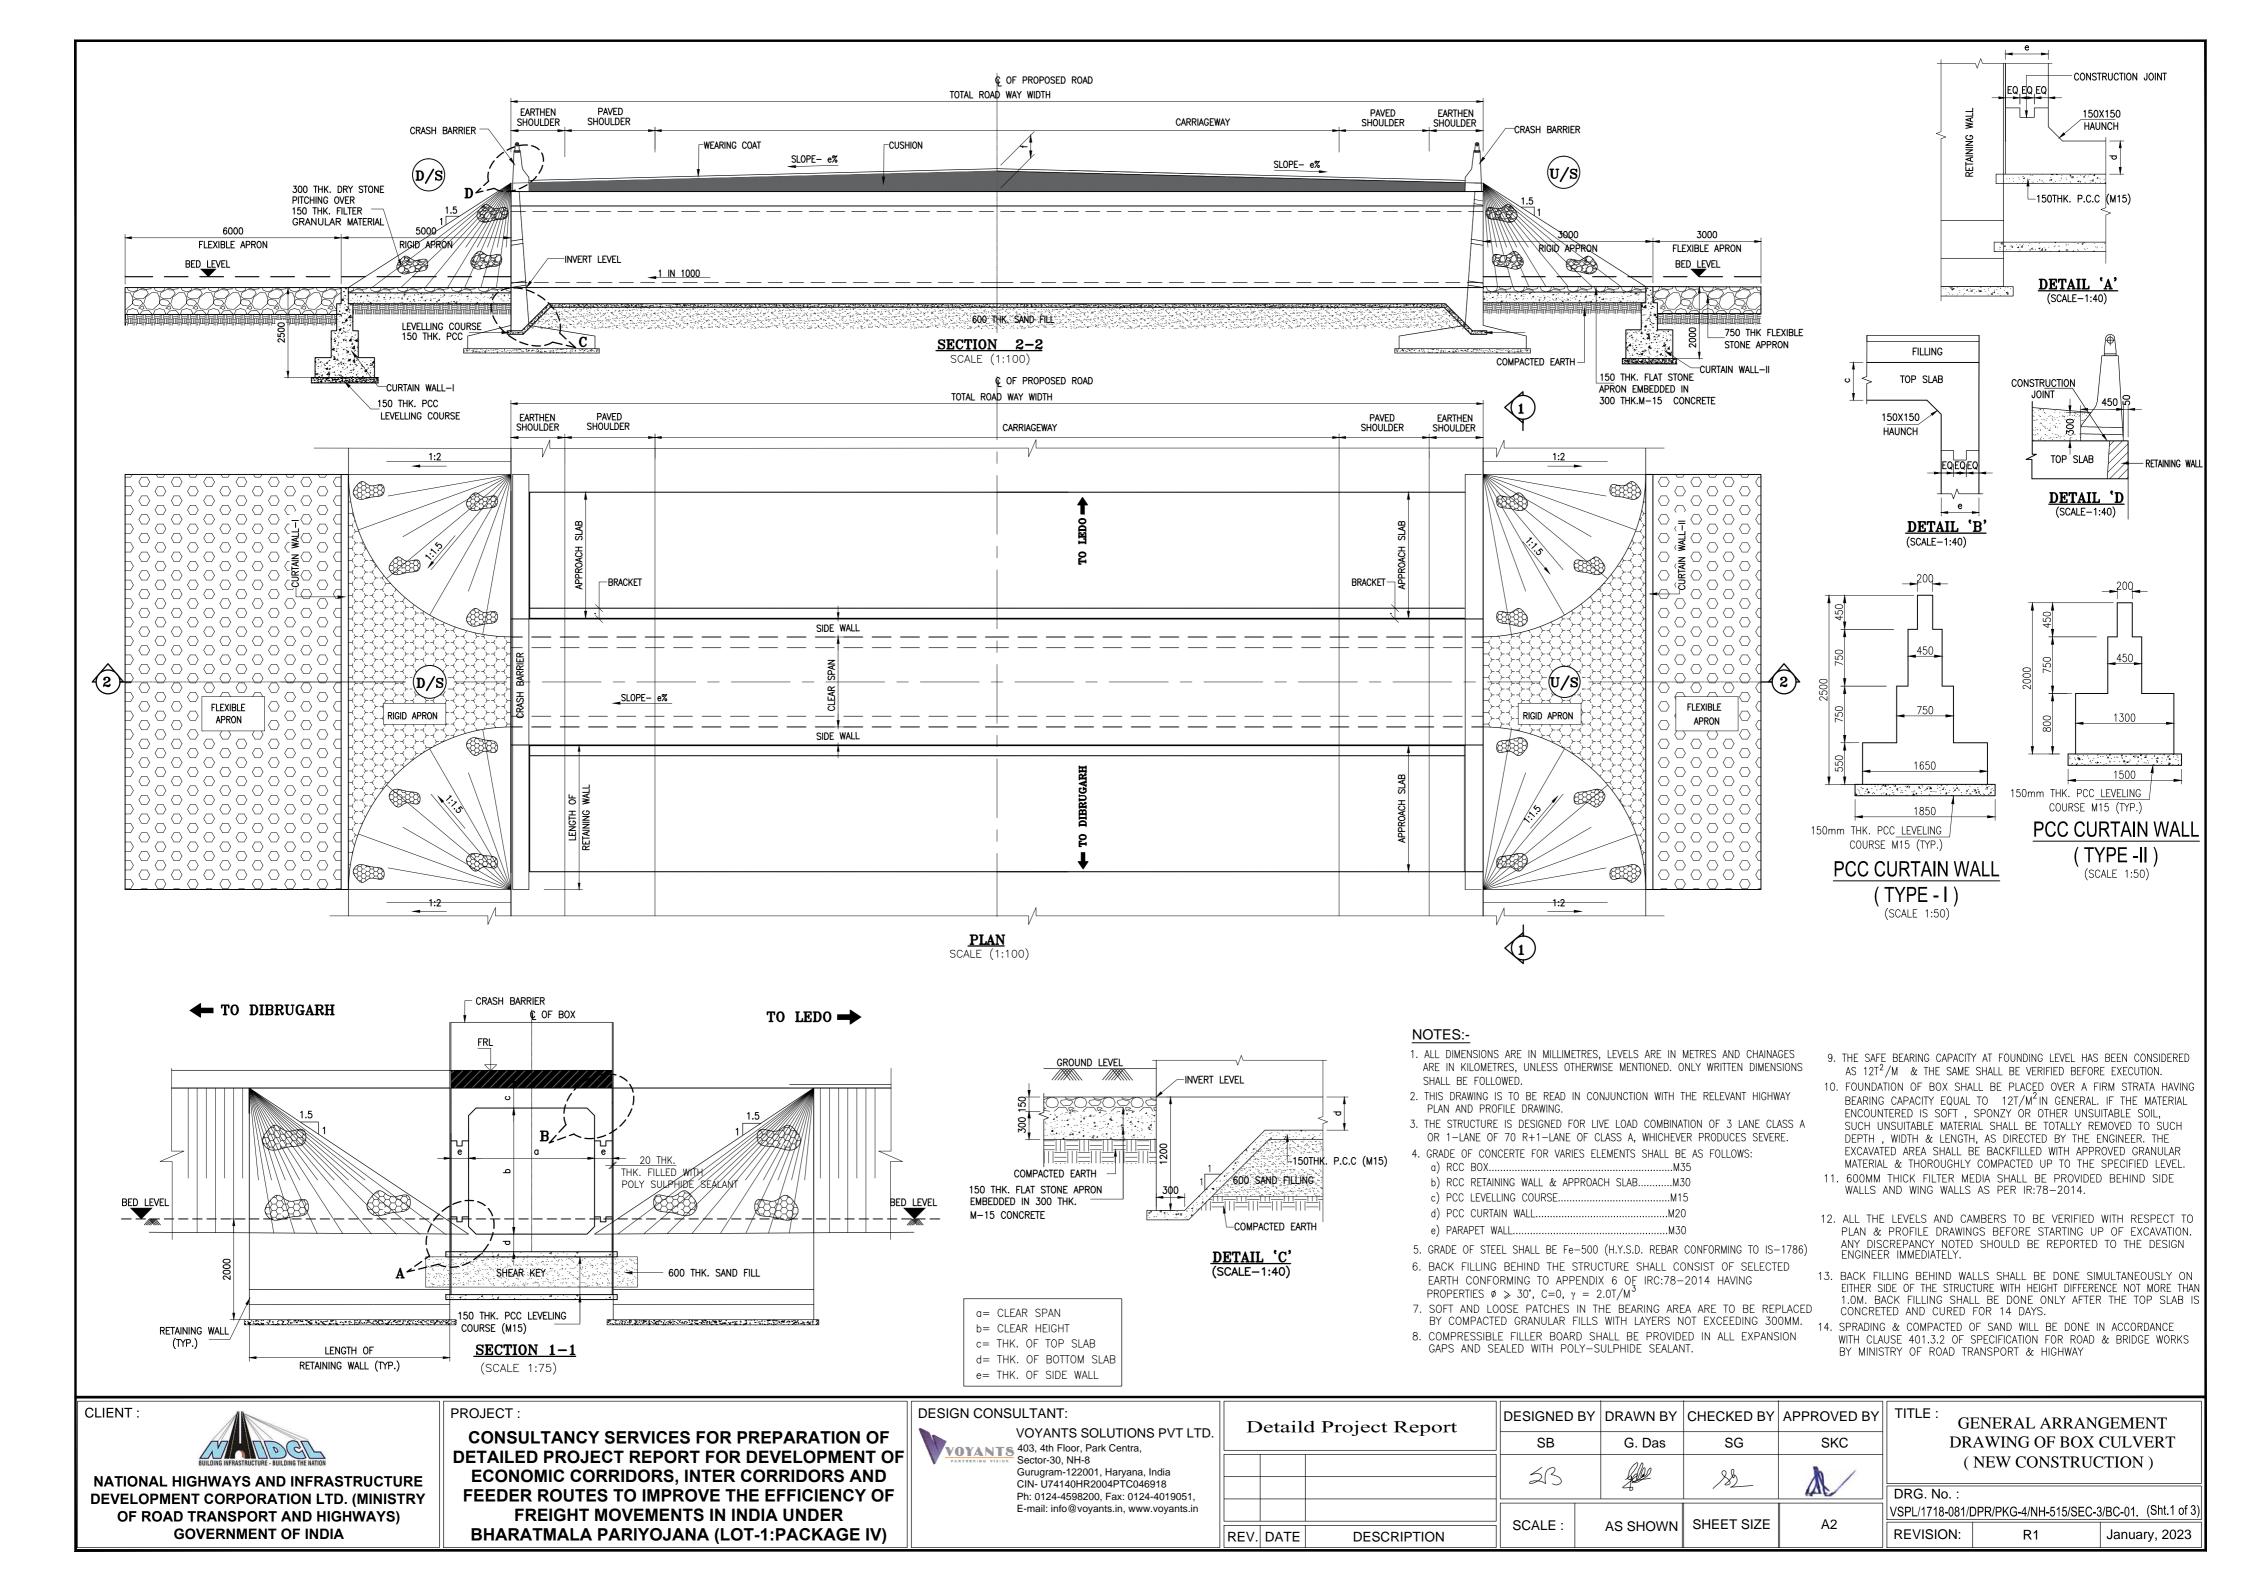

Culvert List: NH-515_PKG-3

	Chainag	e (km)		Exis	ting De	tails			Pro	posed Deta	ils	
SI. No.	Existing	Design	STATE	Туре	Span	Width (m)	Improvement Proposal	Туре	Span	TCS Type	Total Width	Widening Width
1	57+675	57+663	ASSAM	Вох	1 x 2.5	12.0	Retain & widen	Box	1 x 2.5 x 2.5	Type - 05	24.5	12.5
2	58+720	58+702	ASSAM	Slab	1 x 2.5	12.0	Retain & widen	Box	1 x 2.5 x 2.0	Type - 05	24.5	12.5
3	59+160	59+148	ASSAM	Slab	1 x 2.5	12.0	Retain & widen	Box	1 x 2.5 x 1.8	Type - 05	24.5	12.5
4	59+350	59+335	ASSAM	Вох	1 x 2.0	12.0	Retain & widen	Box	1 x 2.0 x 2.0	Type - 05A	24.5	12.5
5	59+820	59+804	ASSAM	Вох	1 x 2.0	12.2	Retain & widen	Box	1 x 2.0 x 2.5	Type - 05	24.5	12.3
6	60+225	60+207	ASSAM	Вох	1 x 2.0	12.0	Retain & widen	Box	1 x 2.0 x 1.5	Type - 05	24.5	12.5
7	60+525	60+507	ASSAM	Вох	1 x 2.0	12.0	Retain & widen	Box	1 x 2.0 x 2.0	Type - 05	24.5	12.5
8	61+225	61+195	ASSAM	Вох	1 x 2.2	12.0	Retain & widen	Box	1 x 2.2 x 2.0	Type - 03	42.25	30.3
9	62+710	62+680	ASSAM	Вох	1 x 2.0	12.0	Retain & widen	Box	1 x 2.0 x 2.5	Type - 05	24.5	12.5
10	64+790	64+748	ASSAM	Slab	1 x 2.0	12.0	Retain & widen	Box	1 x 2.0 x 1.5	Type - 05	24.5	12.5
11	65+225	65+177	ASSAM	Slab	1 x 2.5	12.0	Retain & widen	Box	1 x 2.5 x 1.0	Type - 05	24.5	12.5
12	65+350	65+303	ASSAM	Slab	1 x 2.5	12.0	Retain & widen	Box	1 x 2.5 x 1.2	Type - 05	24.5	12.5
13	65+925	65+873	ASSAM	Slab	1 x 2.3	12.0	Retain & widen	Box	1 x 2.3 x 2.0	Type - 05	24.5	12.5
14	-	67+170	ASSAM	Вох	-	-	New construction	Box	1 x 2.5 x 4.0	Type - 04	33.1	33.1
15	-	67+520	ASSAM	Вох	-	-	New construction	Box	1 x 2.5 x 2.0	Type - 01B	26.0	26.0
16	-	67+830	ASSAM	Вох	-	-	New construction	Box	1 x 2.5 x 3.0	Type - 01B	26.0	26.0
17	-	68+850	ASSAM	Вох	-	-	New construction	Box	1 x 2.5 x 2.0	Type - 01B	26.0	26.0
18	-	70+580	ASSAM	Вох	-	-	New construction	Box	1 x 2.5 x 3.0	Type - 01B	26.0	26.0
19	-	71+330	ASSAM	Вох	-	-	New construction	Box	1 x 2.5 x 3.2	Type - 01B	26.0	26.0
20	-	71+680	ASSAM	Вох	-	-	New construction	Box	1 x 2.5 x 2.2	Type - 01B	26.0	26.0
21	-	72+030	ASSAM	Вох	-	-	New construction	Box	1 x 2.5 x 2.5	Type - 01B	26.0	26.0
22	-	73+144	ASSAM	Вох	-	-	New construction	Box	1 x 2.5 x 2.5	Type - 01B	26.0	26.0
23	-	73+494	ASSAM	Вох	-	-	New construction	Box	1 x 2.5 x 2.2	Type - 01B	26.0	26.0
24	-	75+000	ASSAM	Вох	-	-	New construction	Box	1 x 2.5 x 2.0	Type - 01B	26.0	26.0
25	75+590	75+531	ASSAM	Slab	1 x 6.0	13.0	Retain & widen	Box	1 x 6.0 x 3.5	Type - 01	24.5	11.5
26	75+600	75+545	ASSAM	Slab	1 x 6.0	13.0	Retain & widen	Box	1 x 6.0 x 3.5	Type - 01	24.5	11.5
27	76+025	75+957	ASSAM	Slab	1 x 2.0	11.8	Retain & widen	Box	1 x 2.0 x 2.0	Type - 05A	24.5	12.7
28	76+160	76+112	ASSAM	Slab	1 x 1.0	11.8	Retain & widen	Box	1 x 1.0 x 1.0	Type - 05A	24.5	12.7
29	-	77+456	ASSAM	Slab	1 x 3.5	11.8	Retain & widen	Box	1 x 3.5 x 1.0	Type - 05A	24.5	12.7
30	78+610	78+544	ASSAM	Slab	1 x 6.0		Retain & widen	Box	1 x 6.0 x 1.5	Type - 05A	24.5	9.7
31	79+740	79+688	ASSAM	Slab	1 x 2.5	12.5	Retain & widen	Box	1 x 2.5 x 1.2	Type - 02	24.5	12.0
32	-	79+795	ASSAM	Slab	1 x 1.7		Retain & widen	Box	1 x 1.7 x 1.2	Type - 02	24.5	12.7

CLIENT:

NATIONAL HIGHWAYS AND INFRASTRUCTURE DEVELOPMENT CORPORATION LTD. (MINISTRY OF ROAD TRANSPORT AND HIGHWAYS)

GOVERNMENT OF INDIA

PROJECT:

CONSULTANCY SERVICES FOR PREPARATION OF DETAILED PROJECT REPORT FOR DEVELOPMENT OF ECONOMIC CORRIDORS, INTER CORRIDORS AND FEEDER ROUTES TO IMPROVE THE EFFICIENCY OF FREIGHT MOVEMENTS IN INDIA UNDER BHARATMALA PARIYOJANA (LOT-1:PACKAGE IV)

DESIGN CONSULTANT:

VOYANTS SOLUTIONS PVT LTD
403, 4th Floor, Park Centra,
Sector-30, NH-8
Gurugram-122001, Haryana, India
CIN- U74140HR2004PTC046918
Ph: 0124-4598200, Fax: 0124-4019051,
E-mail: info@voyants.in, www.voyants.in

REV. DATE

DESCRIPTION

ΓD.	Detaild Project Report			DESIGNED BY	DRAWN BY	CHECKED BY	APPROVED BY
				SB	G. Das	SG	SKC
				5 B		<u>}}_</u>	
ı	DEV	DATE	DECODIDATION	SCALE:	AS SHOWN	SHEET SIZE	A2

GENERAL ARRANGEMENT
DRAWING OF BOX CULVERT
(NEW CONSTRUCTION)

DRG. No. :

VSPL/1718-081/DPR/PKG-4/NH-515/SEC-1/BC-01. (Sht.3 of 3)

REVISION: R1 January, 2023