


NATIONAL HIGHWAYS & INFRASTRUCTURE DEVELOPMENT CORPORATION LTD

CONSULTANCY SERVICES FOR FEASIBILITY STUDY, PREPARATION OF (DPR) AND PROVIDING PRE-CONSTRUCTION SERVICES FOR UP GRADATION OF SELECTED ROAD STRETCHES / CORRIDORS TO TWO LANE WITH PAVED SHOULDER NH CONFIGURATION UNDER BHARAT MALA PROJECT AND NATIONAL HIGHWAYS CONNECTIVITY TO BACKWARD AREAS/RELIGIOUS/TOURIST PLACES OF THE COUNTRY IN THE STATE OF TRIPURA.

(PKG-2 KAILASHAHAR TO KURTI BRIDGE) (SECTION:3- DES.CH.-25+250 TO 36+460)





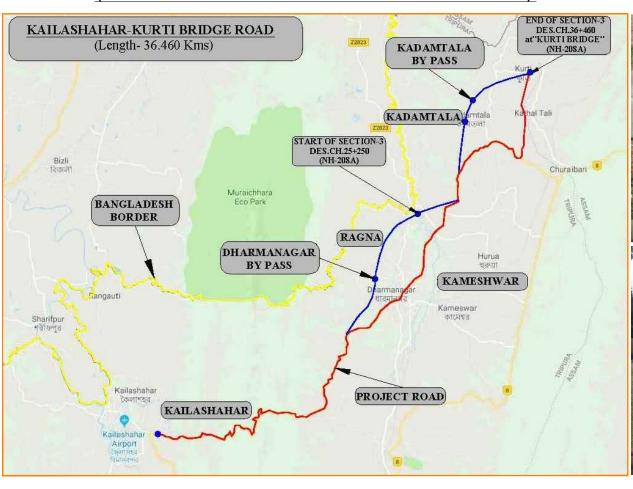





CLIENT:-



NATIONAL HIGHWAYS & INFRASTRUCTURE DEVELOPMENT CORPORATION LTD

(DRAWING VOLUME)

DRAFT DETAIL PROJECT REPORT

DECEMBER- 2019

CONSULTANT:-




Technocrats Advisory Services Private Limited in association with Vaishnavi Infratech Services P. Ltd 68,Ajanta Apartsments, 36, I.P. Extension Patparganj Delhi-110092.



KAILASHAHAR - KURTI BRIDGE (DESIGN LENGTH-36.460km)



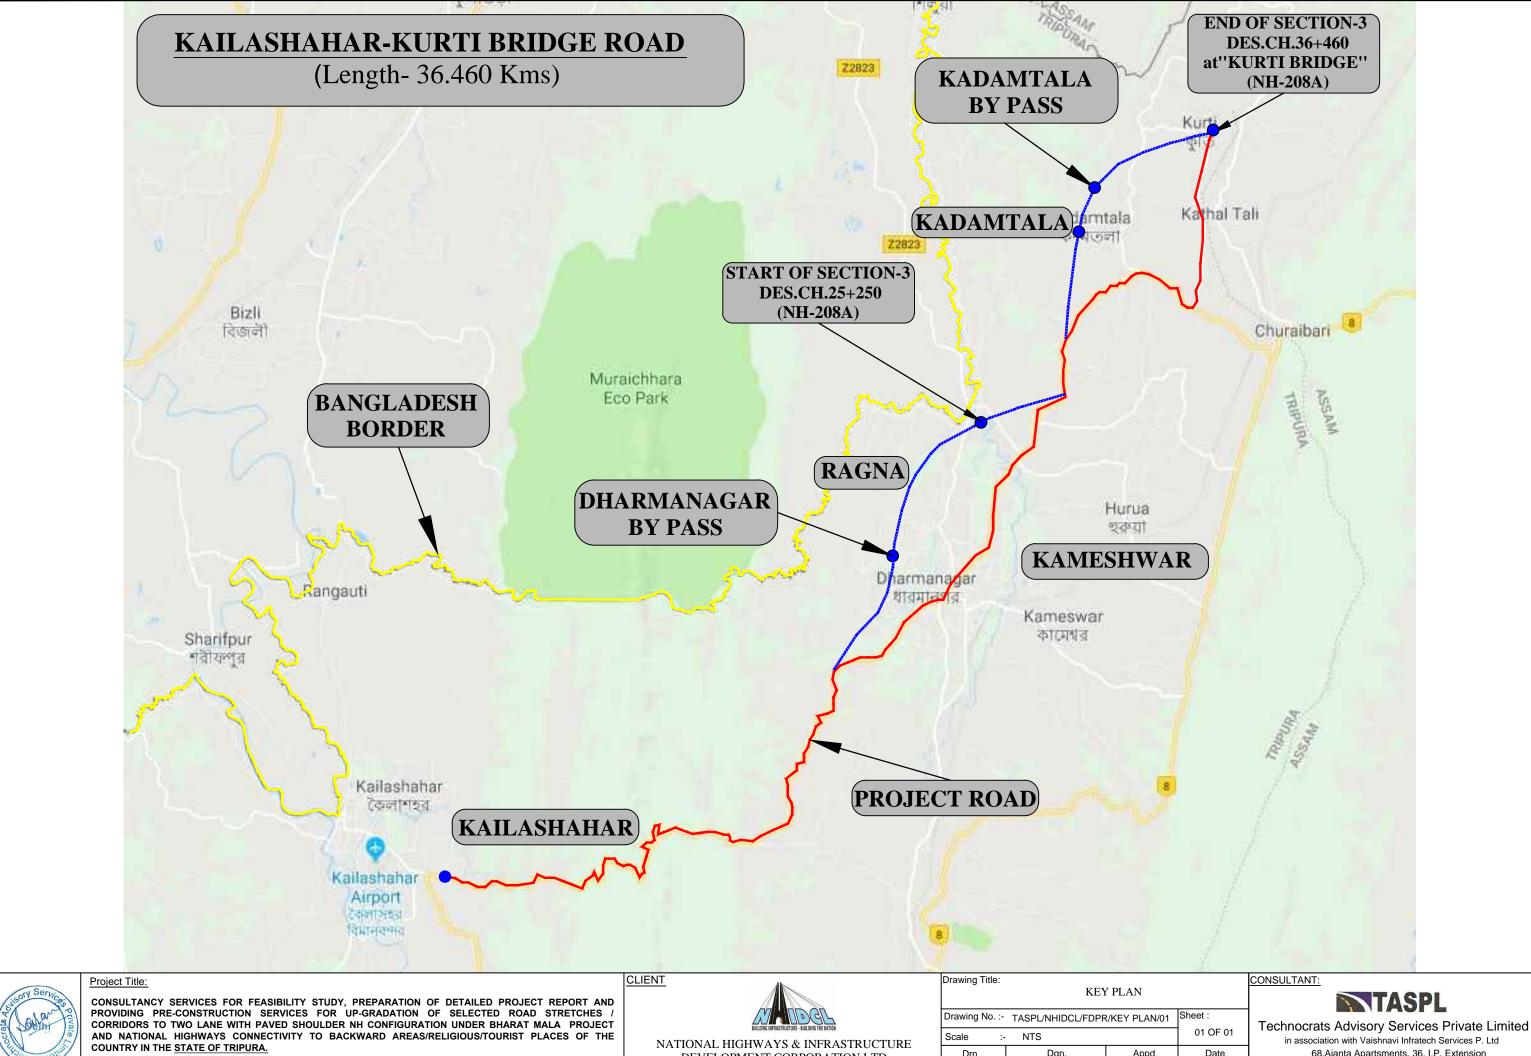


KAILASHAHAR - KURTI BRIDGE SECTION-3



BUILDING INFRASTRUCTURE - BUILDING THE NATION	
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TIONAL HIGHWAYS & INFRASTRUCTURE	30
DEVELOPMENT CORPORATION LTD	

01 OF 01 NTS Dgn. Appd Deepak B.Mishra DEC - 2019 B.S.Pandey

in association with Vaishnavi Infratech Services P. Ltd 68, Ajanta Apartsments, 36, I.P. Extension Patparganj Delhi-110092.

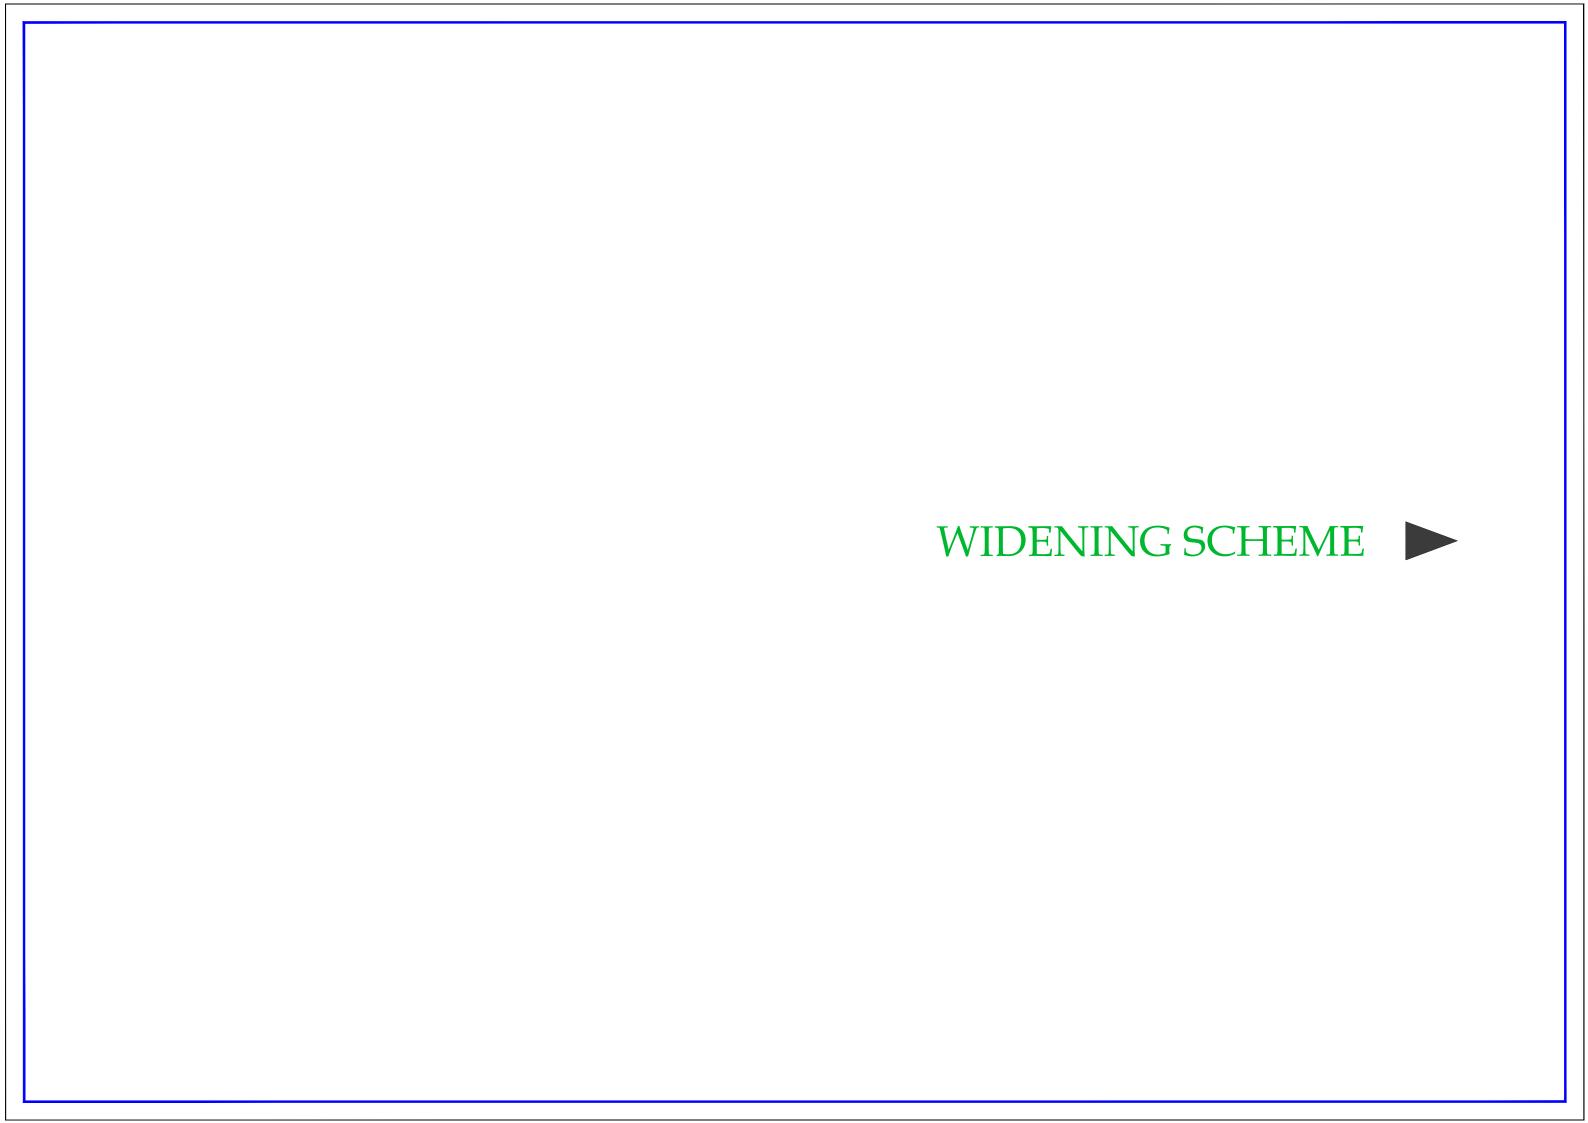

WIDENING SCHEME OF PROJECT ROAD Design Chainage Bridge									
CL N			Bridge	Length	TCC T-ma	Degavintion			
Sl. No	From (Km)	To (Km)	Length (km)	(km)	TCS Type	Description			
1	25.250	25.255		0.005	TCS-6	Two lane with PS (Retaining wall in pond location)			
2	25.255	25.400		0.145	TCS-1	Two lane with Paved Shoulder (New Construction)			
3	25.400	25.415		0.015	TCS-6	Two lane with PS (Retaining wall in pond location)			
4	25.415	25.690		0.275	TCS-1	Two lane with Paved Shoulder (New Construction)			
5	25.690	25.705		0.015	TCS-6	Two lane with PS (Retaining wall in pond location)			
6	25.705	25.770		0.065	TCS-1	Two lane with Paved Shoulder (New Construction)			
7	25.770	25.785		0.015	TCS-6	Two lane with PS (Retaining wall in pond location)			
8	25.785	27.030	0.010	1.235	TCS-1	Two lane with Paved Shoulder (New Construction)			
9	27.030	27.055		0.025	TCS-6	Two lane with PS (Retaining wall in pond location)			
10	27.055	27.250		0.195	TCS-1	Two lane with Paved Shoulder (New Construction)			
11	27.250	27.285		0.035	TCS-6	Two lane with PS (Retaining wall in pond location)			
12	27.285	27.650	0.050	0.315	TCS-1	Two lane with Paved Shoulder (New Construction)			
13	27.650	27.680		0.030	TCS-6	Two lane with PS (Retaining wall in pond location)			
14	27.680	29.600	0.025	1.895	TCS-1	Two lane with Paved Shoulder (New Construction)			
15	29.600	29.625		0.025	TCS-6	Two lane with PS (Retaining wall in pond location)			
16	29.625	31.000		1.375	TCS-1	Two lane with Paved Shoulder (New Construction)			
17	31.000	31.900		0.900	TCS-3	Two lane with PS with RCC drain			
18	31.900	32.760	0.015	0.845	TCS-1	Two lane with Paved Shoulder (New Construction)			
19	32.760	32.805		0.045	TCS-6	Two lane with PS (Retaining wall in pond location)			
20	32.805	33.640		0.835	TCS-1	Two lane with Paved Shoulder (New Construction)			
21	33.640	33.665		0.025	TCS-6	Two lane with PS (Retaining wall in pond location)			
22	33.665	33.980		0.315	TCS-1	Two lane with Paved Shoulder (New Construction)			
23	33.980	34.000		0.020	TCS-6	Two lane with PS (Retaining wall in pond location)			
24	34.000	35.900		1.900	TCS-1	Two lane with Paved Shoulder (New Construction)			
25	35.900	35.920		0.020	TCS-6	Two lane with PS (Retaining wall in pond location)			
26	35.920	36.350		0.430	TCS-1	Two lane with Paved Shoulder (New Construction)			
27	36.350	36.460		0.110	TCS-2	Two lane with PS over exisitng road			
	To	tal	0.100	11.110					
				9825	TCS-1	Two lane with Paved Shoulder			
				110	TCS-2	Two lane with PS over exisitng road			
				900	TCS-3	Two lane with PS with RCC drain			
				0	TCS-4	Two lane with PS (with Protection Works)			
				0	TCS-5	Two lane with PS with Protections Works (Both Side)			
275 TCS-6 Two lane with Paved Shoulder				Two lane with Paved Shoulder					



CONSULTANCY SERVICES FOR FEASIBILITY STUDY, PREPARATION OF DETAILED PROJECT REPORT AND PROVIDING PRE-CONSTRUCTION SERVICES FOR UP-GRADATION OF SELECTED ROAD STRETCHES / CORRIDORS TO TWO LANE WITH PAVED SHOULDER NH CONFIGURATION UNDER BHARAT MALA PROJECT AND NATIONAL HIGHWAYS CONNECTIVITY TO BACKWARD AREAS/RELIGIOUS/TOURIST PLACES OF THE COUNTRY IN THE STATE OF TRIPURA.

KAILASHAHAR - KURTI BRIDGE SECTION-3






NATIONAL HIGHWAYS & INFRASTRUCTURE DEVELOPMENT CORPORATION LTD


WIDENING SCHEME OF KAILASHAHAR - KURTI BRIDGE SECTION Drawing No. :-TASPL/NHIDCL/DDPR/WS 01 OF 01 NTS Scale Drn Dgn. Appd Date Deepak B.Mishra B.S.Pandey DEC - 2019

CONSULTANT:




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TYPE-1 TWO LANE WITH PAVED SHOULDER (New Construction)

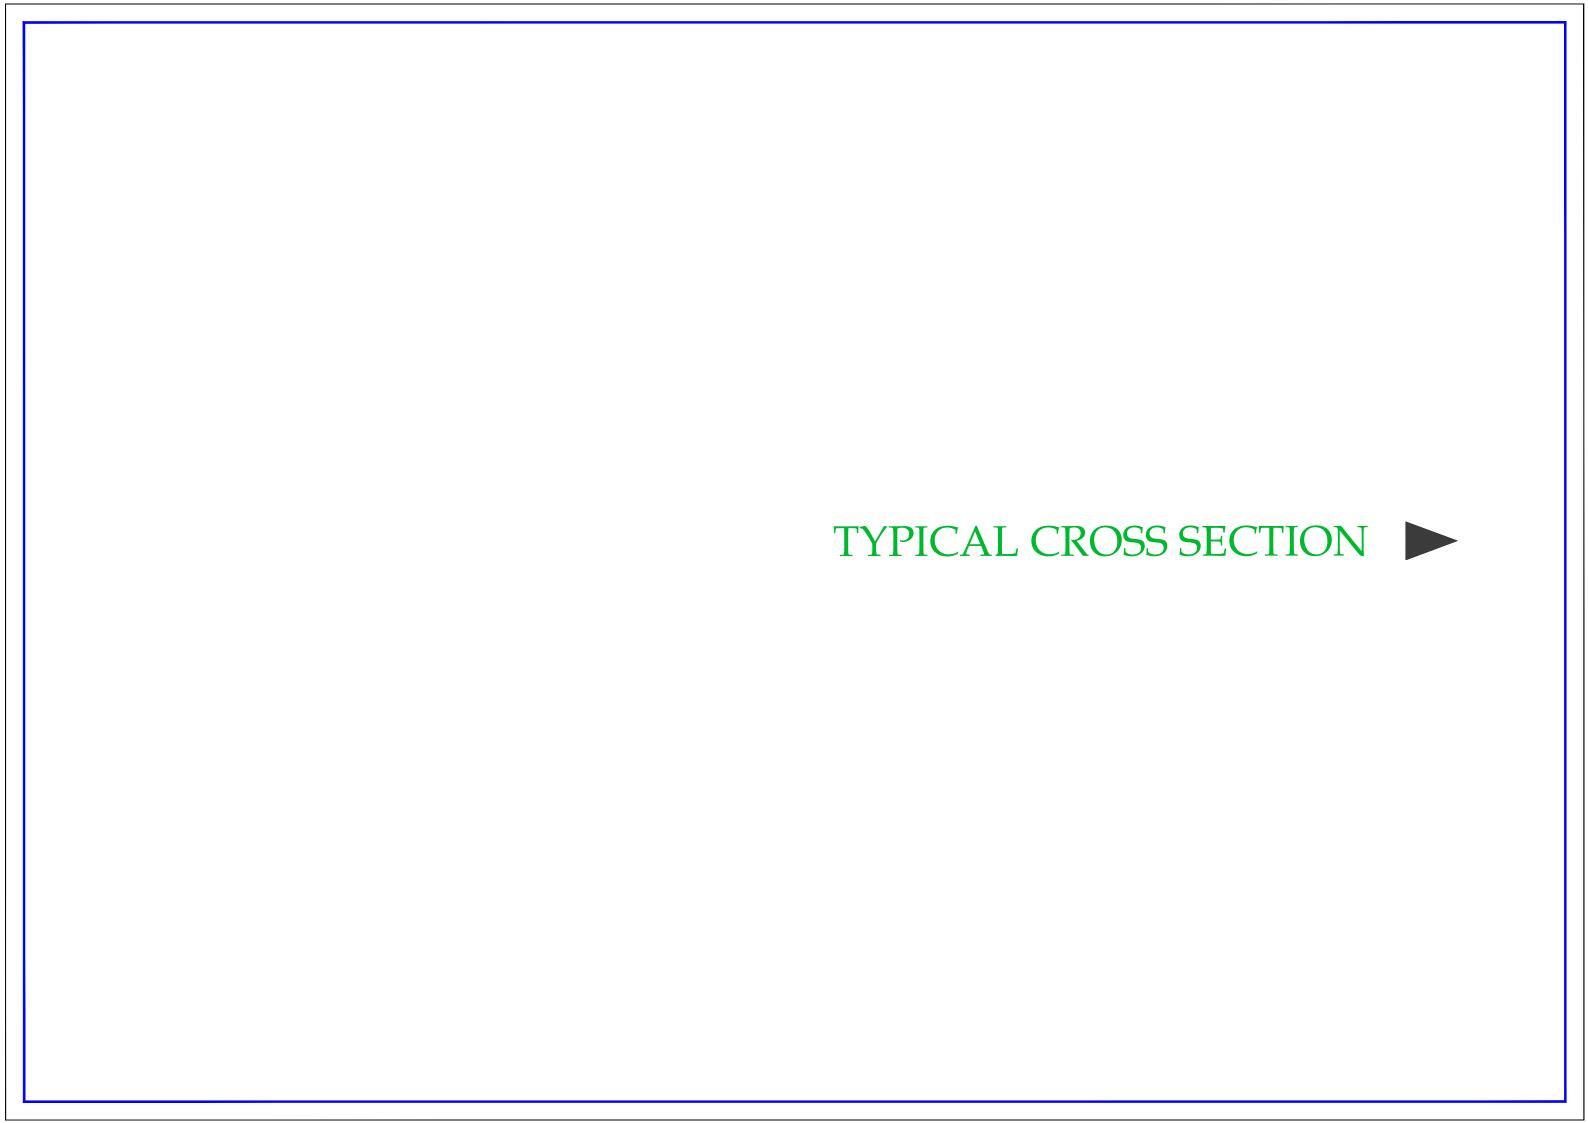

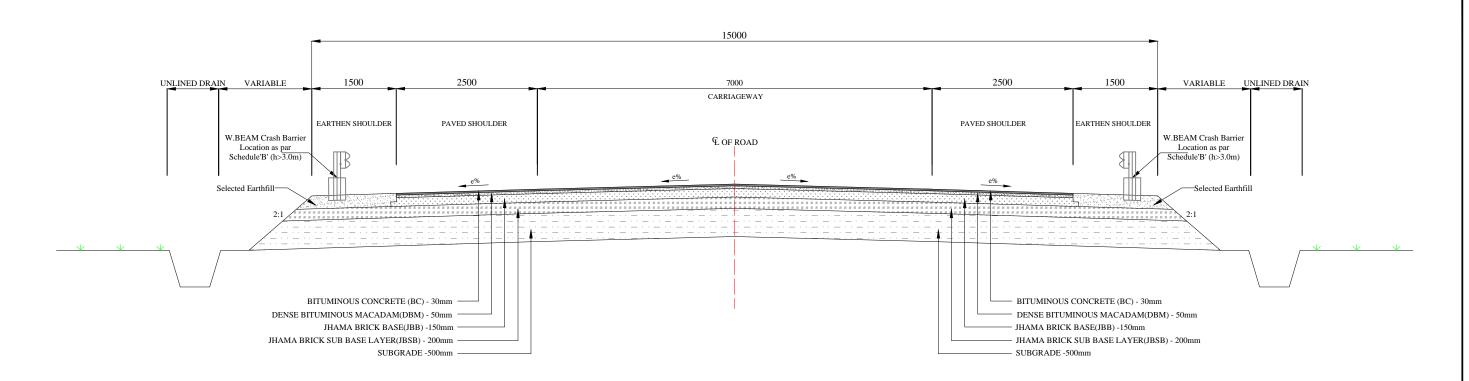TYPE- 2 TWO LANE WITH PAVED SHOULDER OVER EXISTING ROAD

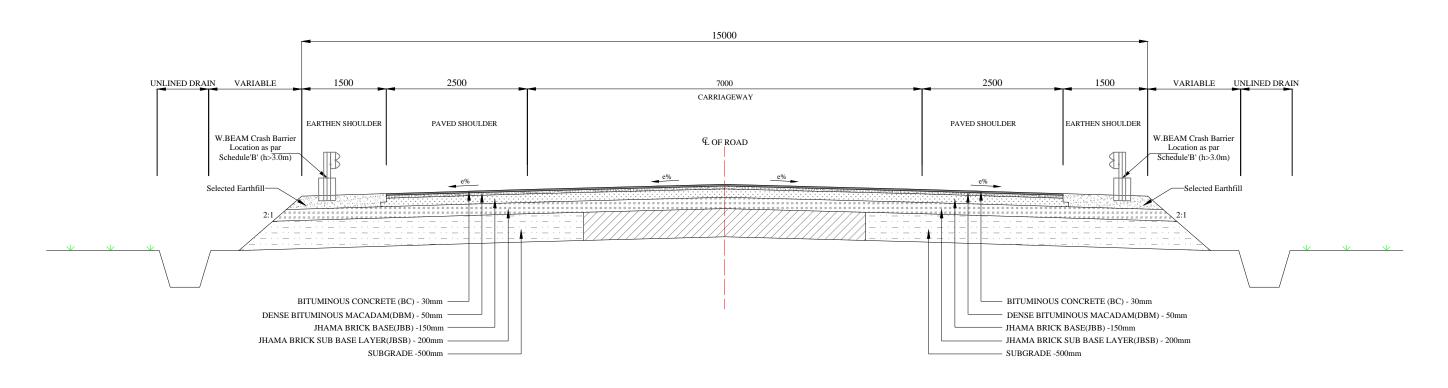

CONSULTANCY SERVICES FOR FEASIBILITY STUDY, PREPARATION OF DETAILED PROJECT REPORT AND PROVIDING PRE-CONSTRUCTION SERVICES FOR UP-GRADATION OF SELECTED ROAD STRETCHES / CORRIDORS TO TWO LANE WITH PAVED SHOULDER NH CONFIGURATION UNDER BHARAT MALA PROJECT AND NATIONAL HIGHWAYS CONNECTIVITY TO BACKWARD AREAS/RELIGIOUS/TOURIST PLACES OF THE COUNTRY IN THE STATE OF TRIPURA.


KAILASHAHAR - KURTI BRIDGE SECTION-3




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Deepak	B.Mishra	B.S.Pandey	DEC- 2019	

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echnocrats Advisory Services Private Limited in association with Vaishnavi Infratech Services P. Ltd 68,Ajanta Apartsments, 36, I.P. Extension Patparganj Delhi-110092.

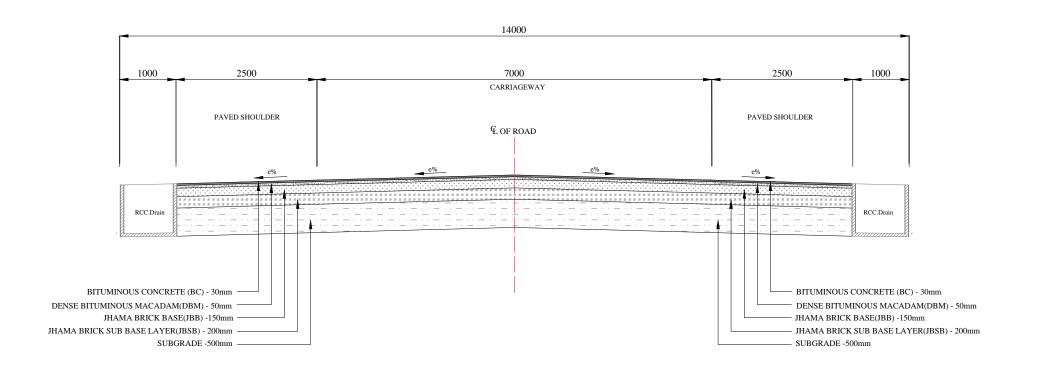

TYPE- 3 TWO LANE WITH PAVED SHOULDER WITH RCC DRAIN (Built-up Section)

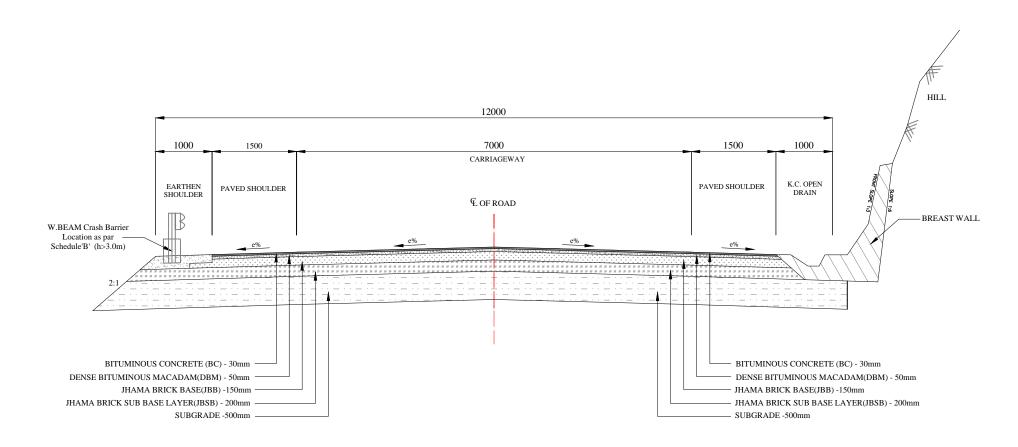

TYPE- 4 TWO LANE WITH PAVED SHOULDER (WITH PROTECTIONS WORKS)



CONSULTANCY SERVICES FOR FEASIBILITY STUDY, PREPARATION OF DETAILED PROJECT REPORT AND PROVIDING PRE-CONSTRUCTION SERVICES FOR UP-GRADATION OF SELECTED ROAD STRETCHES / CORRIDORS TO TWO LANE WITH PAVED SHOULDER NH CONFIGURATION UNDER BHARAT MALA PROJECT AND NATIONAL HIGHWAYS CONNECTIVITY TO BACKWARD AREAS/RELIGIOUS/TOURIST PLACES OF THE COUNTRY IN THE STATE OF TRIPURA.


KAILASHAHAR - KURTI BRIDGE SECTION-3




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Deepak	B.Mishra	B.S.Pandey	DEC- 2019	

Technocrats Advisory Services Private Limited in association with Vaishnavi Infratech Services P. Ltd.

hnocrats Advisory Services Private Limiter in association with Vaishnavi Infratech Services P. Ltd 68,Ajanta Apartsments, 36, I.P. Extension Patparganj Delhi-110092.

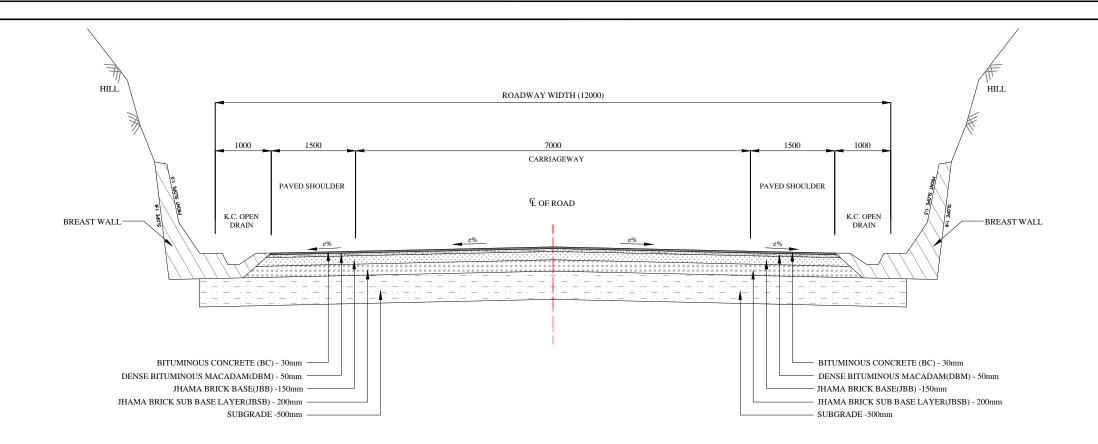

TYPE- 5 TWO LANE WITH PAVED SHOULDER (WITH PROTECTIONS WORKS (Both Side)

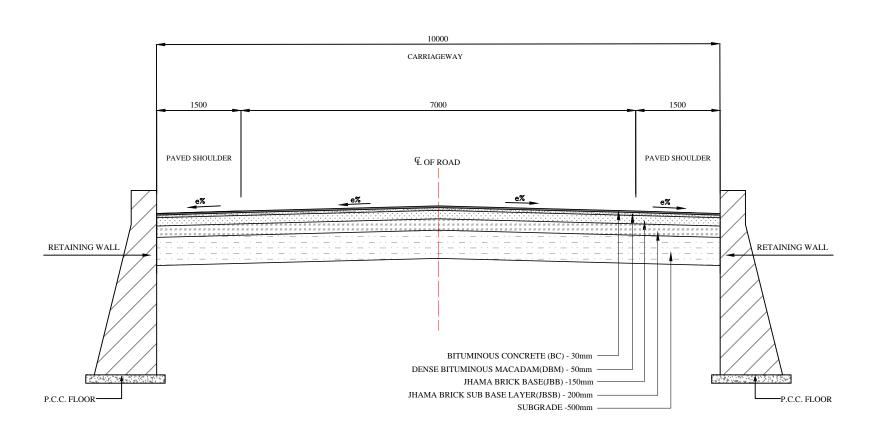



Project Title:

CONSULTANCY SERVICES FOR FEASIBILITY STUDY, PREPARATION OF DETAILED PROJECT REPORT AND PROVIDING PRE-CONSTRUCTION SERVICES FOR UP-GRADATION OF SELECTED ROAD STRETCHES / CORRIDORS TO TWO LANE WITH PAVED SHOULDER NH CONFIGURATION UNDER BHARAT MALA PROJECT AND NATIONAL HIGHWAYS CONNECTIVITY TO BACKWARD AREAS/RELIGIOUS/TOURIST PLACES OF THE COUNTRY IN THE STATE OF TRIPURA.

KAILASHAHAR - KURTI BRIDGE SECTION-3




NATIONAL HIGHWAYS & INFRASTRUCTURE DEVELOPMENT CORPORATION LTD

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Deepak	B.Mishra	B.S.Pandey	DEC- 2019	

CONSULTANT:

TASPL

Technocrats Advisory Services Private Limited in association with Vaishnavi Infratech Services P. Ltd 68,Ajanta Apartsments, 36, I.P. Extension Patparganj Delhi-110092.

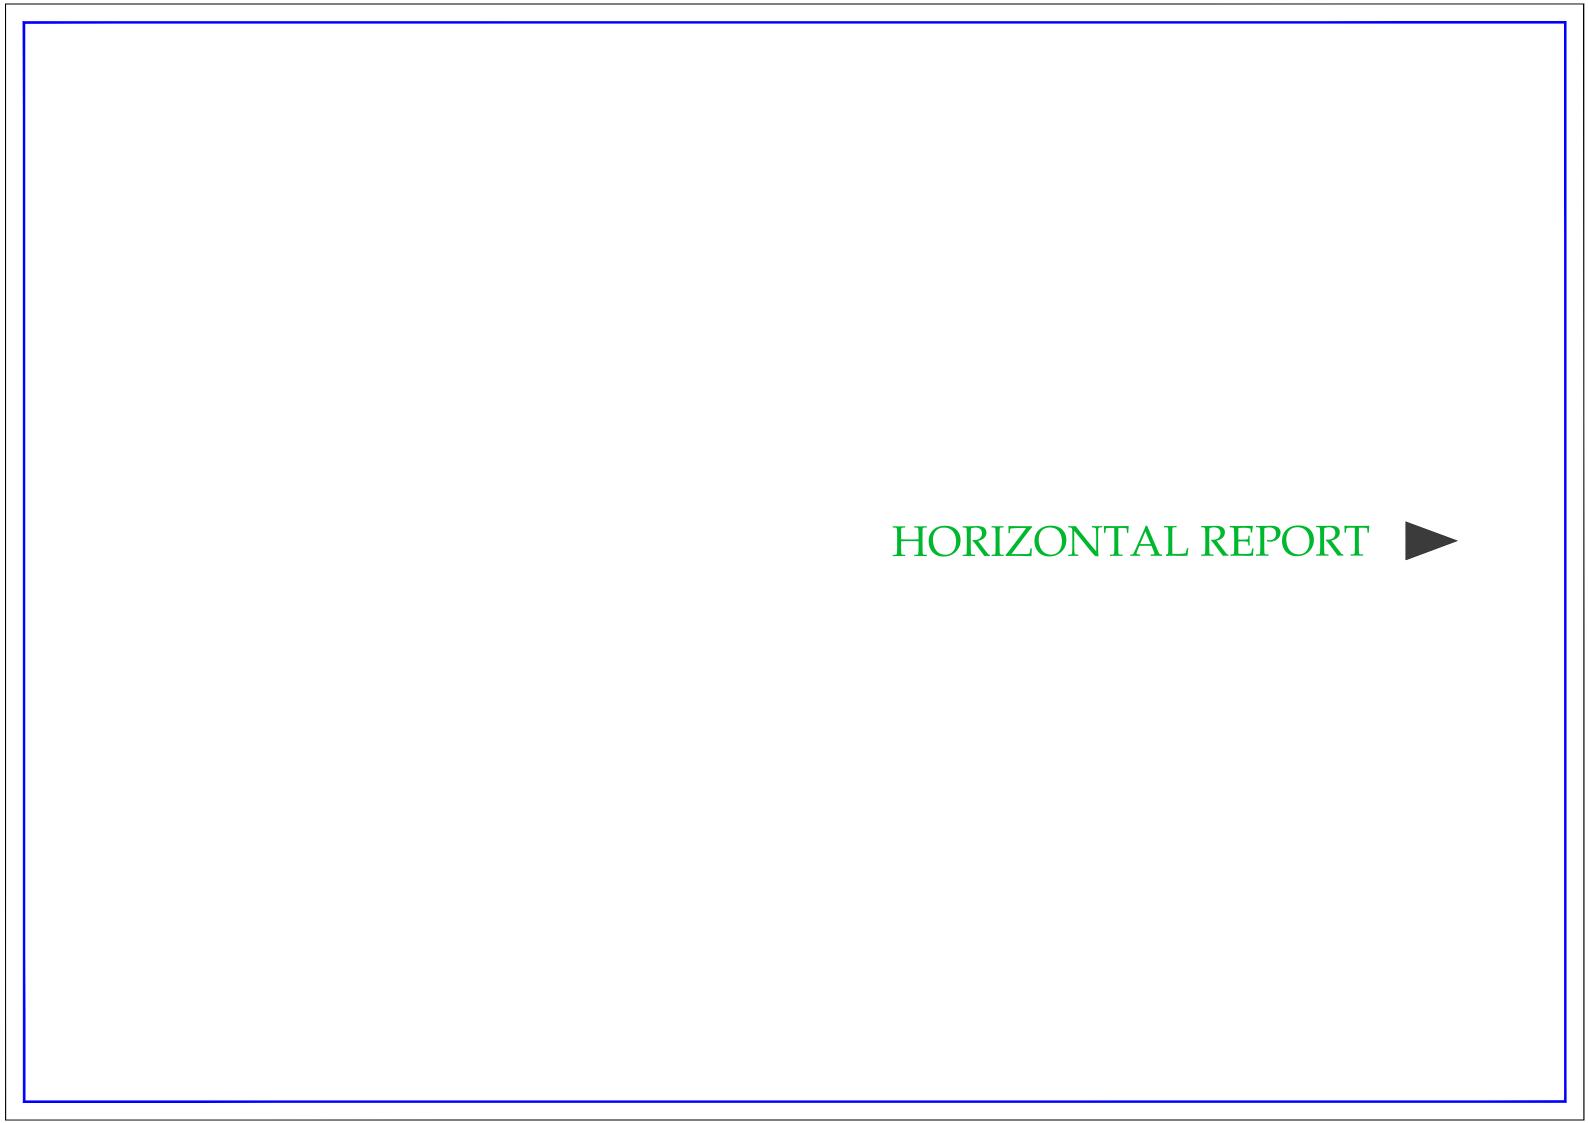

	HORIZONTAL ALIGNMENT REPORT [Kailashahar-Kurtibridge]															
0	HORIZONTAL CURVE							Horizontal Intersection Point (HIP)			Horizontal Intersection Point (HIP)			Transitio	Speed	
Curve No.	Start Chainage	End Chainage	Start Easting	Start Northing	End Easting	End Northing	Radius	Directio n	Terrain	Chainage	Easting	Northing	n length	(Kmph)	Reason for Deviation	
67	27+543.180	28+585.812	415944.26	2700487.101	416820.748	2700989.256	1200	Left	Plain	28+099.972	416499.002	2700534.836	40	100		
68	29+910.493	30+108.152	417568.281	2702082.861	417671.556	2702251.3	2000	Left	Plain	30+009.403	417624.084	2702164.527	0	100		
69	32+687.508	32+888.275	418909.529	2704514.152	419014.559	2704685.155	2000	Right	Plain	32+787.976	418957.749	2704602.292	0	100		
70	33+807.510	34+281.224	419534.897	2705442.931	419945.459	2705641.81	500	Right	Plain	34+063.834	419689.201	2705647.608	45	80		
71	34+573.590	34+946.789	420237.229	2705623.404	420579.649	2705748.622	500	Left	Plain	34+769.364	420432.953	2705618.976	45	80		
72	35+186.728	35+406.087	420753.78	2705913.648	420943.16	2706021.907	600	Right	Plain	35+297.646	420838.463	2705985.282	80	100		
73	36+209.167	36+344.682	421716.308	2706238.907	421834.146	2706304.51	400	Left	Plain	36+277.580	421780.837	2706261.631	55	80		



CONSULTANCY SERVICES FOR FEASIBILITY STUDY, PREPARATION OF DETAILED PROJECT REPORT AND PROVIDING PRE-CONSTRUCTION SERVICES FOR UP-GRADATION OF SELECTED ROAD STRETCHES / CORRIDORS TO TWO LANE WITH PAVED SHOULDER NH CONFIGURATION UNDER BHARAT MALA PROJECT AND NATIONAL HIGHWAYS CONNECTIVITY TO BACKWARD AREAS/RELIGIOUS/TOURIST PLACES OF THE COUNTRY IN THE STATE OF TRIPURA.

KAILASHAHAR - KURTI BRIDGE SECTION-3





NATIONAL HIGHWAYS & INFRASTRUCTURE DEVELOPMENT CORPORATION LTD

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Deepak	B.Mishra	B.S.Pandey	DEC - 2019		

CONSULTANT:



Technocrats Advisory Services Private Limited in association with Vaishnavi Infratech Services P. Ltd 68,Ajanta Apartsments, 36, I.P. Extension Patparganj Delhi-110092.



	VERTICAL ALIGNMENT REPORT [Kailashahar-Kurtibridge]										
PVI	PVI		Curve	Gradient		Chaina	Chainage(m)		el (m)	Т Об	
No	Design Chainage (m)	Level (m)	Length	IN	OUT	OUT Start of Curve End of Curve	End of Curve	Start of Curve	End of Curve	Type Of Curve	K Value
42	25+529.679	23.091	250	-0.44	-0.469	25+404.679	25+654.679	23.641	22.504	Hog	8581.369
43	26+040.476	20.693	200	-0.469	0.745	25+940.476	26+140.476	21.162	21.438	Sag	164.636
44	26+350.000	23	200	0.745	0	26+250.000	26+450.000	22.255	23	Hog	268.335
45	26+650.000	23	250.063	0	-0.254	26+524.969	26+775.031	23	22.682	Hog	982.597
46	27+099.131	21.857	300	-0.254	0.326	26+949.131	27+249.131	22.239	22.346	Sag	517.015
47	27+450.000	23	200	0.326	0	27+350.000	27+550.000	22.674	23	Hog	613.944
48	27+750.000	23	250	0	-0.109	27+625.000	27+875.000	23	22.863	Hog	2289.24
49	28+790.555	21.864	300	-0.109	0.692	28+640.555	28+940.555	22.027	22.902	Sag	374.273
50	30+224.518	31.792	550	0.692	0.274	29+949.518	30+499.518	29.888	32.545	Hog	1313.968
51	30+944.078	33.762	200	0.274	-0.677	30+844.078	31+044.078	33.488	33.085	Hog	210.437
52	31+500.000	30	250	-0.677	-0.802	31+375.000	31+625.000	30.846	28.998	Hog	1995.693
53	32+485.951	22.094	200	-0.802	0.358	32+385.951	32+585.951	22.896	22.452	Sag	172.442
54	33+479.304	25.649	350	0.358	-0.23	33+304.304	33+654.304	25.023	25.247	Hog	595.678
55	34+814.504	22.582	250	-0.23	-0.064	34+689.504	34+939.504	22.87	22.502	Sag	1512.026
56	36+127.344	21.738	150	-0.064	1.197	36+052.344	36+202.344	21.786	22.635	Sag	118.963



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KAILASHAHAR - KURTI BRIDGE SECTION-3






NATIONAL HIGHWAYS & INFRASTRUCTURE DEVELOPMENT CORPORATION LTD


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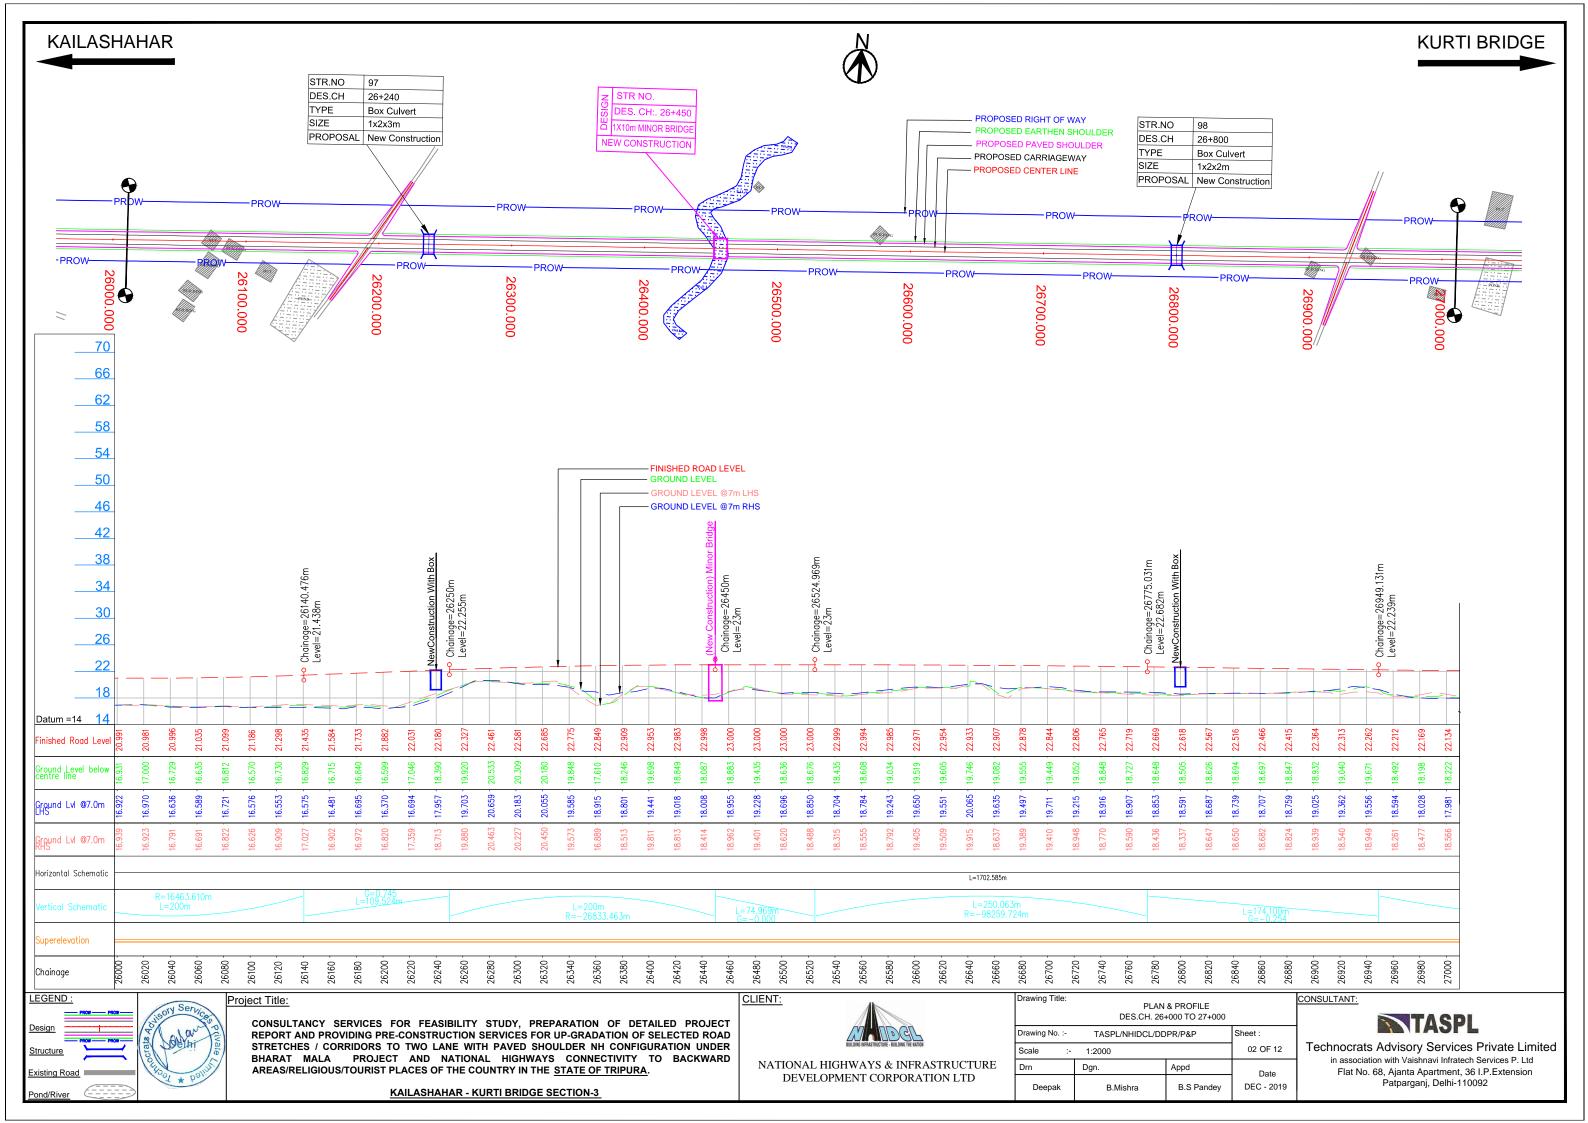
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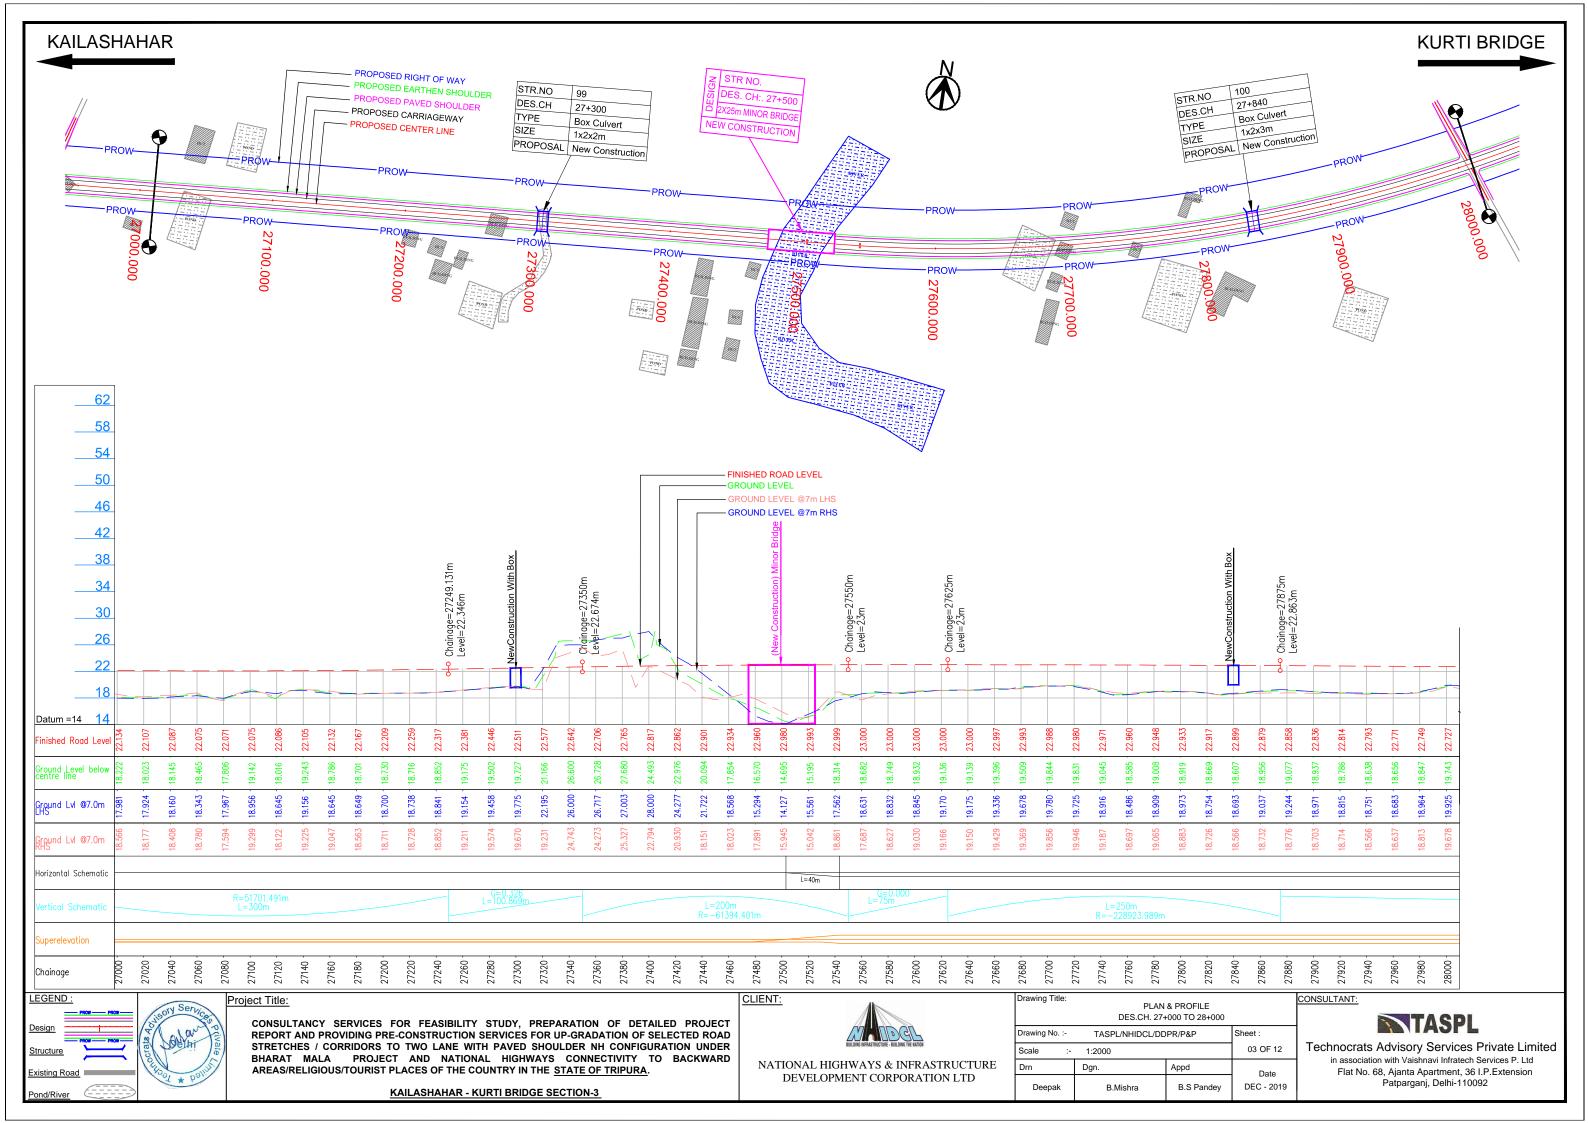



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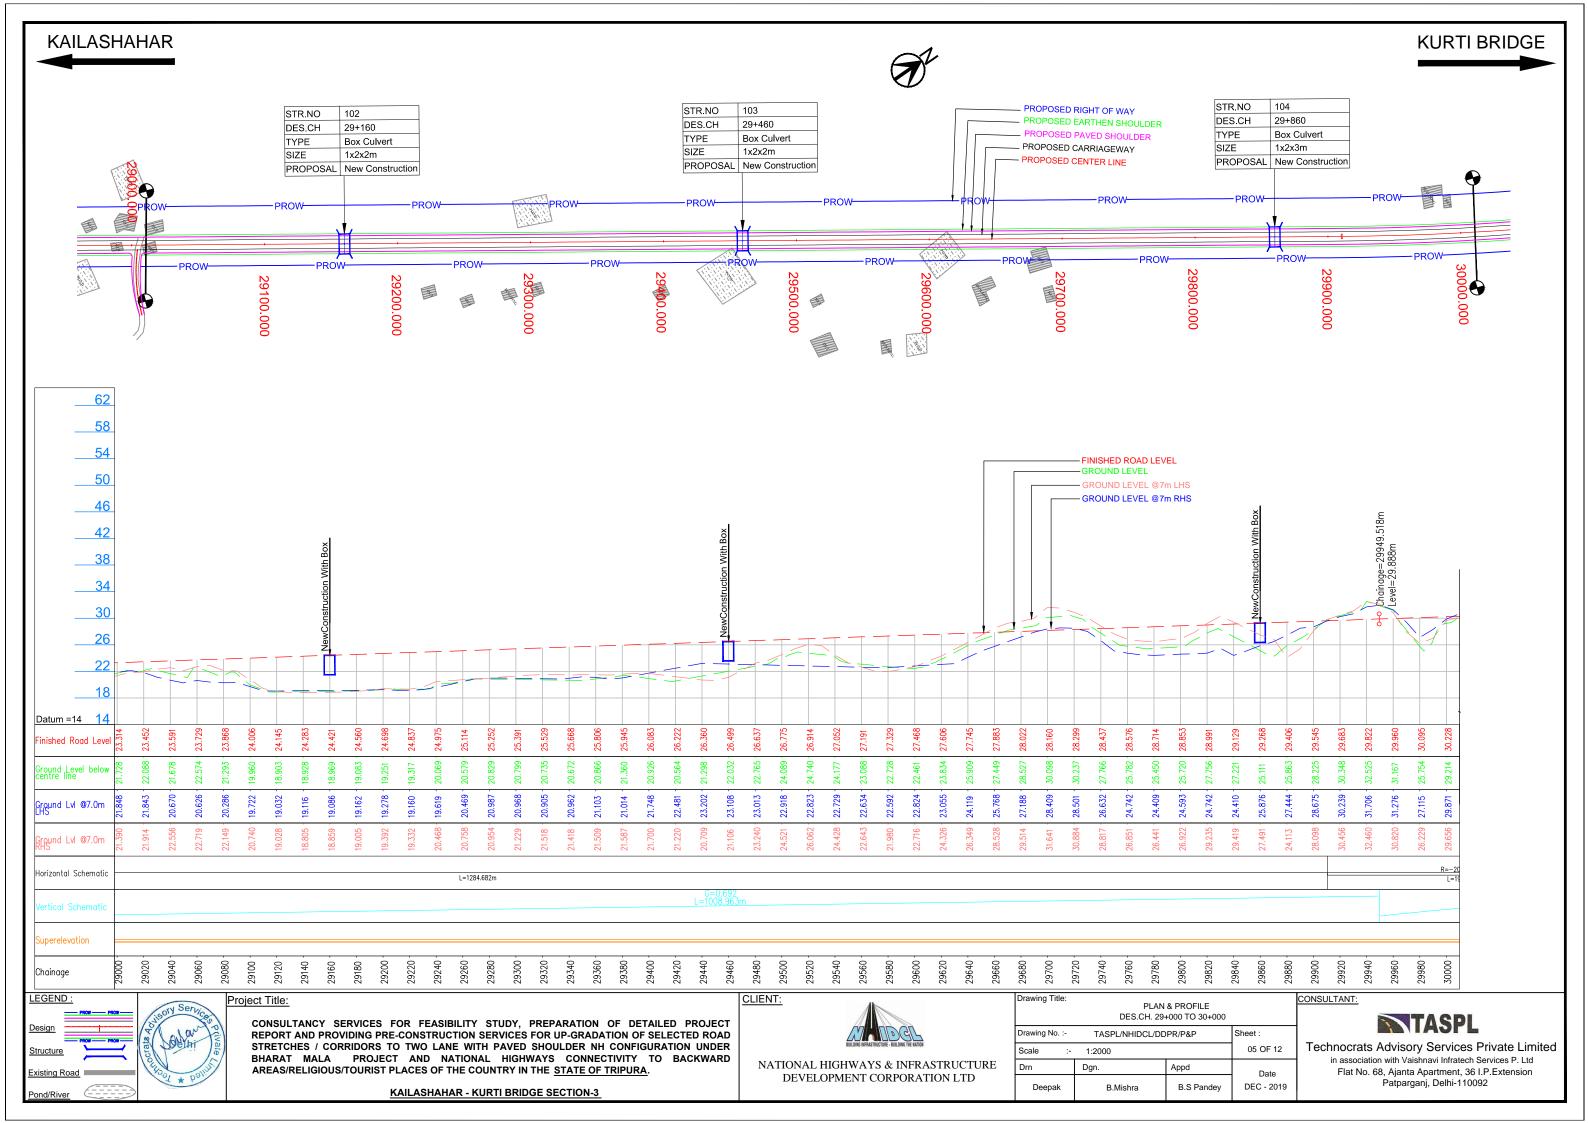








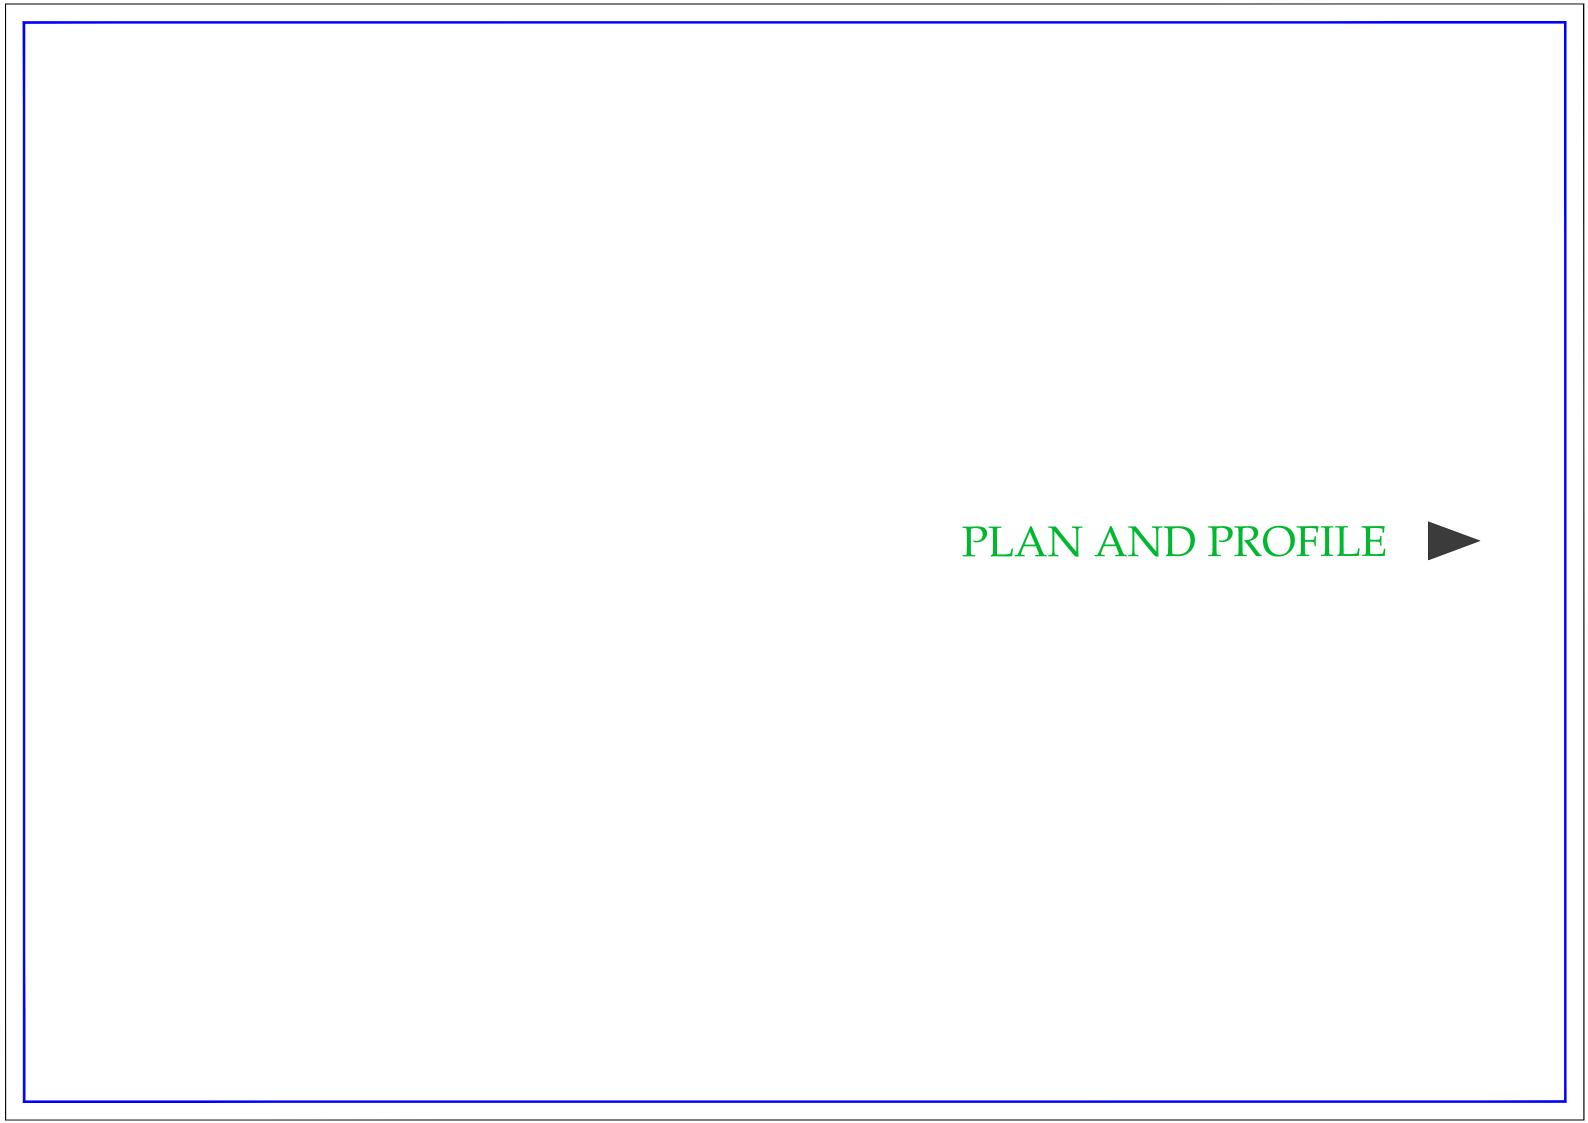


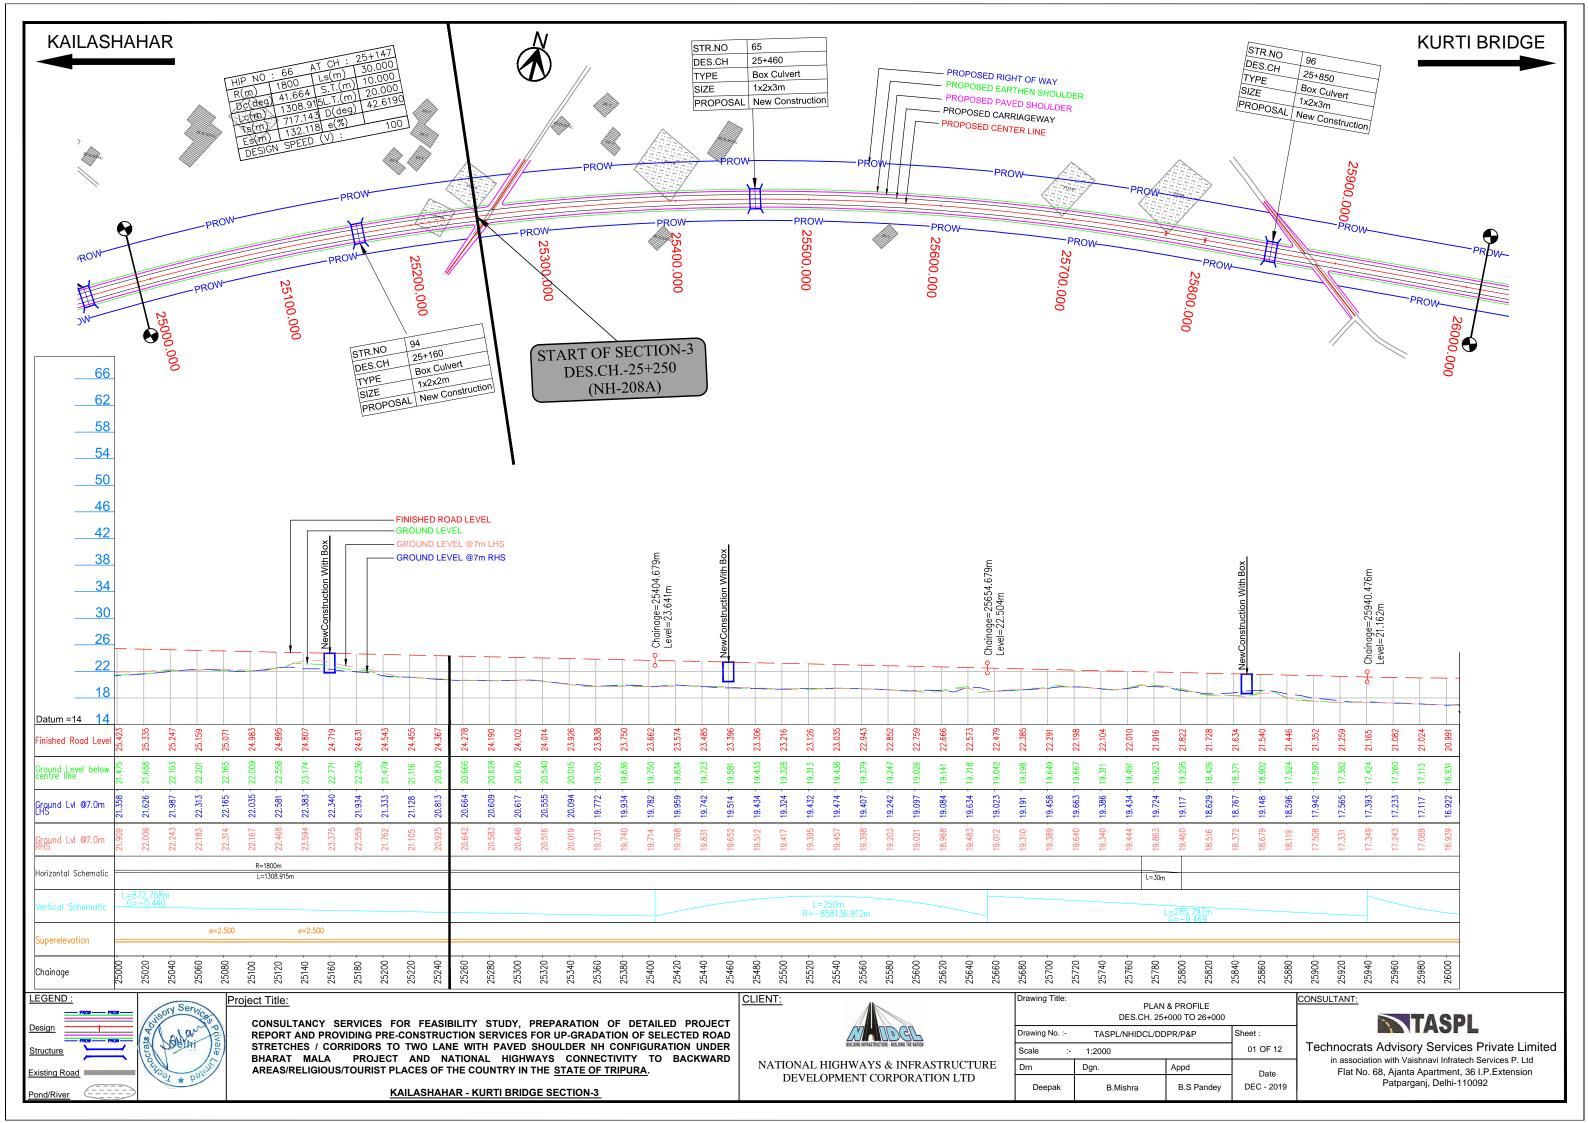


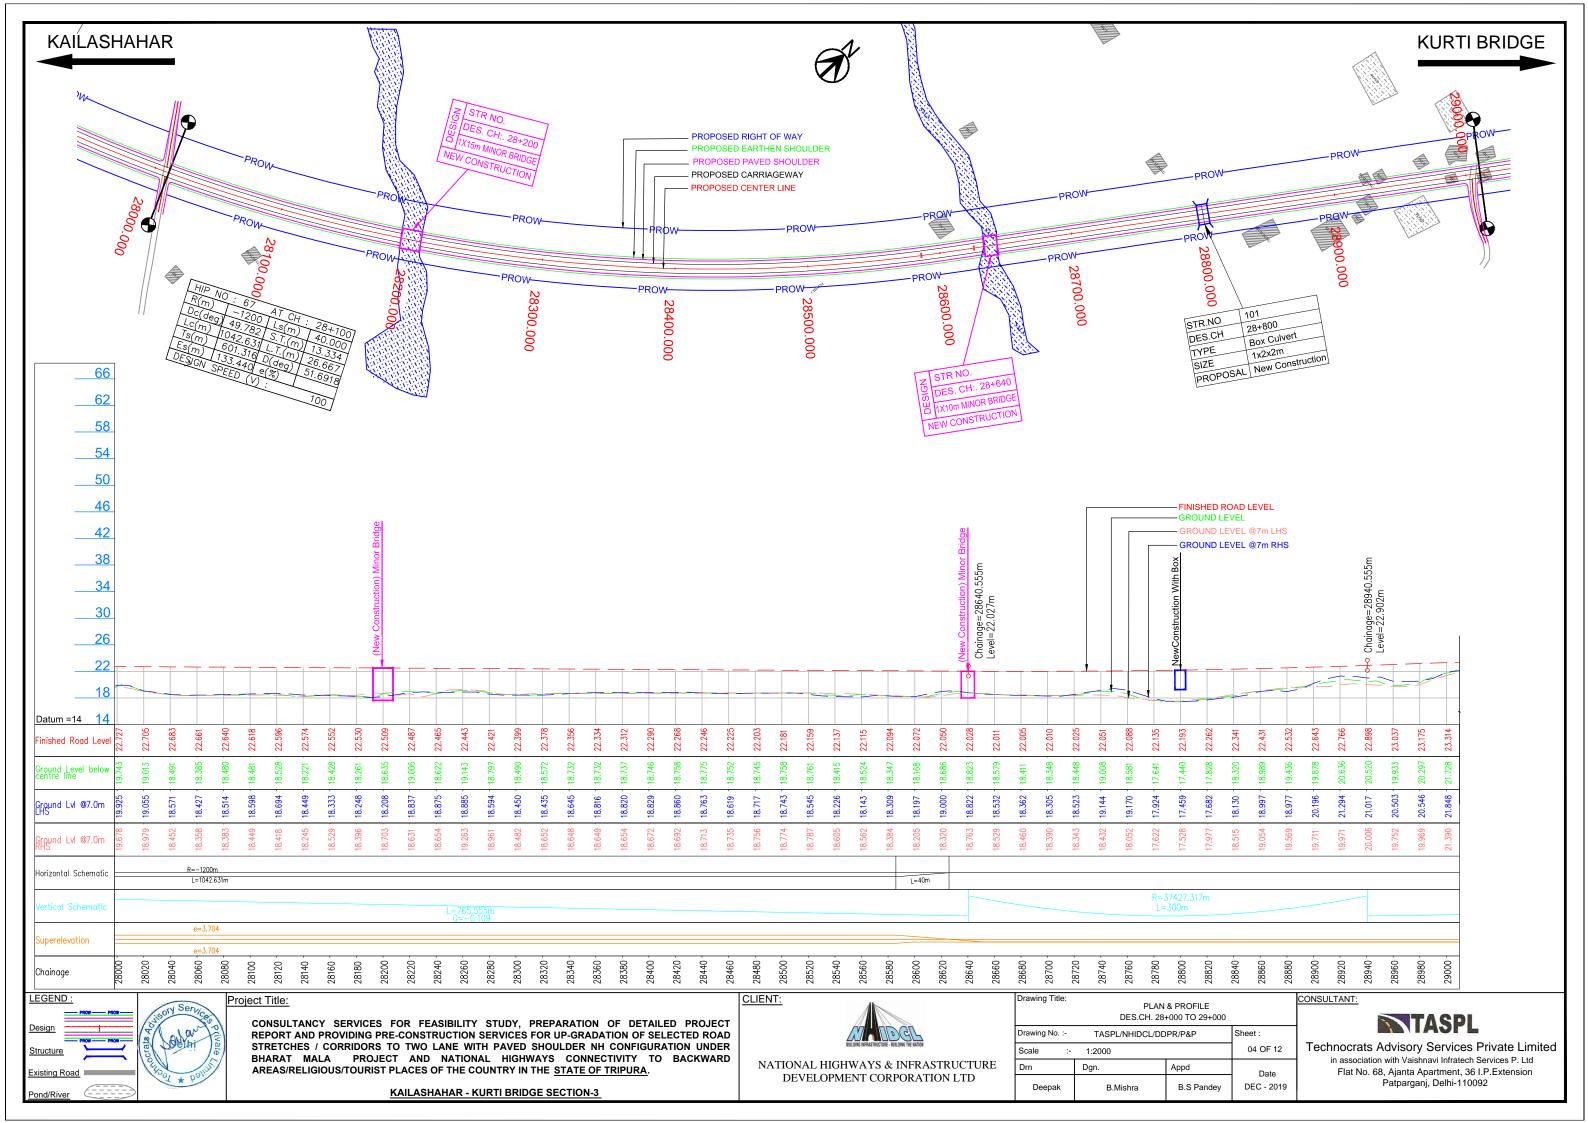


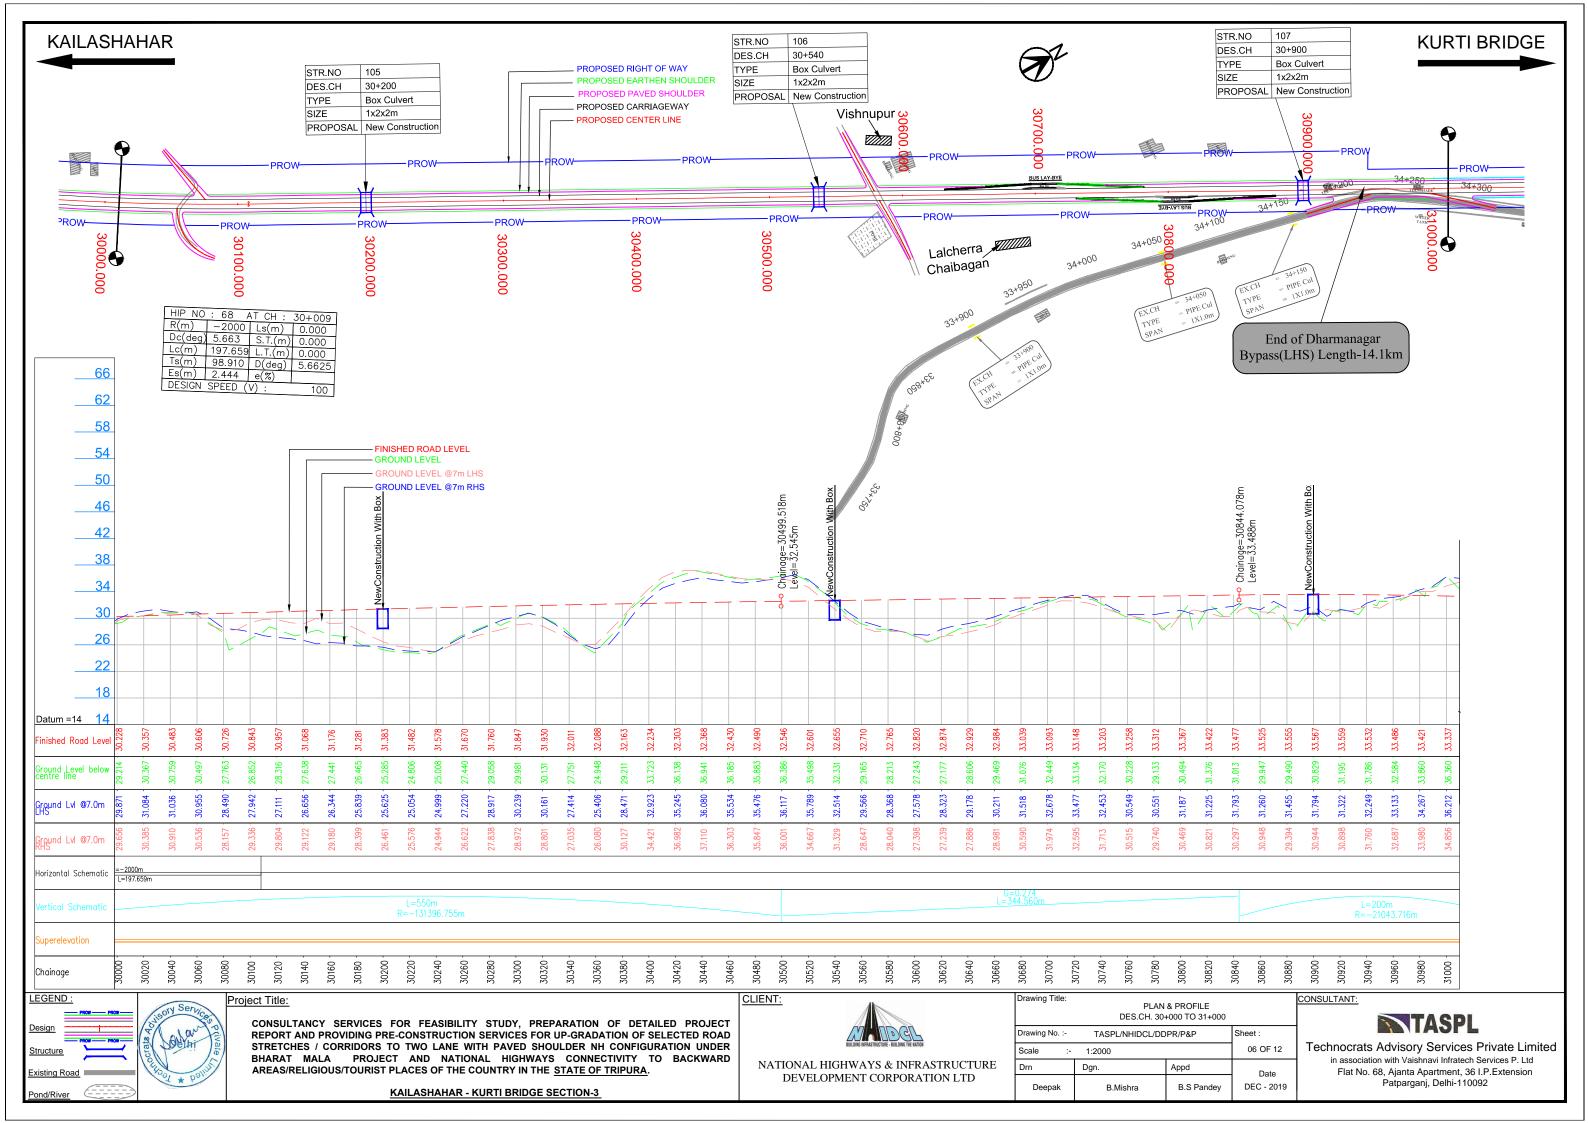


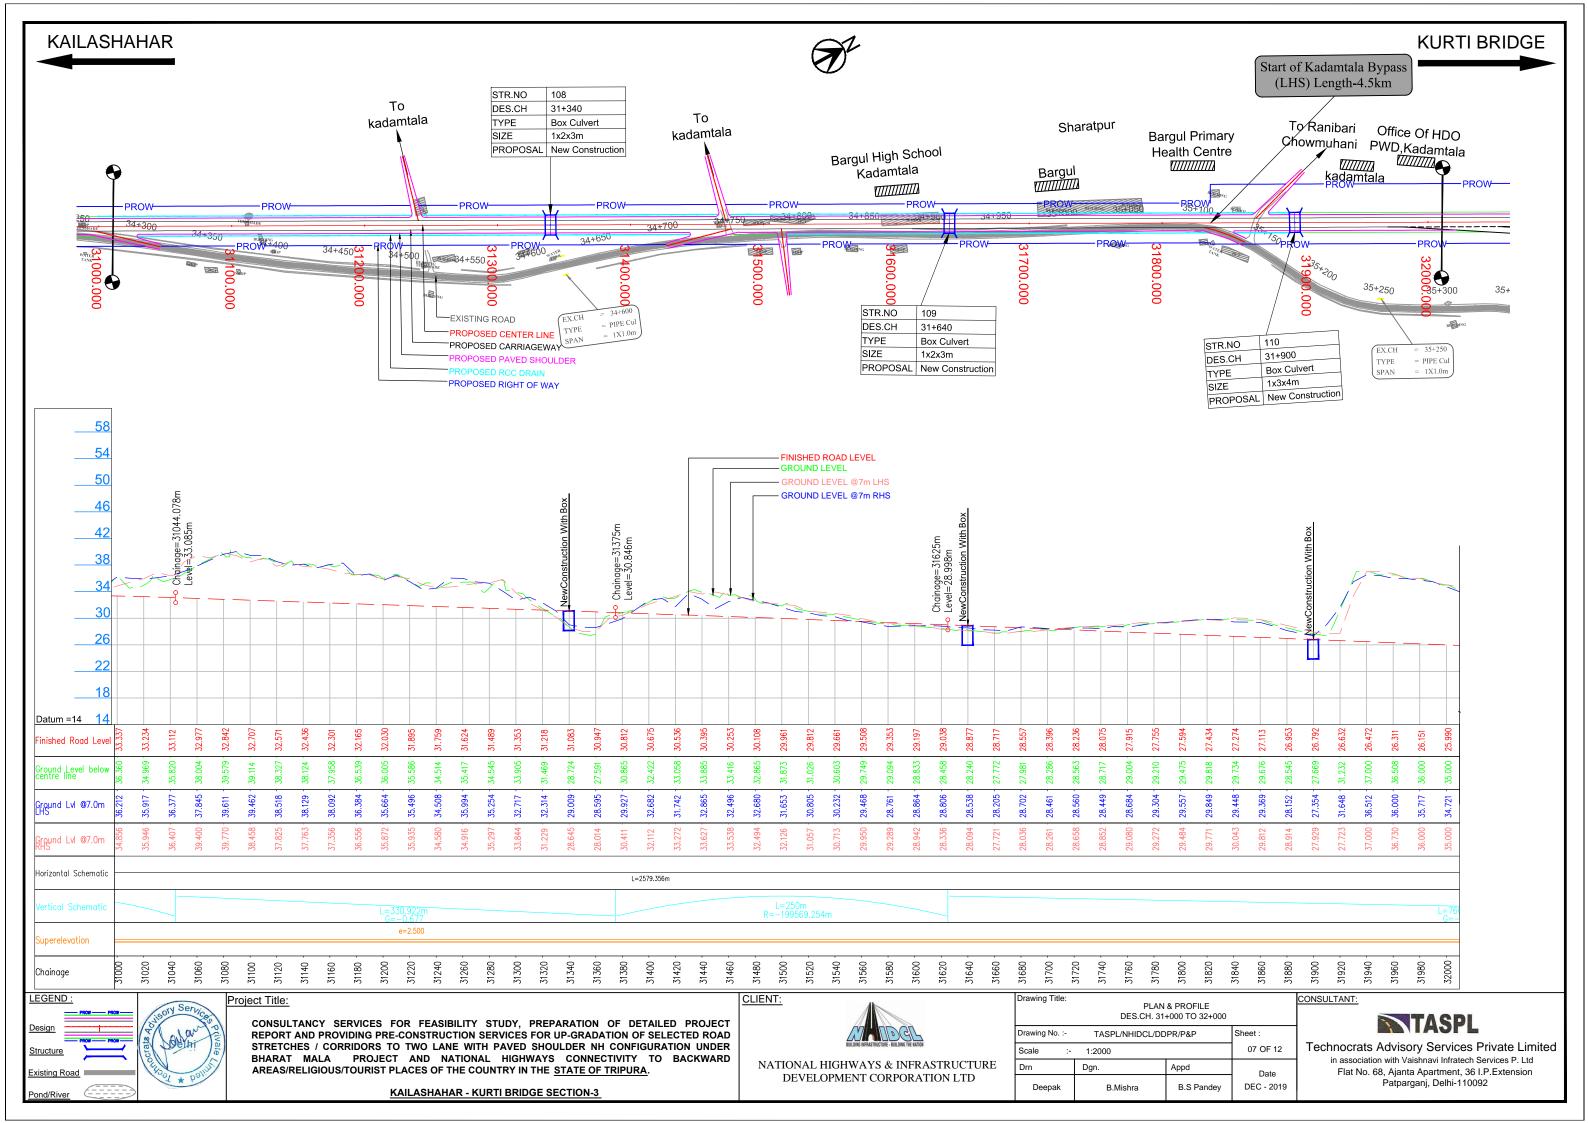


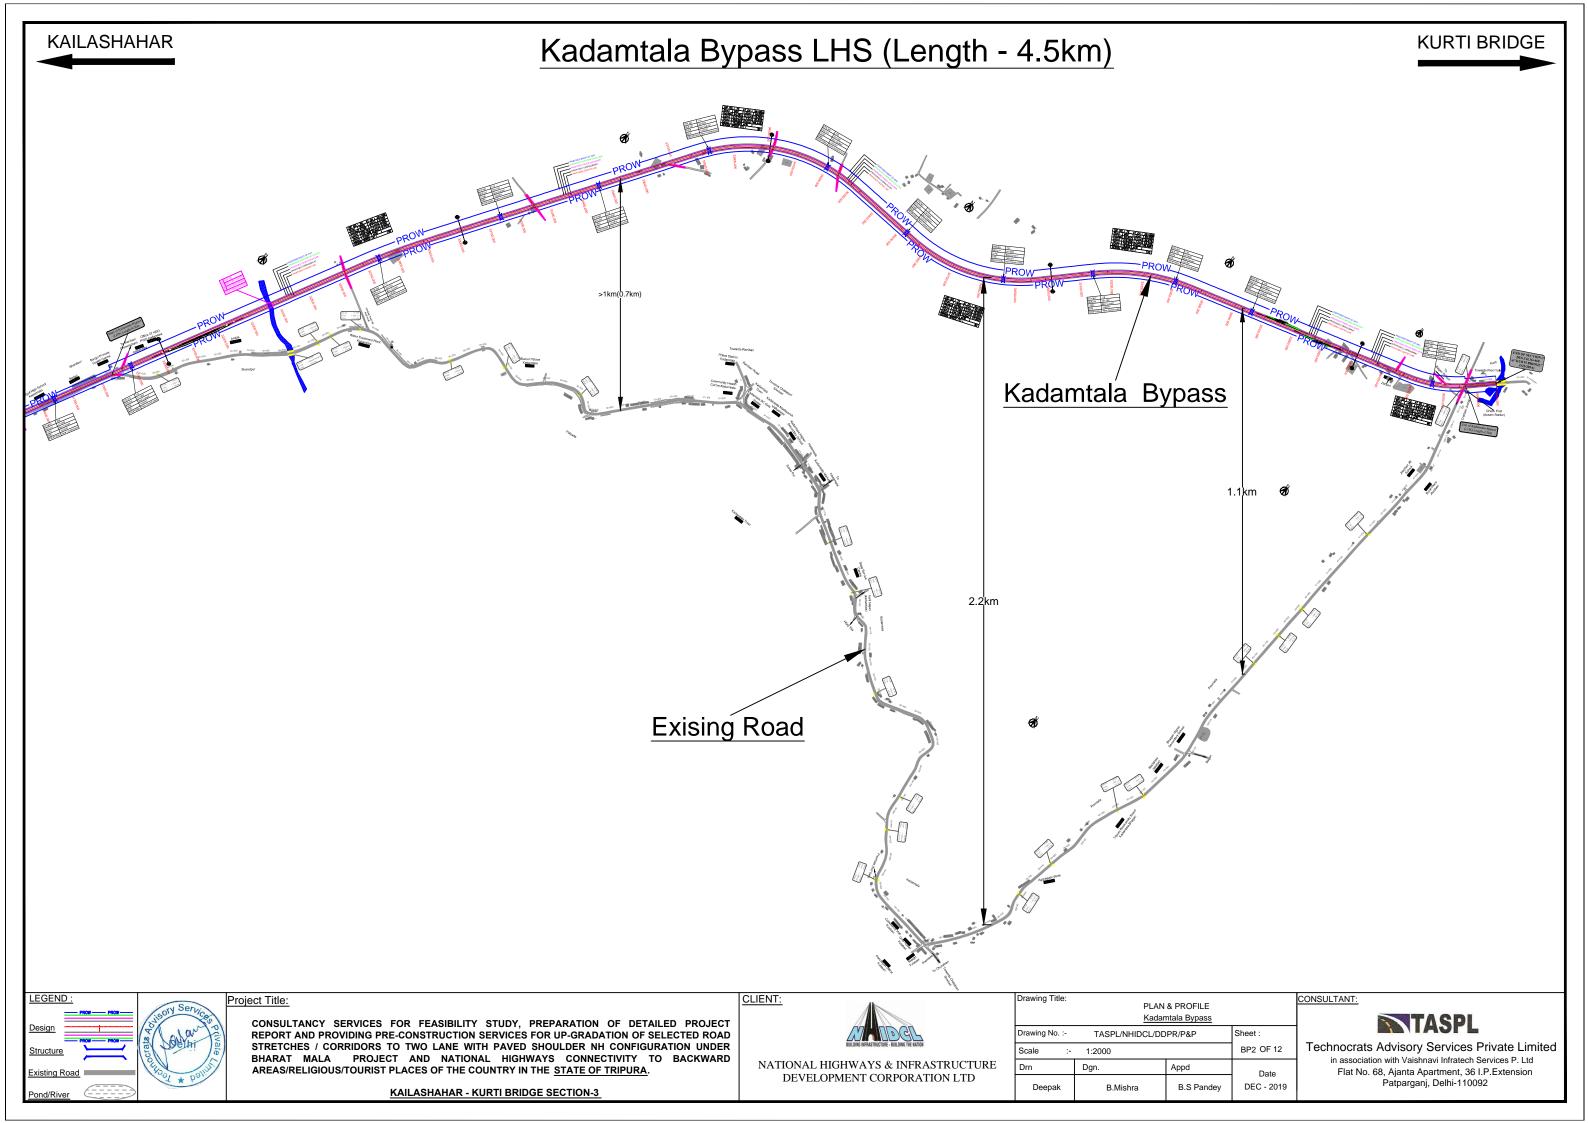


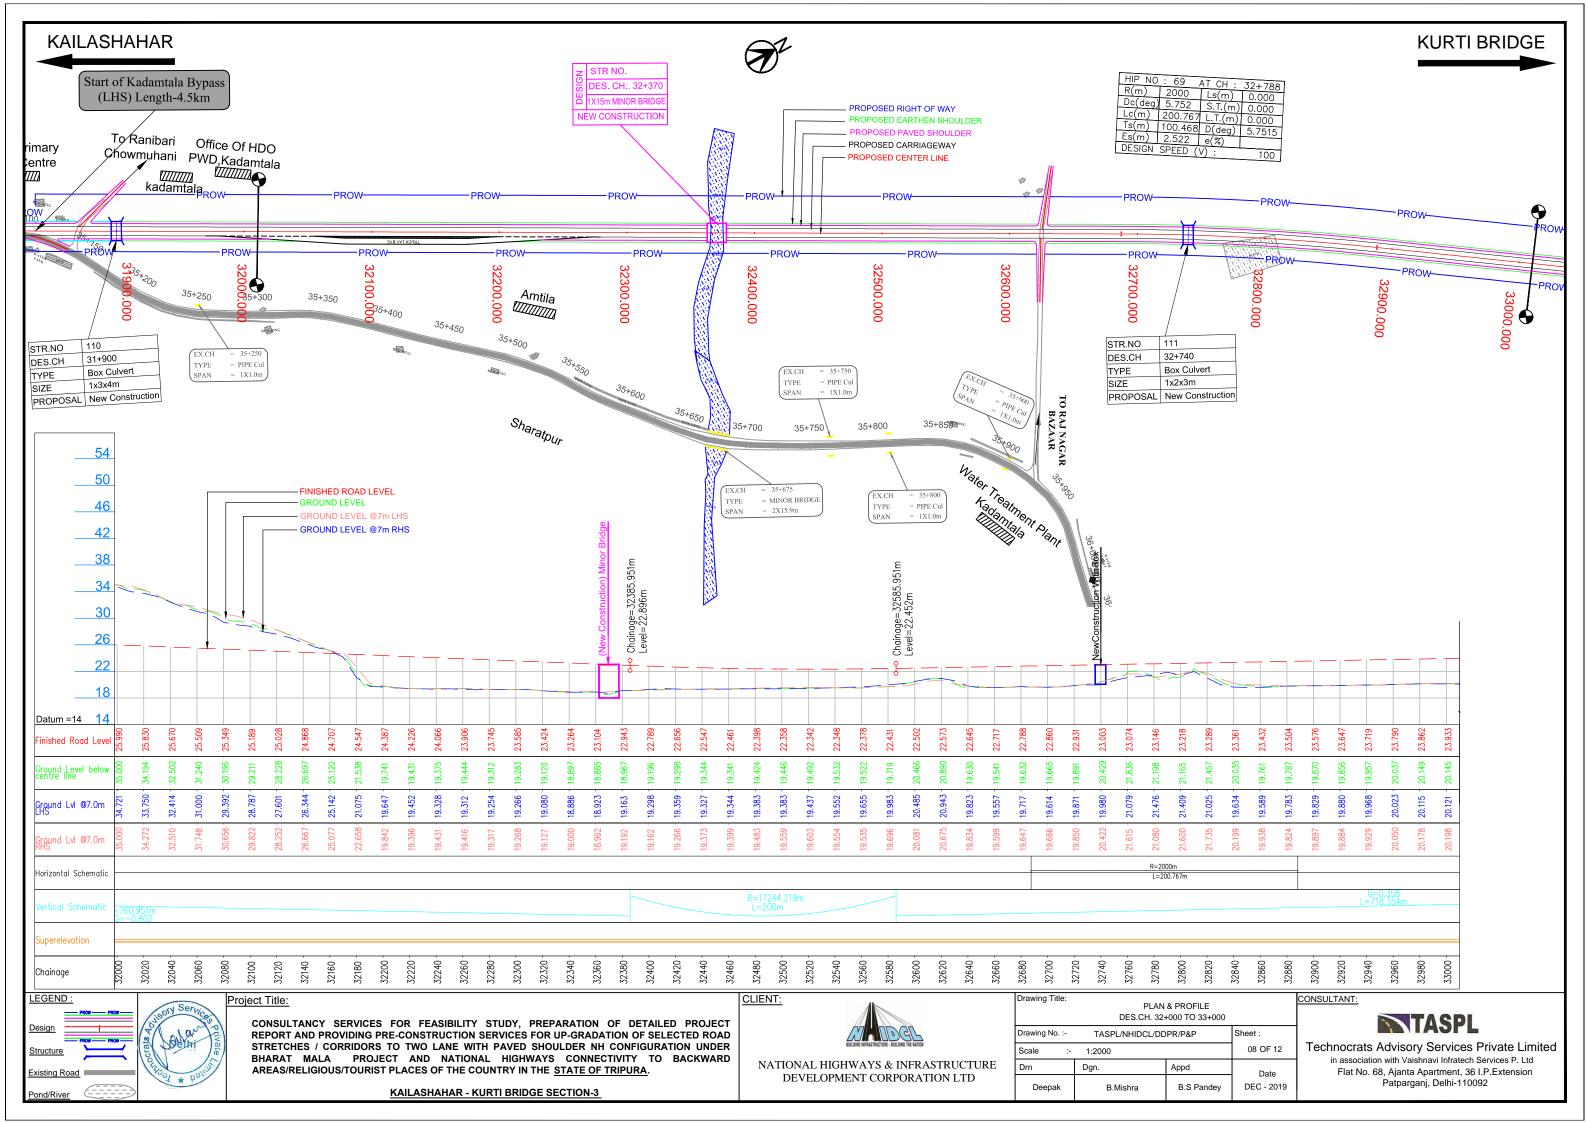

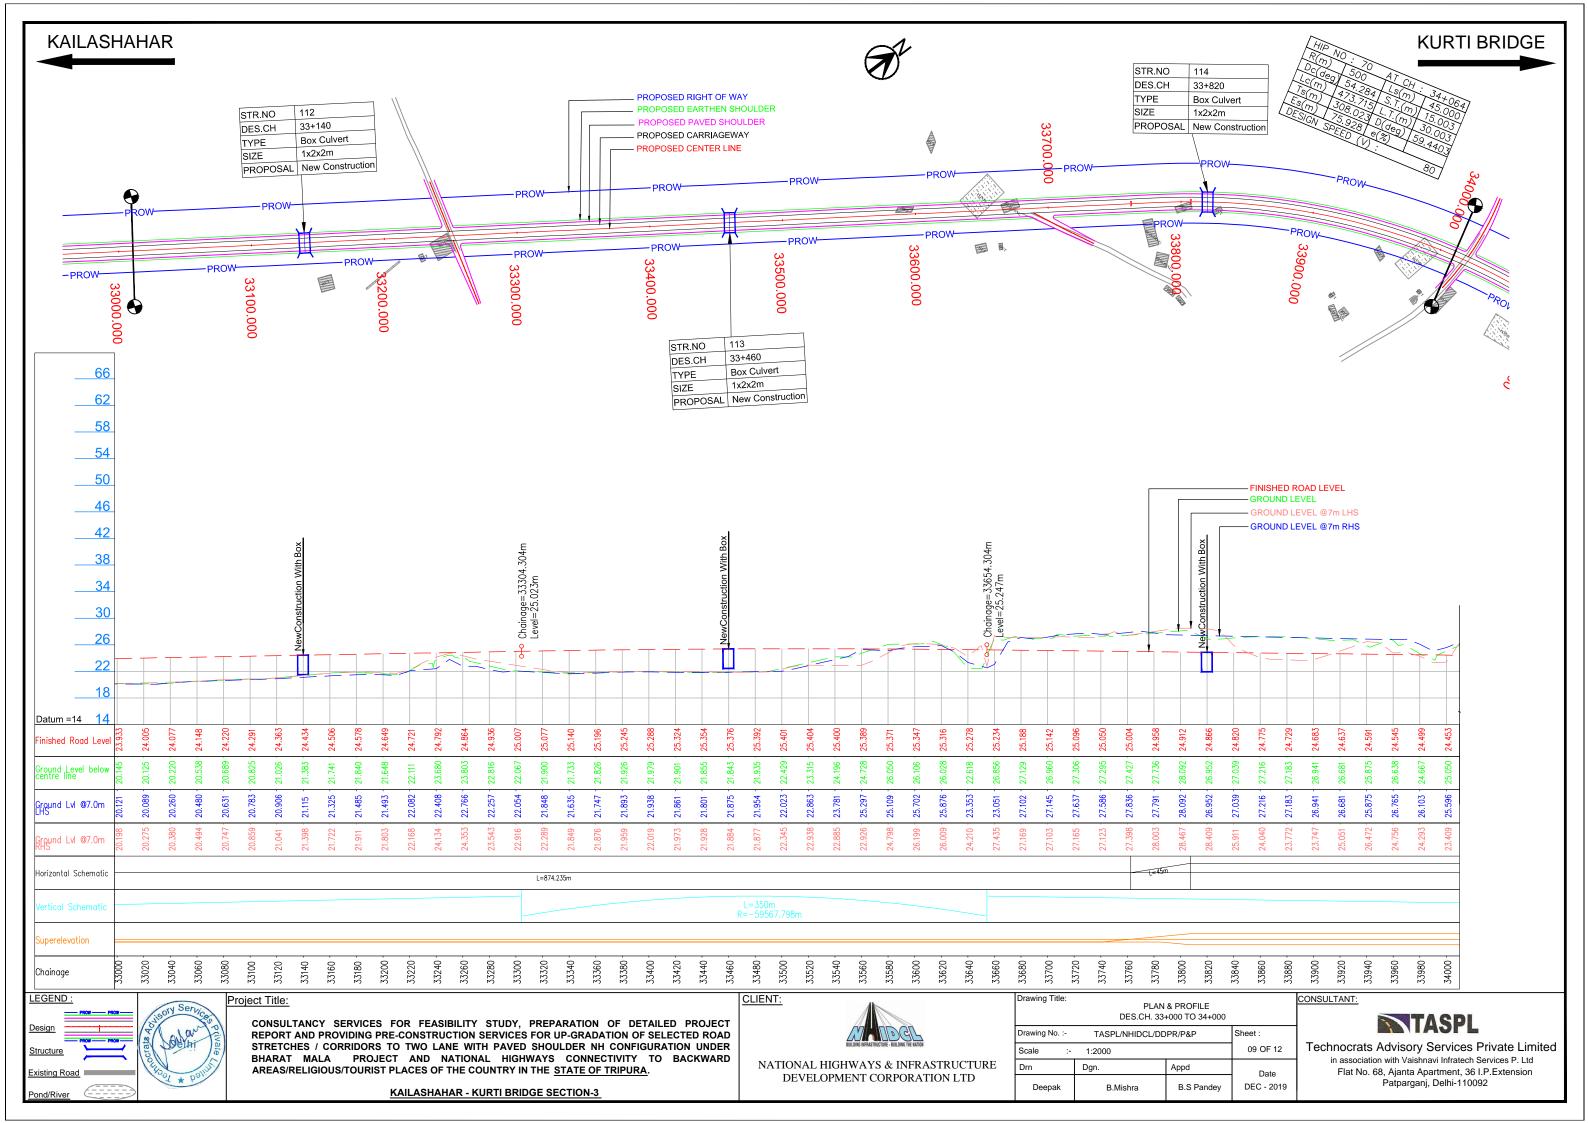

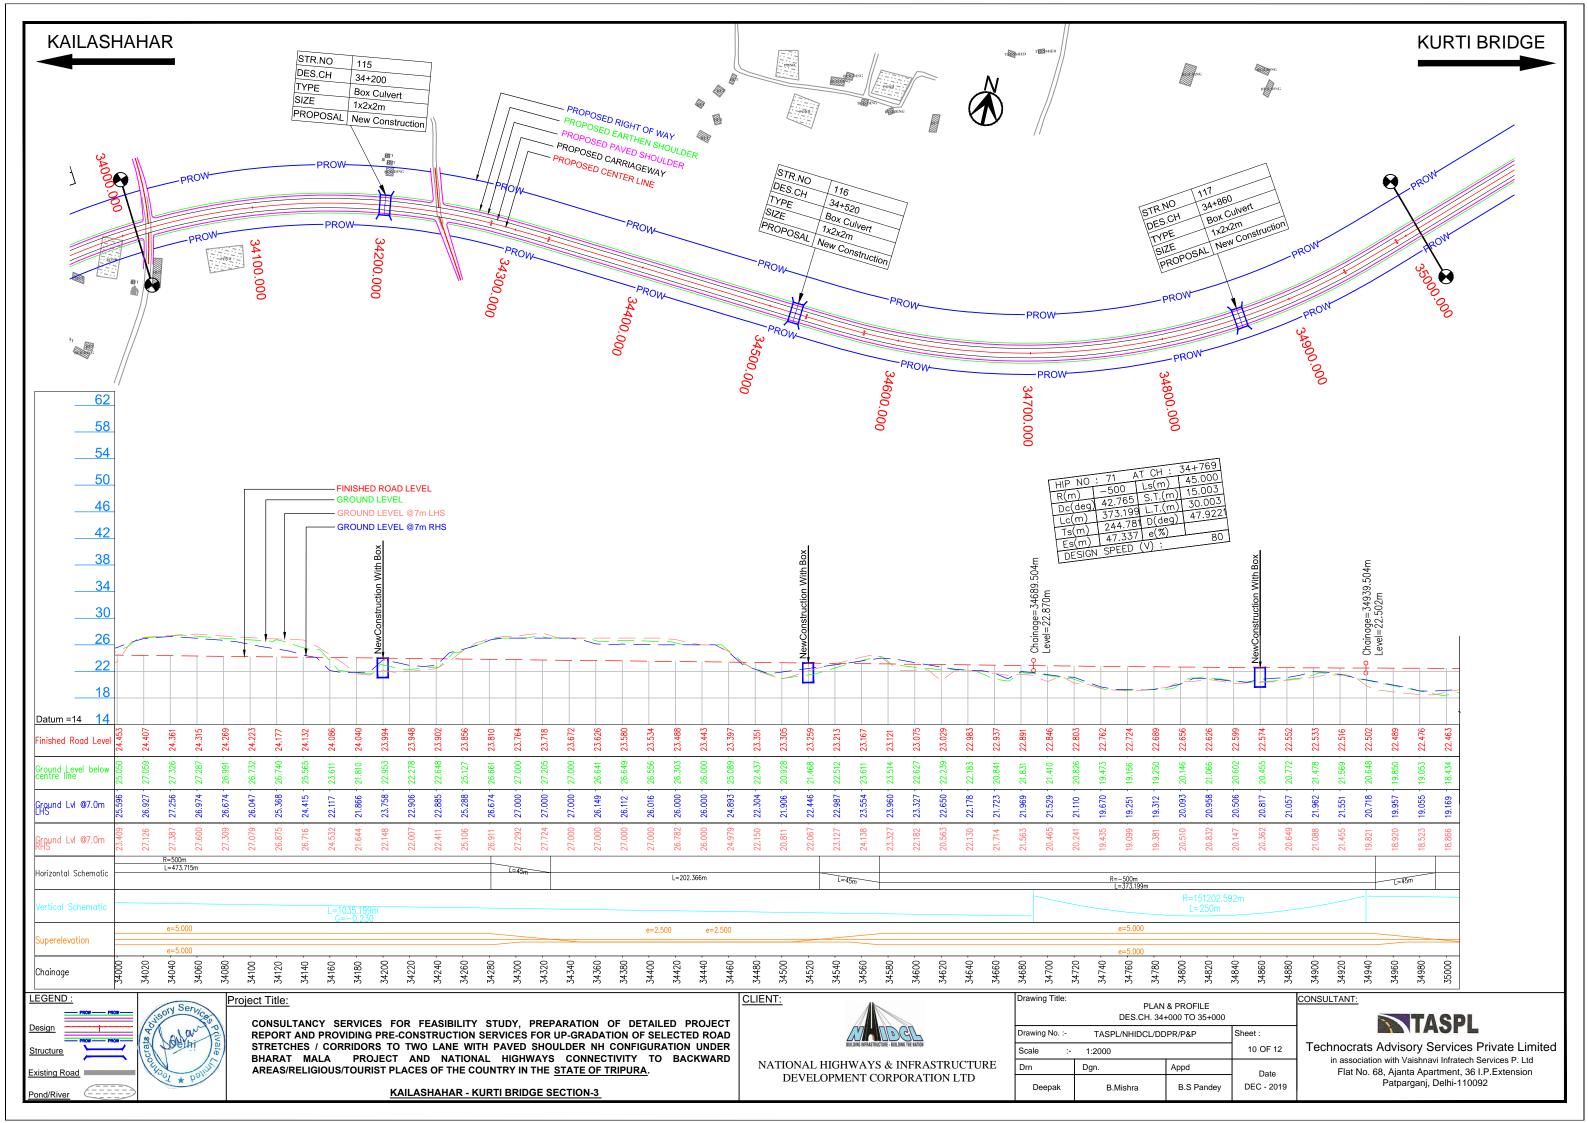


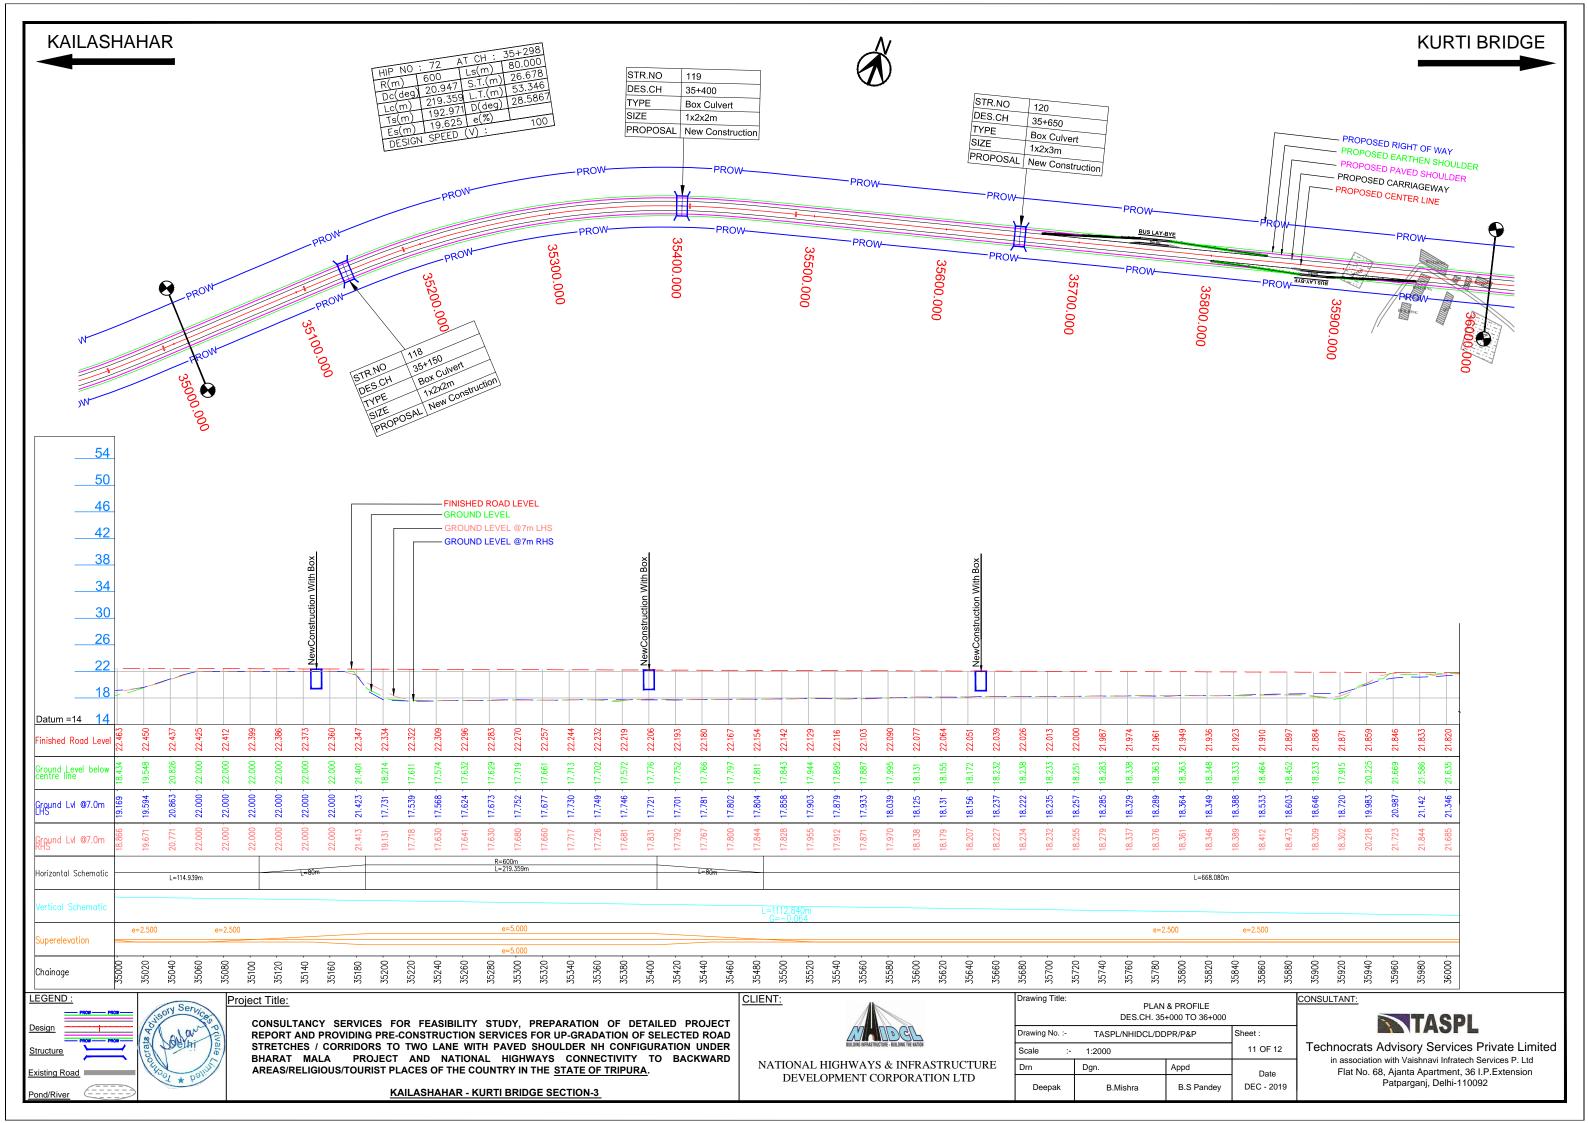


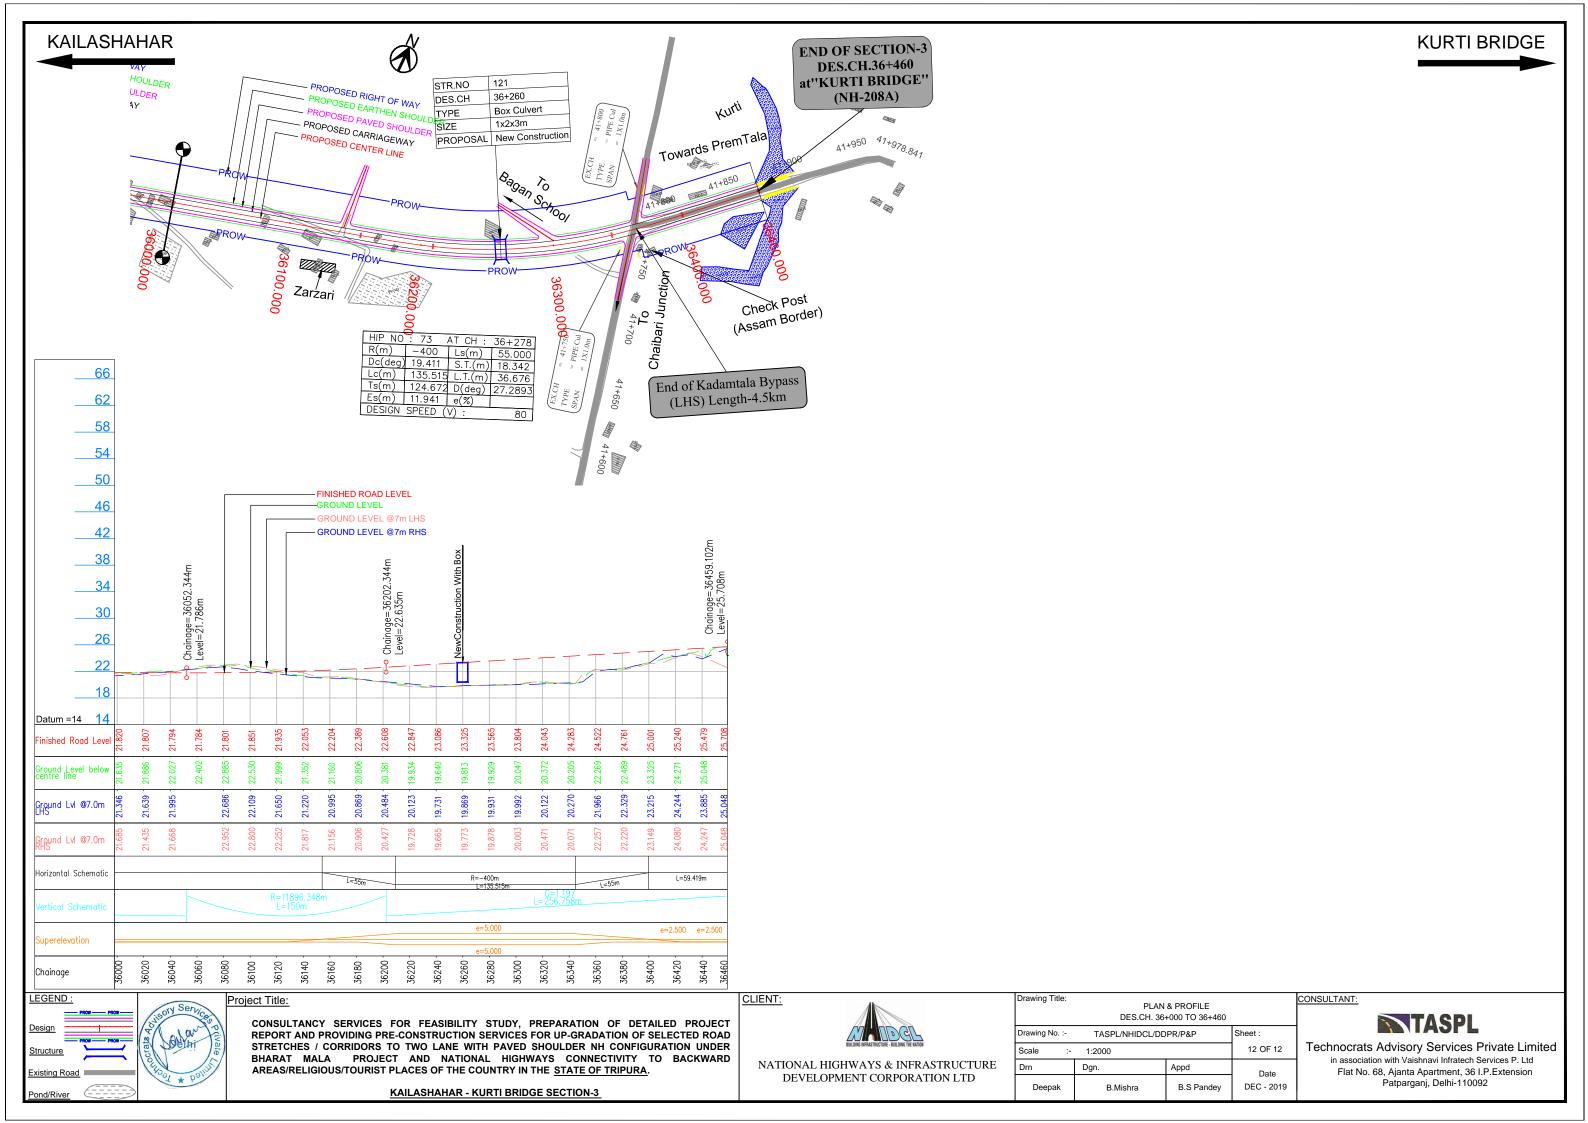







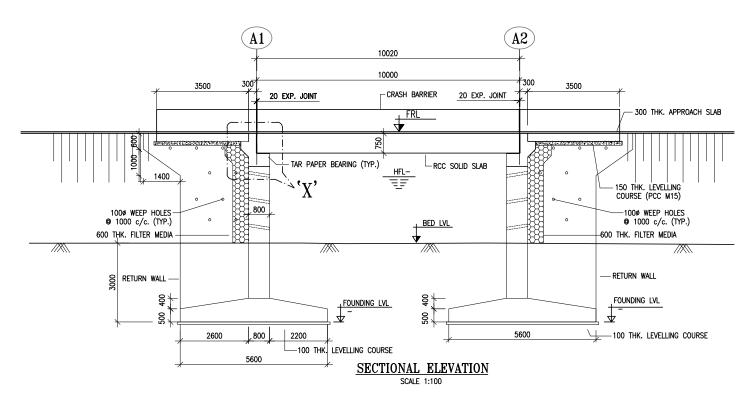

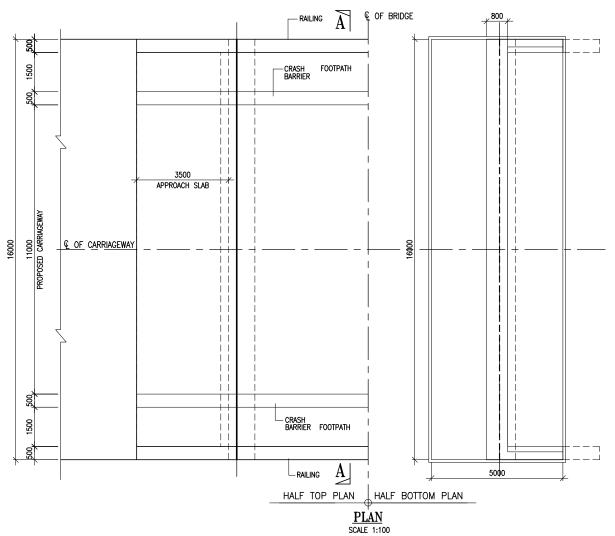

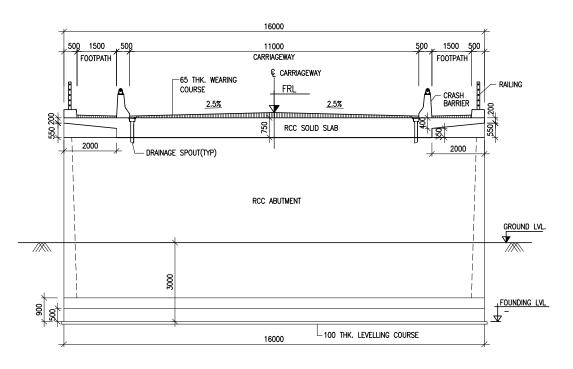

SECTION B-B

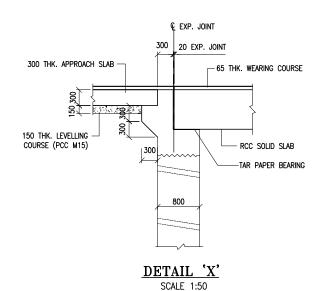

NOTES:

- ALL DIMENSIONS ARE IN mm and levels are in metres unless otherwise mentioned. Only written dimensions to be followed. No dimensions shall be scaled.
- STRUCTURE SHALL BE DESIGNED FOR ONE LANE OF IRC CLASS 70R+TWO LANE
 OF CLASS A OR 4 LANES OF IRC CLASS A LOADING OR 2 LANE OF IRC CLASS
 70R LOADING WHICHEVER GOVERNS.
- CONCRETE SHALL BE DESIGN MIX WITH A MINIMUM 28 DAYS CHARACTERISTIC STRENGTH AS FOLLOWS:

- 4. REINFORCEMENT STEEL SHALL BE HYSD BARS OF GRADE DESIGNATION Fe-500D CONFORMING TO IS:1786.
- 5. 65mm th. Wearing course comprising of under layer of 40mm thk. Asphaltic concrete overlaid with 25mm thick mastic asphalt provided As per section 500 of Morth Specifications.
- 6. SLAB SEAL EXPANSION JOINTS OF PROVEN QUALITY SHALL BE PROVIDED.
- 7. WEEP HOLES, SPACED AT 1000 c/c BOTH HORIZONTALLY AND VERTICALLY SHALL BE PROVIDED IN A STAGGERED MANNER IN ABUTMENT & RETURN WALL UPTO H.F.L. 8. MAXIMUM BEARING PRESSURE AT FOUNDING LEVEL = 20T/m2
- 9. THE SBC AT FOUNDING LEVEL SHALL BE VERIFIED AT SITE BEFORE

Project Title:

CONSULTANCY SERVICES FOR FEASIBILITY STUDY, PREPARATION OF DETAILED PROJECT REPORT AND PROVIDING PRE-CONSTRUCTION SERVICES FOR UP-GRADATION OF SELECTED ROAD STRETCHES / CORRIDORS TO TWO LANE WITH PAVED SHOULDER NH CONFIGURATION UNDER BHARAT MALA PROJECT AND NATIONAL HIGHWAYS CONNECTIVITY TO BACKWARD AREAS/RELIGIOUS/TOURIST PLACES OF THE COUNTRY IN THE STATE OF TRIPURA.

KAILASHAHAR - KURTI BRIDGE SECTION-3



CLIENT:

NATIONAL HIGHWAYS & INFRASTRUCTURE DEVELOPMENT CORPORATION LTD

Drawing Title:		IGEMENT DRAWING BRIDGE (1x10.0m)	FOR	<u>CC</u>
Drawing No. :-	TASPL/NHIDCL/FF	R/GAD/09	Sheet :	-
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D.S	D.P.S	B.S.Pandey	DEC- 2019	

CONSULTANT:





Technocrats Advisory Services Private Limited


in association with Vaishnavi Infratech Services P. Ltd 68,Ajanta Apartsments, 36, I.P. Extension Patparganj Delhi-110092.





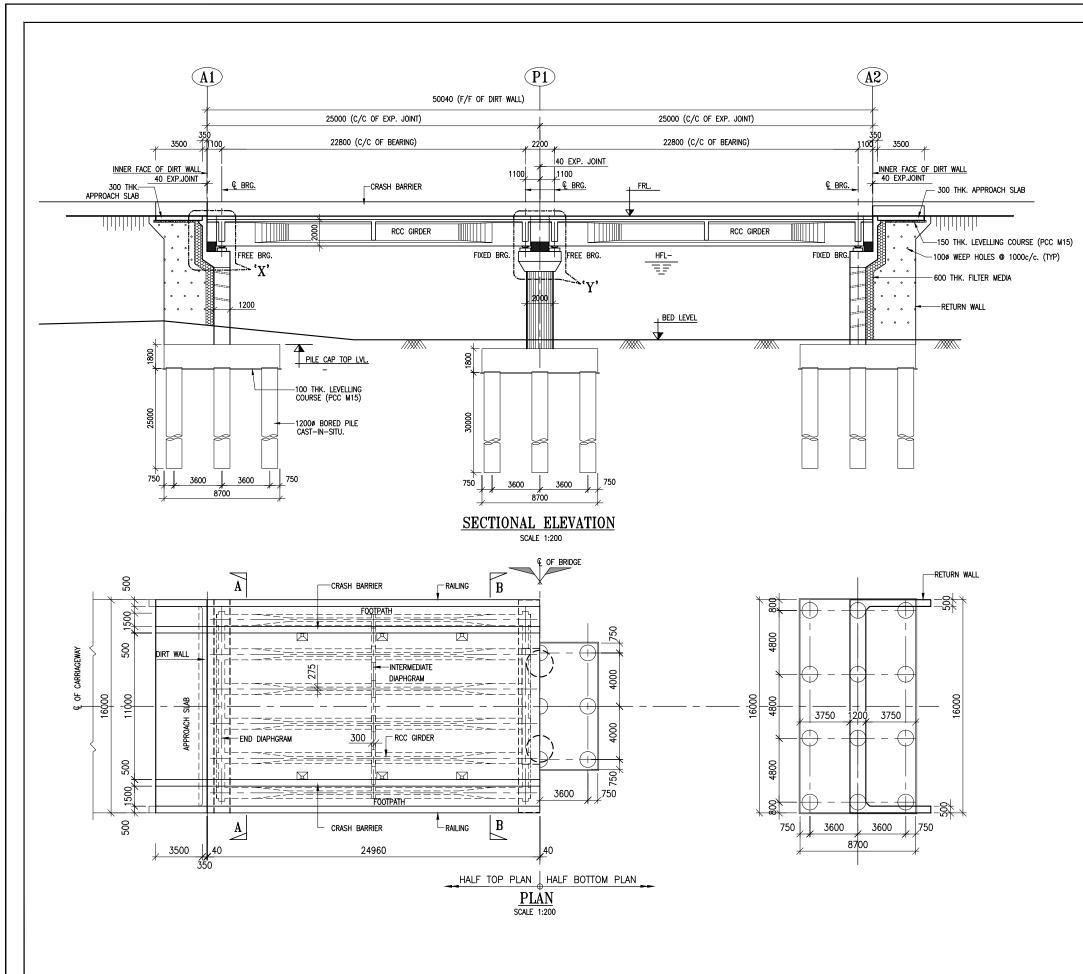

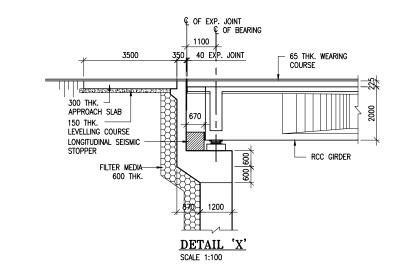

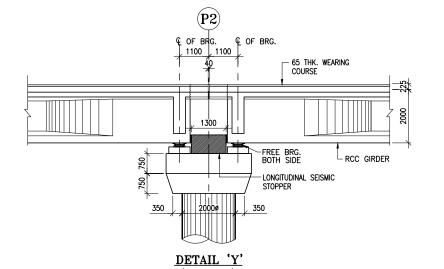

NOTES:

- ALL DIMENSIONS ARE IN mm AND LEVELS ARE IN METRES UNLESS OTHERWISE MENTIONED. ONLY WRITTEN DIMENSIONS TO BE FOLLOWED. NO DIMENSIONS SHALL BE SCALED.
- 2. EACH STRUCTURE SHALL BE DESIGNED FOR 2 LANES OF CLASS 7OR VEHICLE OR 1 LANE OF CLASS 7OR +2LANES OF CLASS A OR 4 LANES OF CLASS A WHICHEVER GOVERNS.
- 3. CONCRETE SHALL BE DESIGN MIX WITH A MINIMUM 28 DAYS CHARACTERISTIC

- 4. REINFORCEMENT STEEL SHALL BE HYSD BARS OF GRADE DESIGNATION Fe-500D CONFORM TO IS:1786.
- 5. 65mm TH. WEARING COURSE COMPRISING OF UNDER LAYER OF 40mm THK.
 ASPHALTIC CONCRETE OVERLAID WITH 25mm THK MASTIC ASPHALT. PROVIDED AS
 PER SECTION 500 OF MORTH SPECIFICATIONS.
- 6. STRIP SEAL TYPE EXPANSION JOINTS OF PROVEN QUALITY SHALL BE PROVIDED.
- 7. WEEP HOLES, SPACED AT 1000 c/c BOTH HORIZONTALLY AND VERTICALLY SHALL BE PROVIDED IN A STAGGERED MANNER IN ABUTMENT & RETURN WALL UPTO H.F.L.



Project Title:-

CONSULTANCY SERVICES FOR FEASIBILITY STUDY, PREPARATION OF DETAILED PROJECT REPORT AND PROVIDING PRE-CONSTRUCTION SERVICES FOR UP-GRADATION OF SELECTED ROAD STRETCHES / CORRIDORS TO TWO LANE WITH PAVED SHOULDER NH CONFIGURATION UNDER BHARAT MALA PROJECT AND NATIONAL HIGHWAYS CONNECTIVITY TO BACKWARD AREAS/RELIGIOUS/TOURIST PLACES OF THE COUNTRY IN THE STATE OF TRIPURA.





NATIONAL HIGHWAYS & INFRASTRUCTURE DEVELOPMENT CORPORATION LTD

Drawing Title:		ARRANGEMENT D RIDGE AT (2X25.0m	
Drawing No. :-	TASPL/NHIDCL/FF	R/GAD/09	Sheet :
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Drn	Dgn.	Appd	Date
D.S	D.P.S	B.S.Pandey	DEC- 2019


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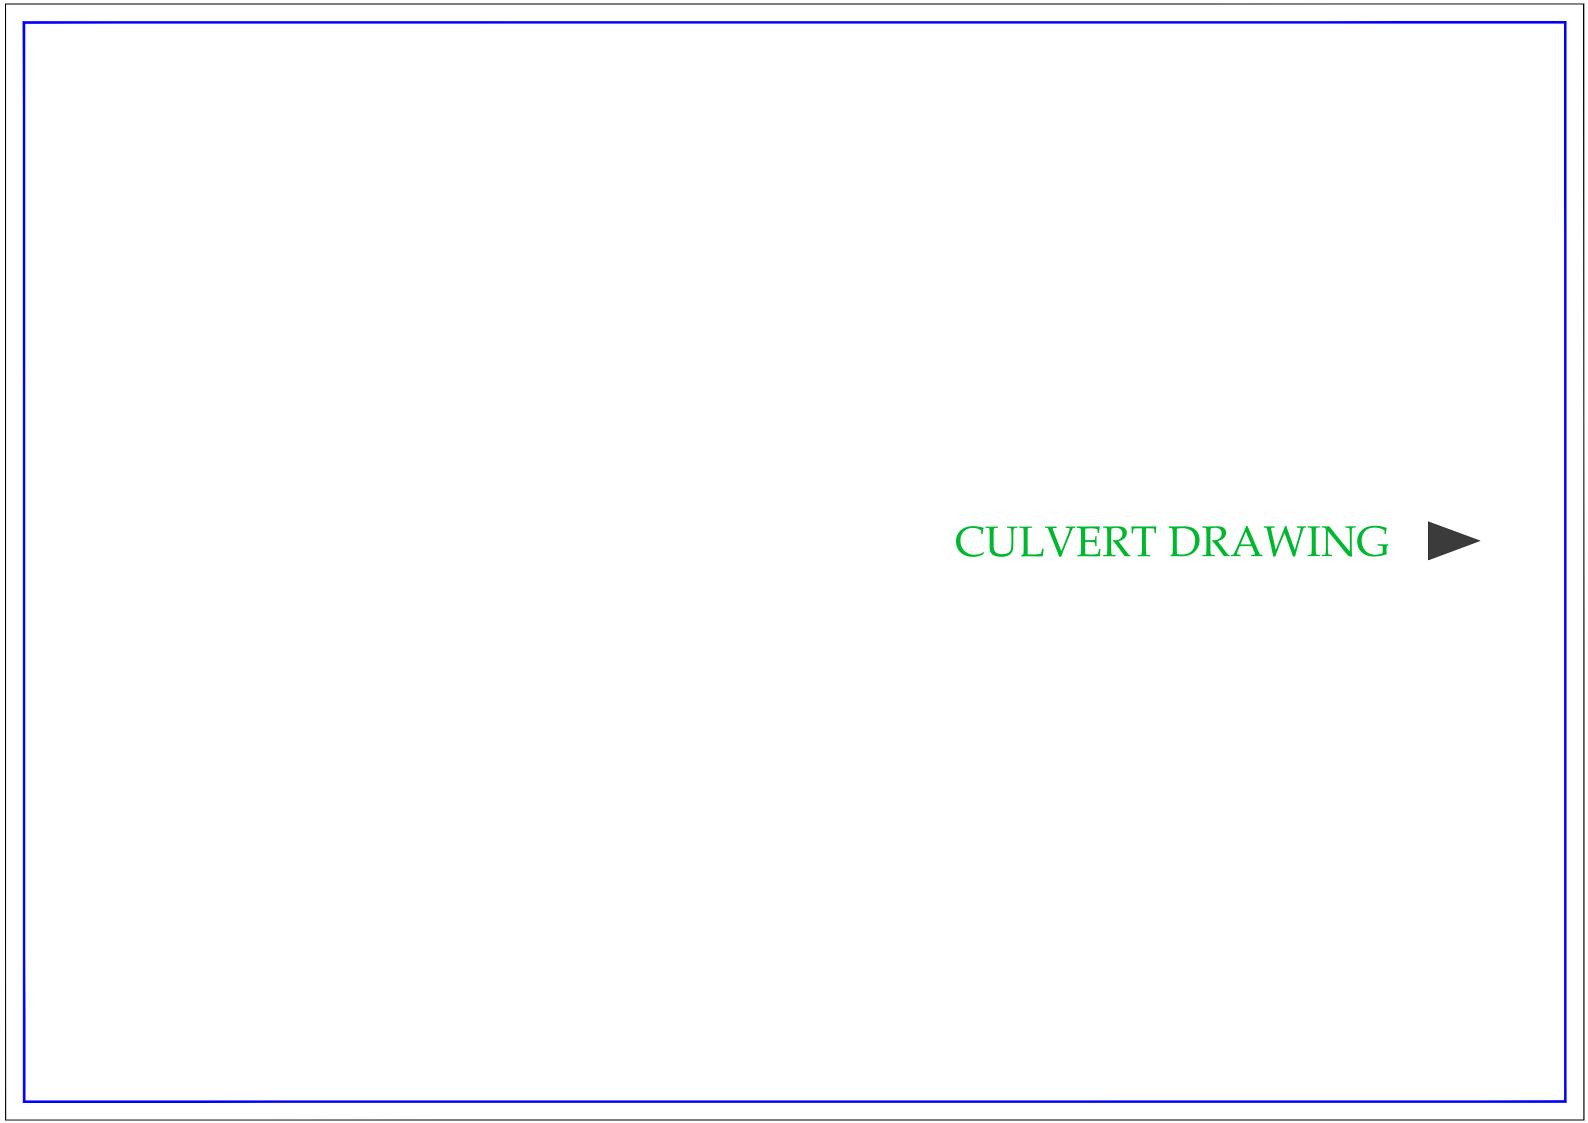



Technocrats Advisory Services Private Limited in association with Vaishnavi Infratech Services P. Ltd

sociation with Vaishnavi Infratech Services P. Ltd 68,Ajanta Apartsments, 36, I.P. Extension Patparganj Delhi-110092.





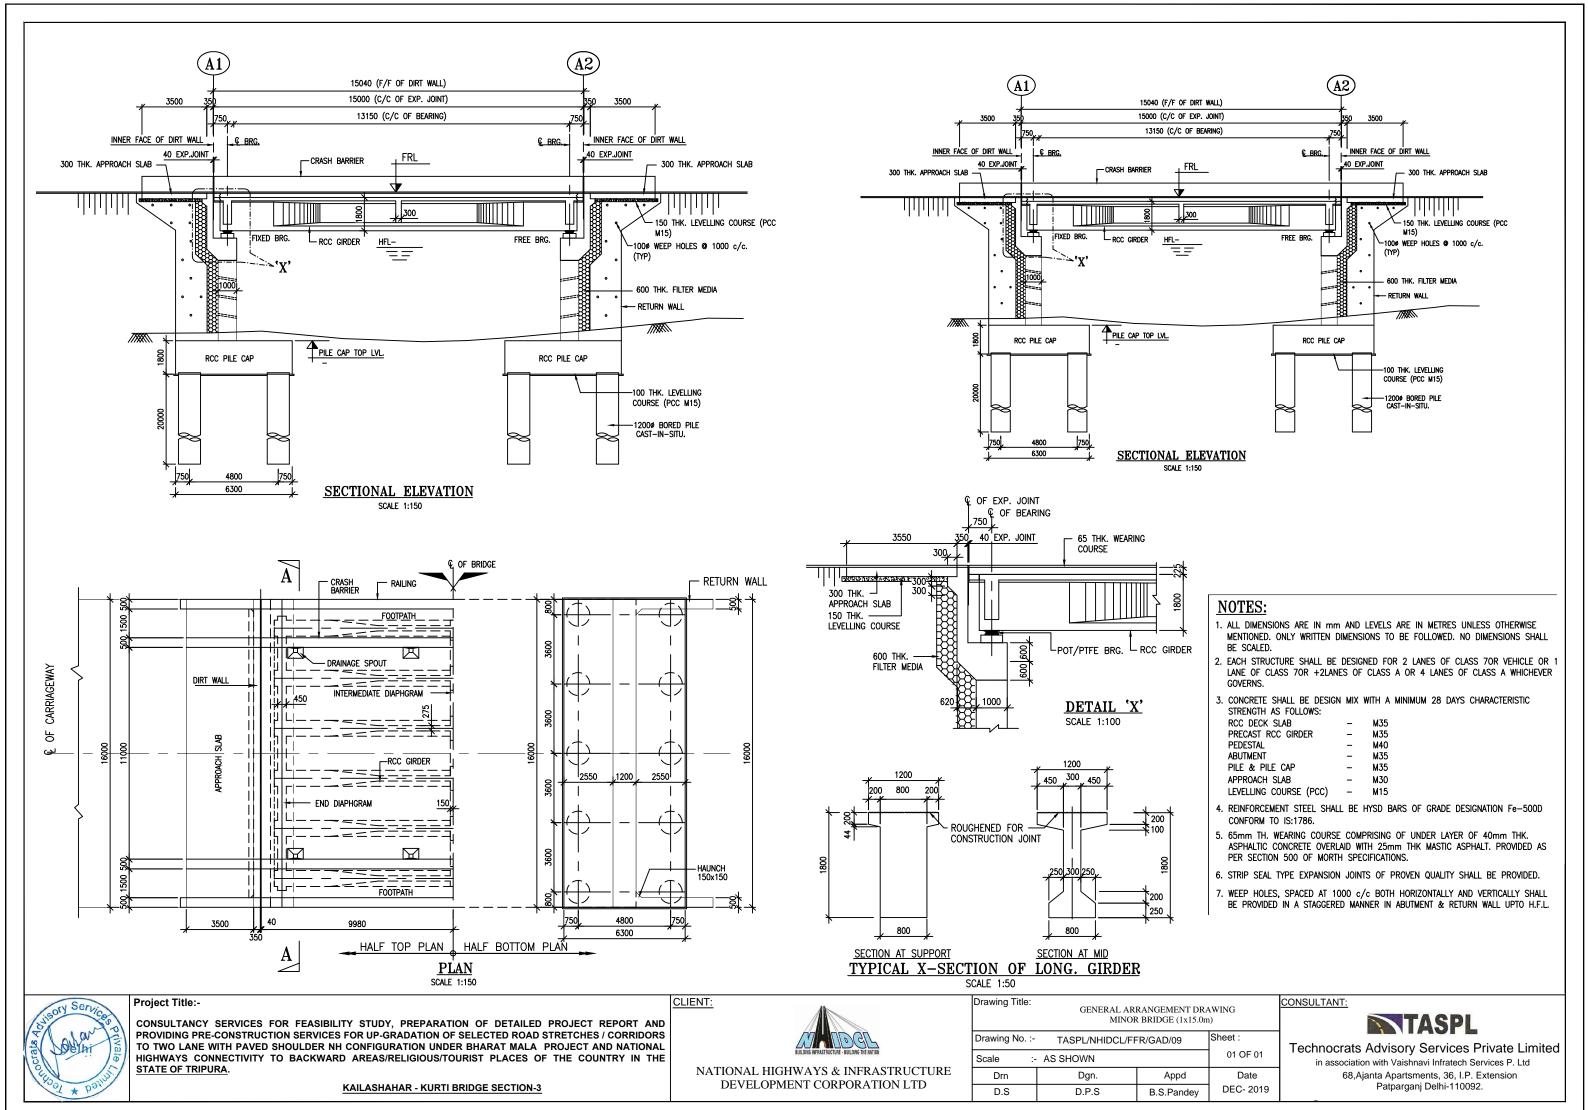

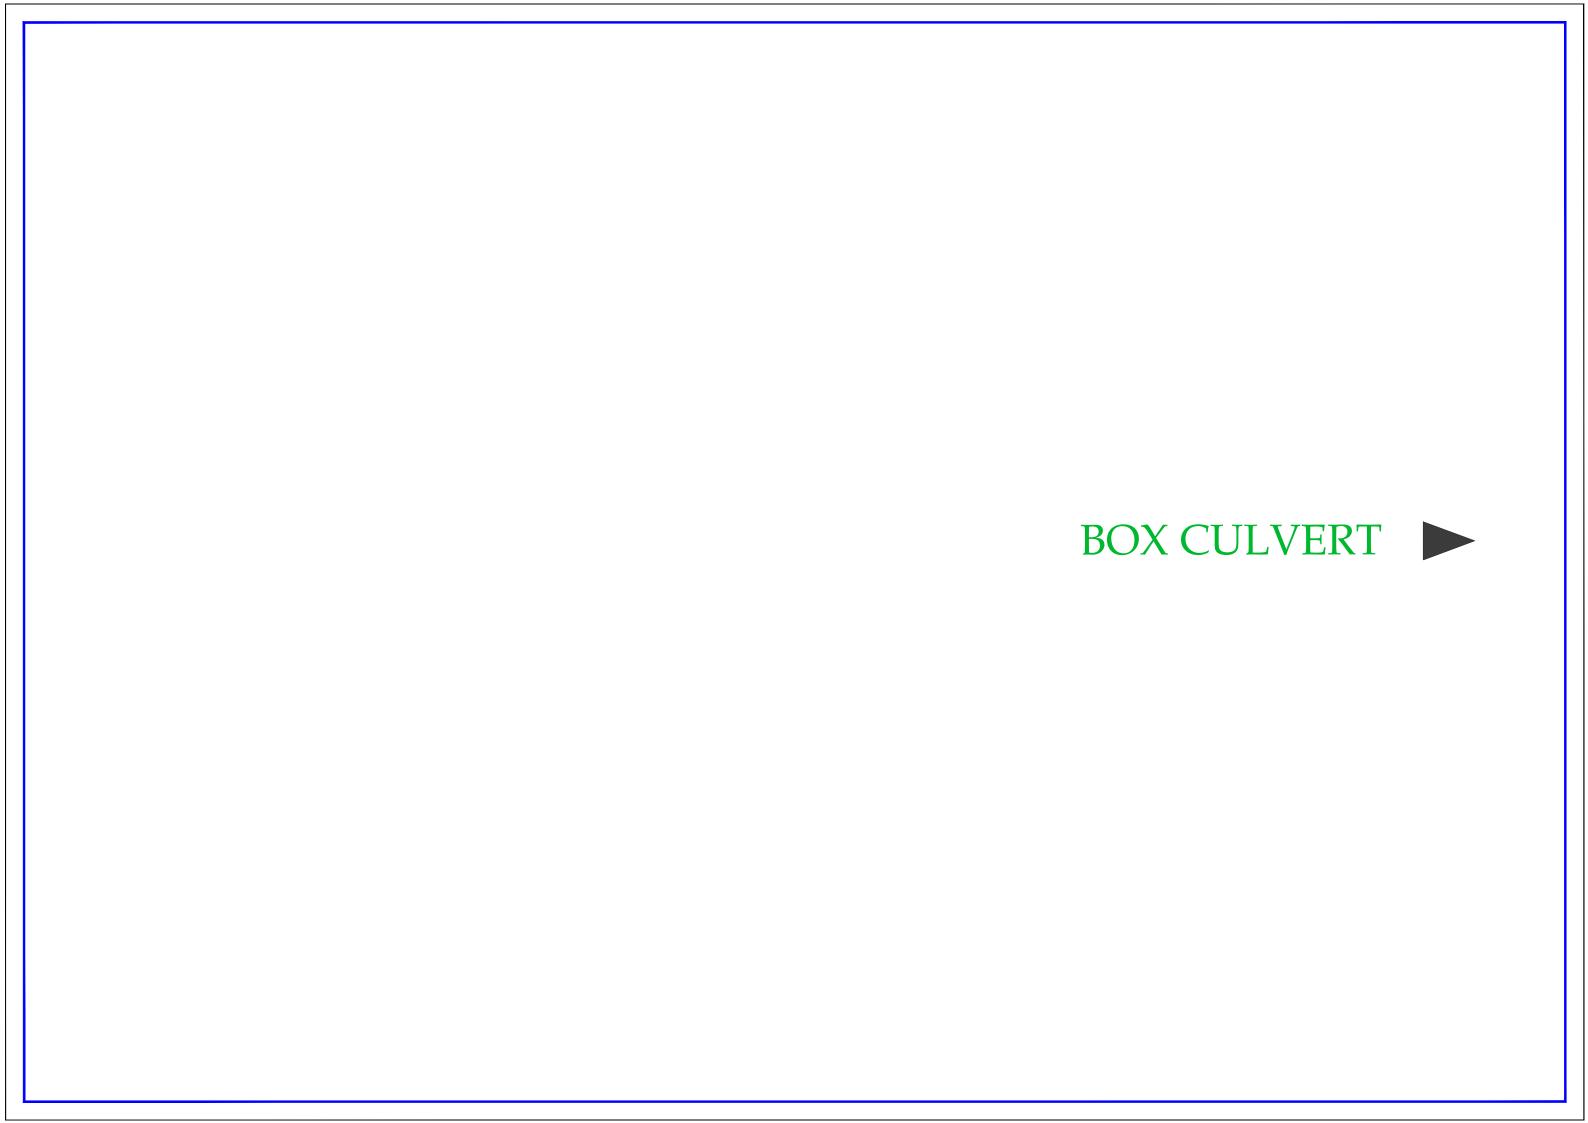

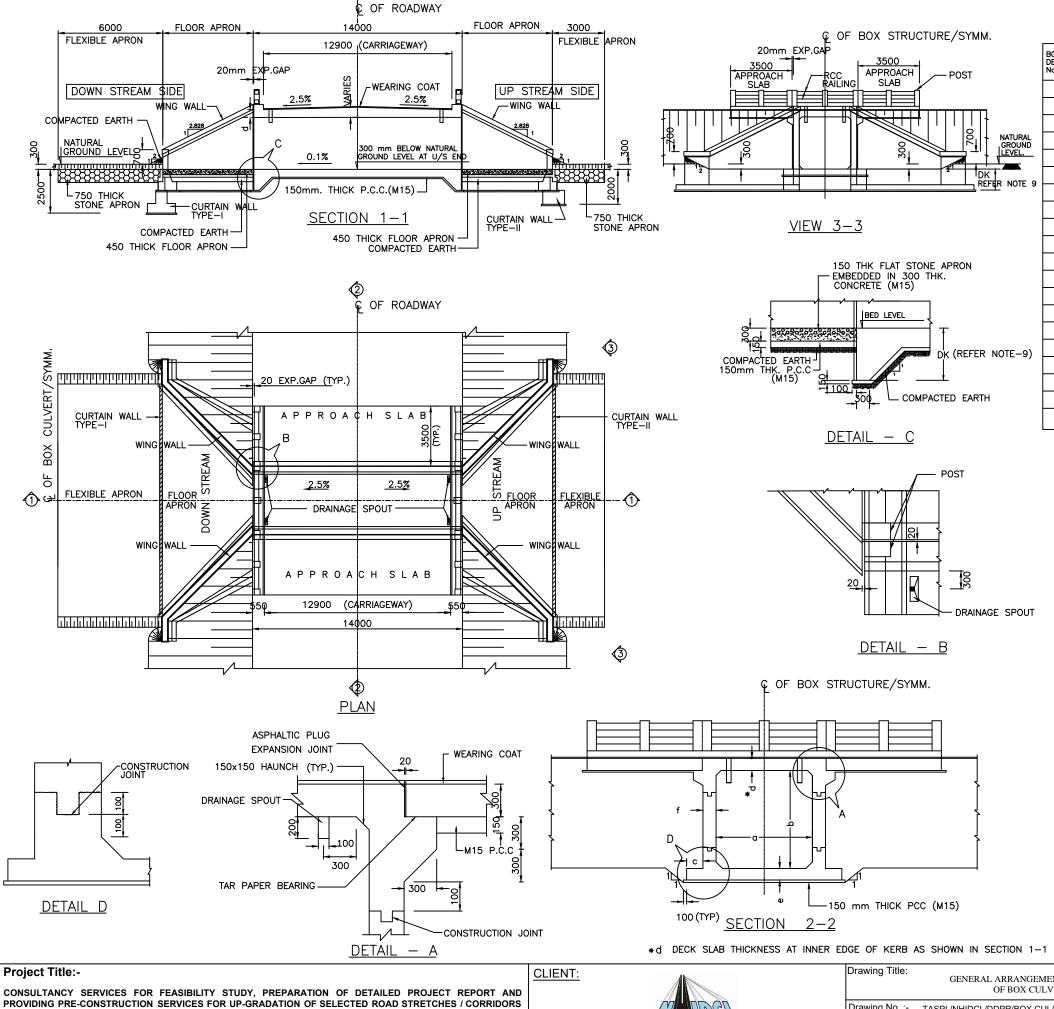


TABLE SHOWING SALIENT DIMENSIONS

BOX CELL DESIGNATION Nc/ab/Ec	a (mm)	b (mm)	c (mm)	d (mm)	e (mm)	f (mm)	REQUIRED BEARING CAPACITY CATEGORY	DESIGN BASE PRESSURE (T/M ²)	ALLOWABLE DRAWDOWN AT A TIME (M)
1/22/0	2000	2000	500	350	380	300	С	11.62	0.00
1/23/0	2000	3000	1300	370	420	350	С	11.01	2.98
1/33/0	3000	3000	900	420	420	420	С	10.50	2.15
1/34/0	3000	4000	1700	450	480	460	С	11.37	4.81
1/43/0	4000	3000	400	450	500	500	С	10.53	1.29
1/44/0	4000	4000	1200	480	550	550	С	11.07	3.99
1/45/0	4000	5000	1900	520	620	630	С	12.48	6.14
1/53/0	5000	3000	300	500	570	570	В	9.83	1.73
1/54/0	5000	4000	800	520	600	620	С	10.66	3.40
1/55/0	5000	5000	1500	580	680	700	С	12.40	5.81
1/63/0	6000	3000	300	680	720	720	В	9.88	2.96
1/64/0	6000	4000	300	680	720	750	С	10.93	3.18
1/65/0	6000	5000	1100	680	750	750	С	11.77	5.35
1/66/0	6000	6000	1800	700	800	850	С	13.21	7.50
1/75/0	7000	5000	600	750	850	850	С	11.59	4.86
1/76/0	7000	6000	1200	780	920	950	С	13.00	6.93
1/77/0	7000	7000	1300	780	950	950	С	13.10	7.18
1/85/0	8000	5000	300	800	950	950	С	11.37	4.83
1/86/0	8000	6000	900	820	970	1000	С	12.52	6.56
1/87/0	8000	7000	1300	850	1100	1200	С	14.36	8.62

- ALL DIMENSIONS ARE IN MILLIMETRES UNLESS
 OTHERWISE MENTIONED. ONLY WRITTEN DIMENSIONS
 ARE TO BE FOLLOWED.
- 2. FOR GENERAL NOTES AND REFERENCE DRAWINGS REFER DRG. NO. SD/101.
- 3. FOR REINFORCEMENT DETAILS REFER DRG. NO. SD/108.
- 4. FOR DETAILS OF WING WALL REFER DWG. NO. SD/113.
- 5. SOIL DENSITY ON THE BACKFILL SHOULD CONFORM TO CLAUSE 305.2.1.5 OF MOST SPECIFICATION.
- 6. NET BEARING CAPACITY REQUIRED FOR SOIL IS DIVIDED IN FOUR CATEGORIES AS SHOWN BELOW :

CATEGORY	።	NET BEARING CAPACITY REQUIRED FOR SOIL
A B	::	5 T/M ² 10 T/M ²
C D	::	15 T/M ² 20 T/M ²

- 7. SOFT AND LOOSE PATCHES IN THE BEARING AREA ARE TO BE REPLACED BY COMPACTED GRANULAR FILLS WITH LAYERS NOT EXCEEDING 300mm
- 8. DESIGNS ARE GIVEN FOR THE BOX CELL CULVERTS ONLY. THESE HAVE NO BEARING WITH DESIGN OF EMBANKMENT WHICH WILL BE TAKEN UP BY ENGINEER-IN-CHARGE SEPERATELY
- 9. 'DK' IS DEPTH OF KEY AT BASE SLAB.

FOR BASE SLAB THICKNESS VALUE OF 'DK' UPTO 900mm 1200mm. GREATER THAN 900mm

e = BASE SLAB THICKNESS

CONSULTANCY SERVICES FOR FEASIBILITY STUDY, PREPARATION OF DETAILED PROJECT REPORT AND PROVIDING PRE-CONSTRUCTION SERVICES FOR UP-GRADATION OF SELECTED ROAD STRETCHES / CORRIDORS TO TWO LANE WITH PAVED SHOULDER NH CONFIGURATION UNDER BHARAT MALA PROJECT AND NATIONAL HIGHWAYS CONNECTIVITY TO BACKWARD AREAS/RELIGIOUS/TOURIST PLACES OF THE COUNTRY IN THE STATE OF TRIPURA

KAILASHAHAR - KURTI BRIDGE SECTION-3



NATIONAL HIGHWAYS & INFRASTRUCTURE DEVELOPMENT CORPORATION LTD

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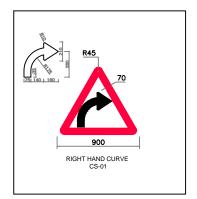



echnocrats Advisory Services Private Limited in association with Vaishnavi Infratech Services P. Ltd

> 68, Ajanta Apartsments, 36, I.P. Extension Patparganj Delhi-110092.




CAUTIONARY/WARNING SIGNS



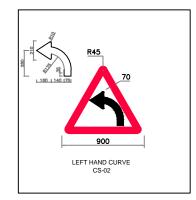








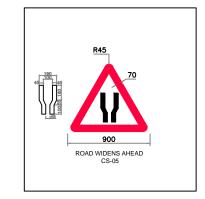





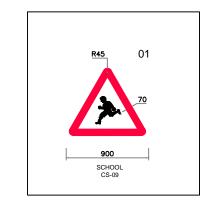


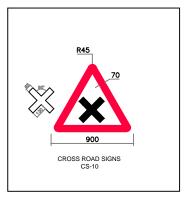


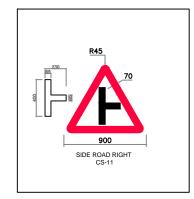


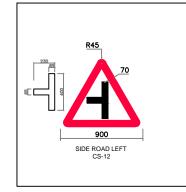


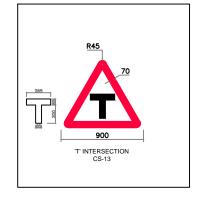


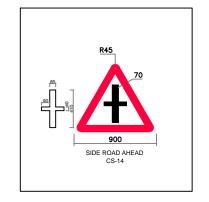


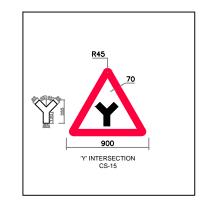


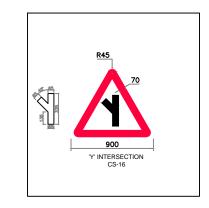


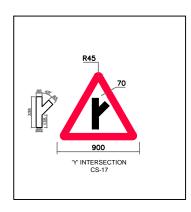


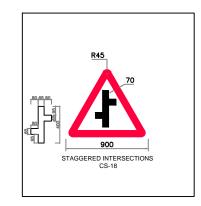


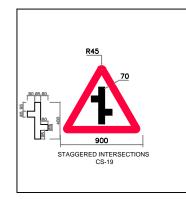


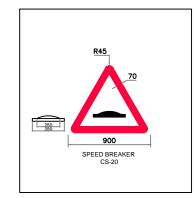


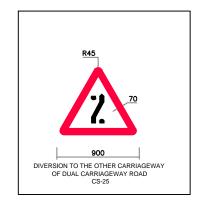

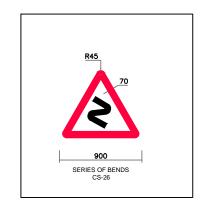

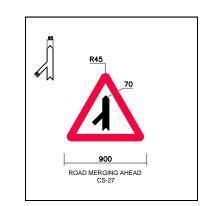

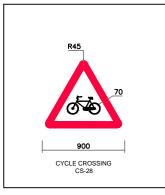

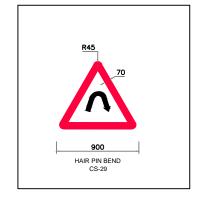



Project Title:

CONSULTANCY SERVICES FOR FEASIBILITY STUDY, PREPARATION OF DETAILED PROJECT REPORT AND PROVIDING PRE-CONSTRUCTION SERVICES FOR UP-GRADATION OF SELECTED ROAD STRETCHES / CORRIDORS TO TWO LANE WITH PAVED SHOULDER NH CONFIGURATION UNDER BHARAT MALA PROJECT AND NATIONAL HIGHWAYS CONNECTIVITY TO BACKWARD AREAS/RELIGIOUS/TOURIST PLACES OF THE COUNTRY IN THE STATE OF TRIPURA.

KAILASHAHAR - KURTI BRIDGE SECTION-3







NATIONAL HIGHWAYS & INFRASTRUCTURE DEVELOPMENT CORPORATION LTD


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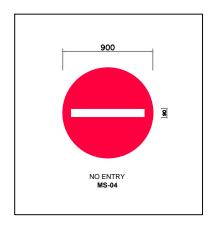
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MANDATORY/REGULATORY SIGNS







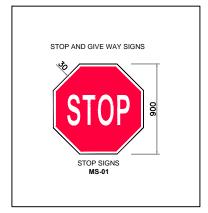


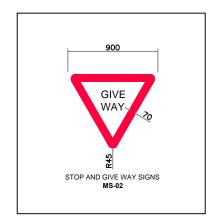


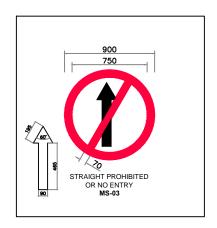


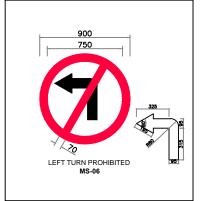


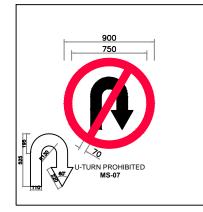


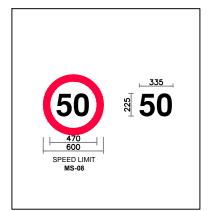

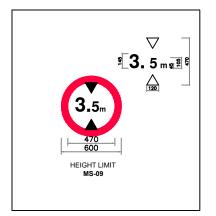

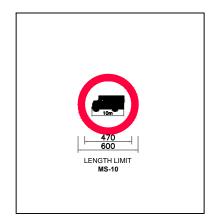

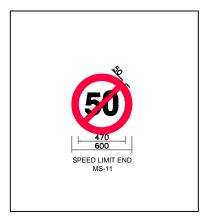

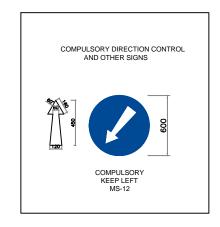









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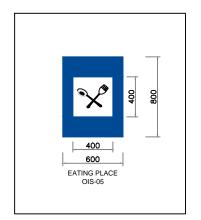
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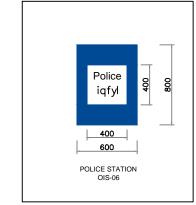





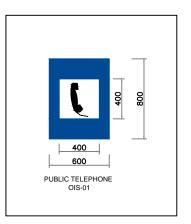

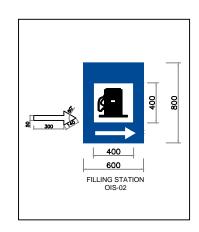

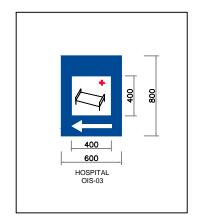

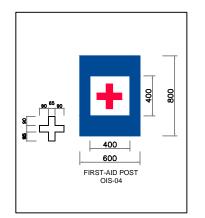

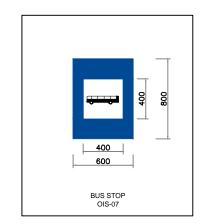

(B) DIRECTION AND PLACE IDENTIFICATION SIGNS

Services Private

Project Title:


CONSULTANCY SERVICES FOR FEASIBILITY STUDY, PREPARATION OF DETAILED PROJECT REPORT AND PROVIDING PRE-CONSTRUCTION SERVICES FOR UP-GRADATION OF SELECTED ROAD STRETCHES / CORRIDORS TO TWO LANE WITH PAVED SHOULDER NH CONFIGURATION UNDER BHARAT MALA PROJECT AND NATIONAL HIGHWAYS CONNECTIVITY TO BACKWARD AREAS/RELIGIOUS/TOURIST PLACES OF THE COUNTRY IN THE STATE OF TRIPURA.


KAILASHAHAR - KURTI BRIDGE SECTION-3



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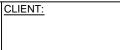




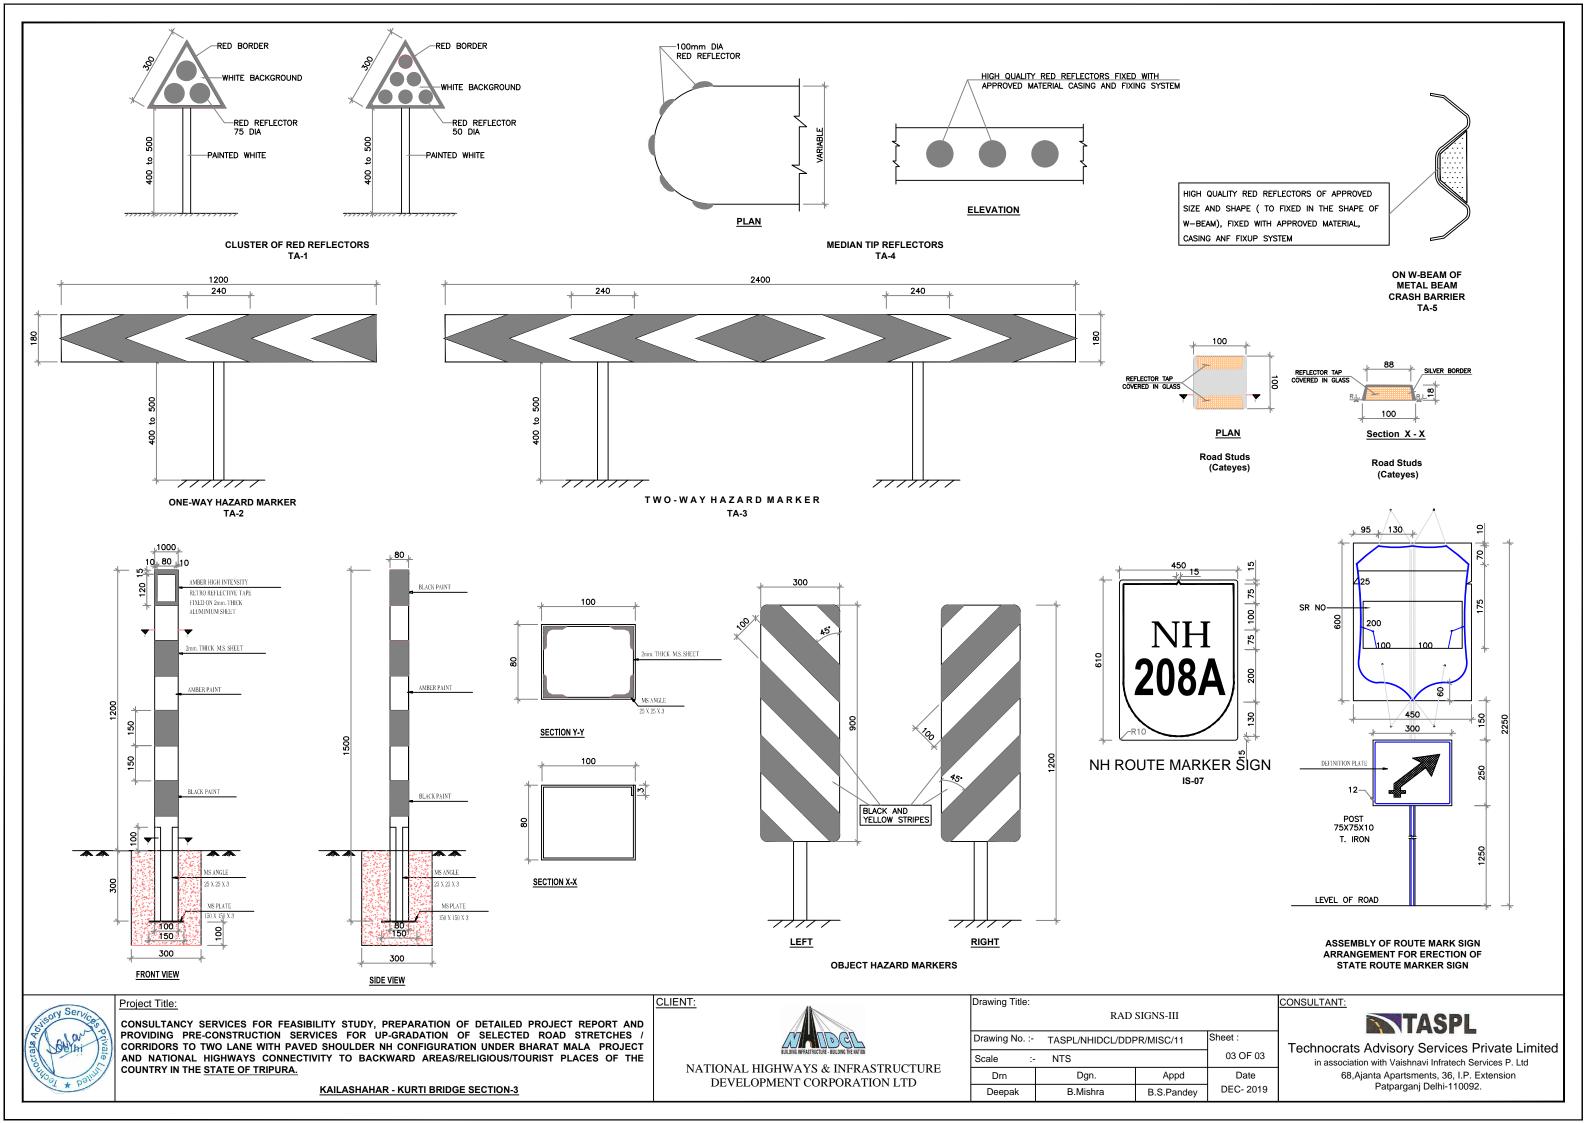

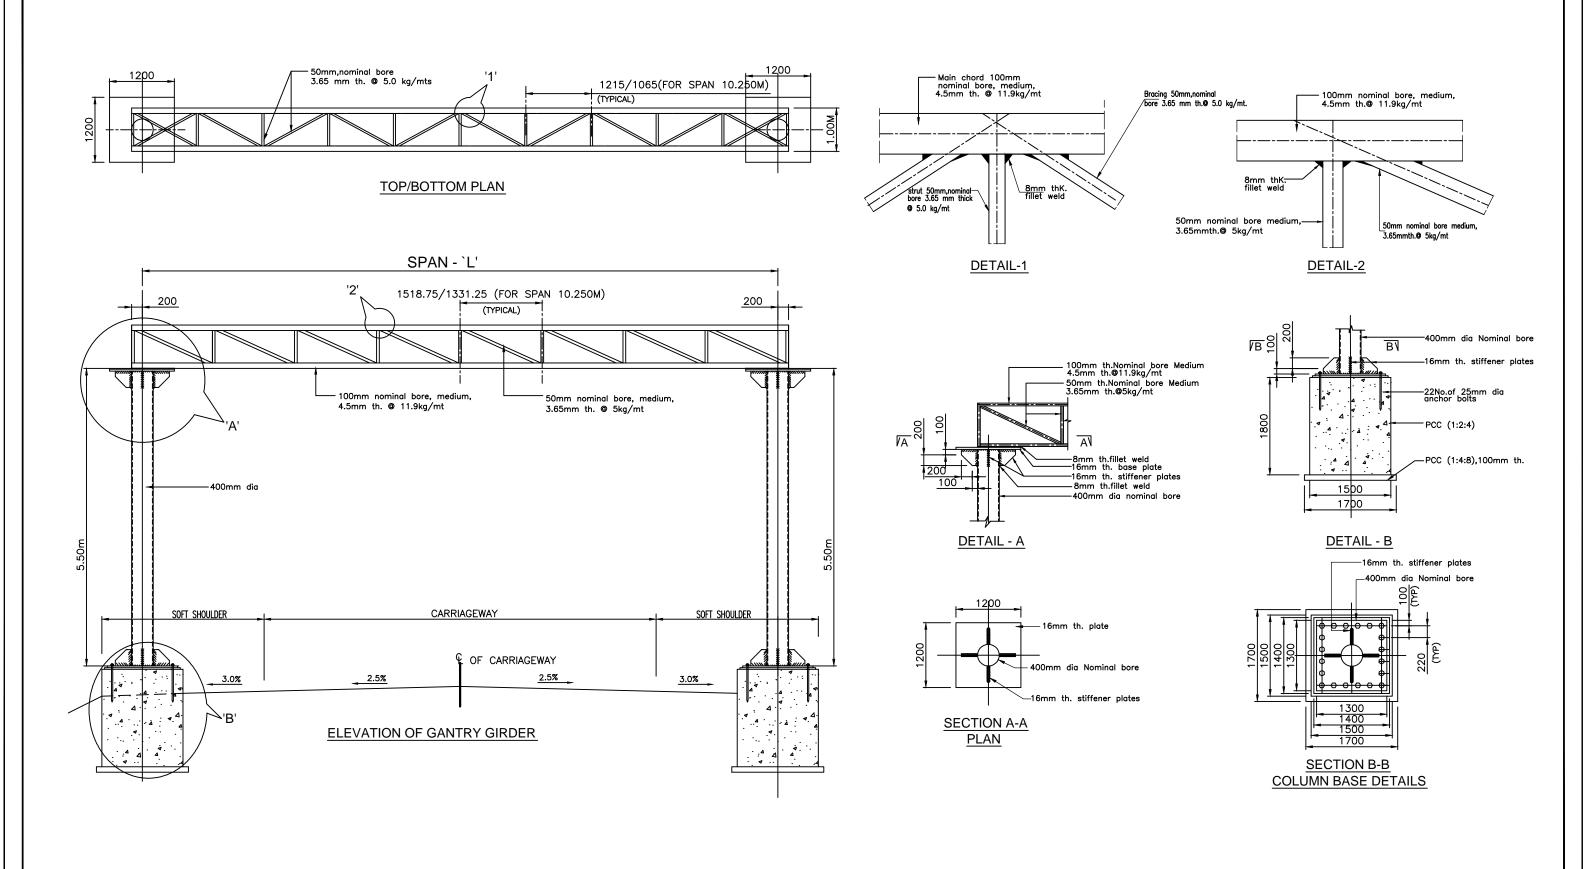CONSULTANCY SERVICES FOR FEASIBILITY STUDY, PREPARATION OF DETAILED PROJECT REPORT AND PROVIDING PRE-CONSTRUCTION SERVICES FOR UP-GRADATION OF SELECTED ROAD STRETCHES / CORRIDORS TO TWO LANE WITH PAVED SHOULDER NH CONFIGURATION UNDER BHARAT MALA PROJECT AND NATIONAL HIGHWAYS CONNECTIVITY TO BACKWARD AREAS/RELIGIOUS/TOURIST PLACES OF THE COUNTRY IN THE STATE OF TRIPURA.

KAILASHAHAR - KURTI BRIDGE SECTION-3






NATIONAL HIGHWAYS & INFRASTRUCTURE	
DEVELOPMENT CORPORATION LTD	


TYPICAL DETAILS OF OVERHEAD GANTRY					
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Deepak	B.Mishra	B.S.Pandey	DEC- 2019		


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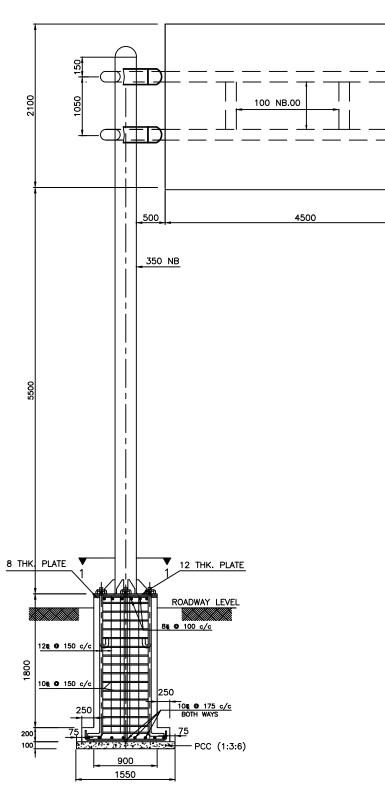
CONSULTANT:





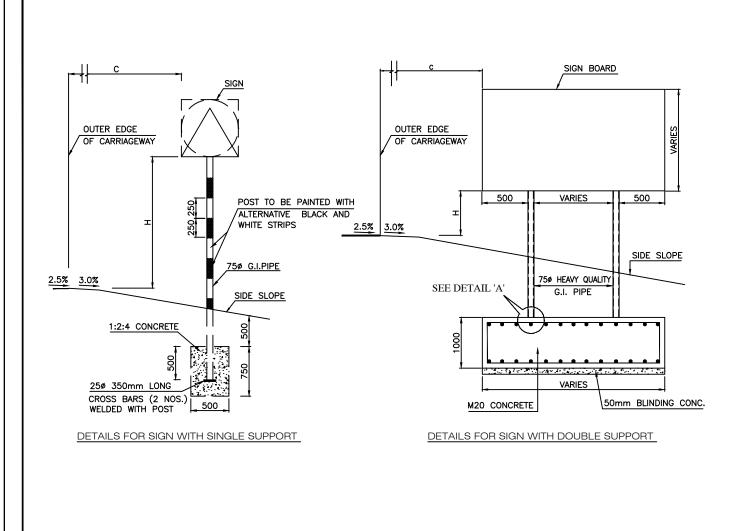

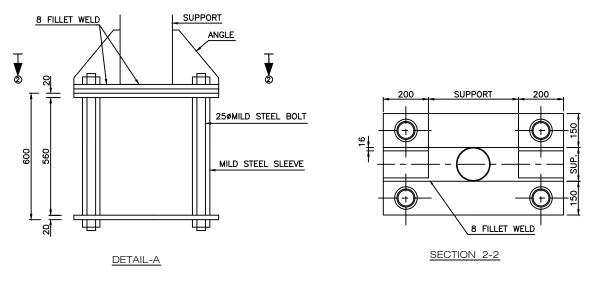

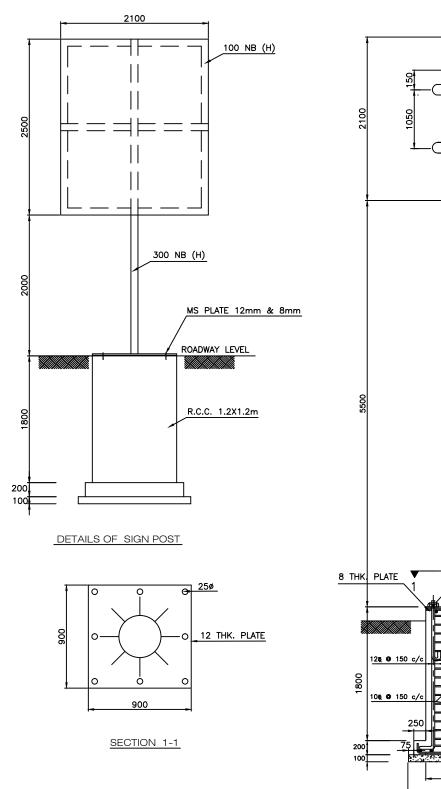

DETAILS FOR CANTILEVER TYPE OVERHEAD SIGN



Project Title:

CONSULTANCY SERVICES FOR FEASIBILITY STUDY, PREPARATION OF DETAILED PROJECT REPORT AND PROVIDING PRE-CONSTRUCTION SERVICES FOR UP-GRADATION OF SELECTED ROAD STRETCHES / CORRIDORS TO TWO LANE WITH PAVED SHOULDER NH CONFIGURATION UNDER BHARAT MALA PROJECT AND NATIONAL HIGHWAYS CONNECTIVITY TO BACKWARD AREAS/RELIGIOUS/TOURIST PLACES OF THE COUNTRY IN THE STATE OF TRIPURA.

KAILASHAHAR - KURTI BRIDGE SECTION-3





NATIONAL HIGHWAYS & INFRASTRUCTURE DEVELOPMENT CORPORATION LTD

Drawing Title:	itle: TYPICAL CANTILEVER TYPE OVERHEAD SIGN				
Drawing No. :-	Drawing No. :- TASPL/NHIDCL/DDPR/MISC/11				
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B.S.Pandey


B.Mishra


Deepak

CONSULTANT:

DEC- 2019



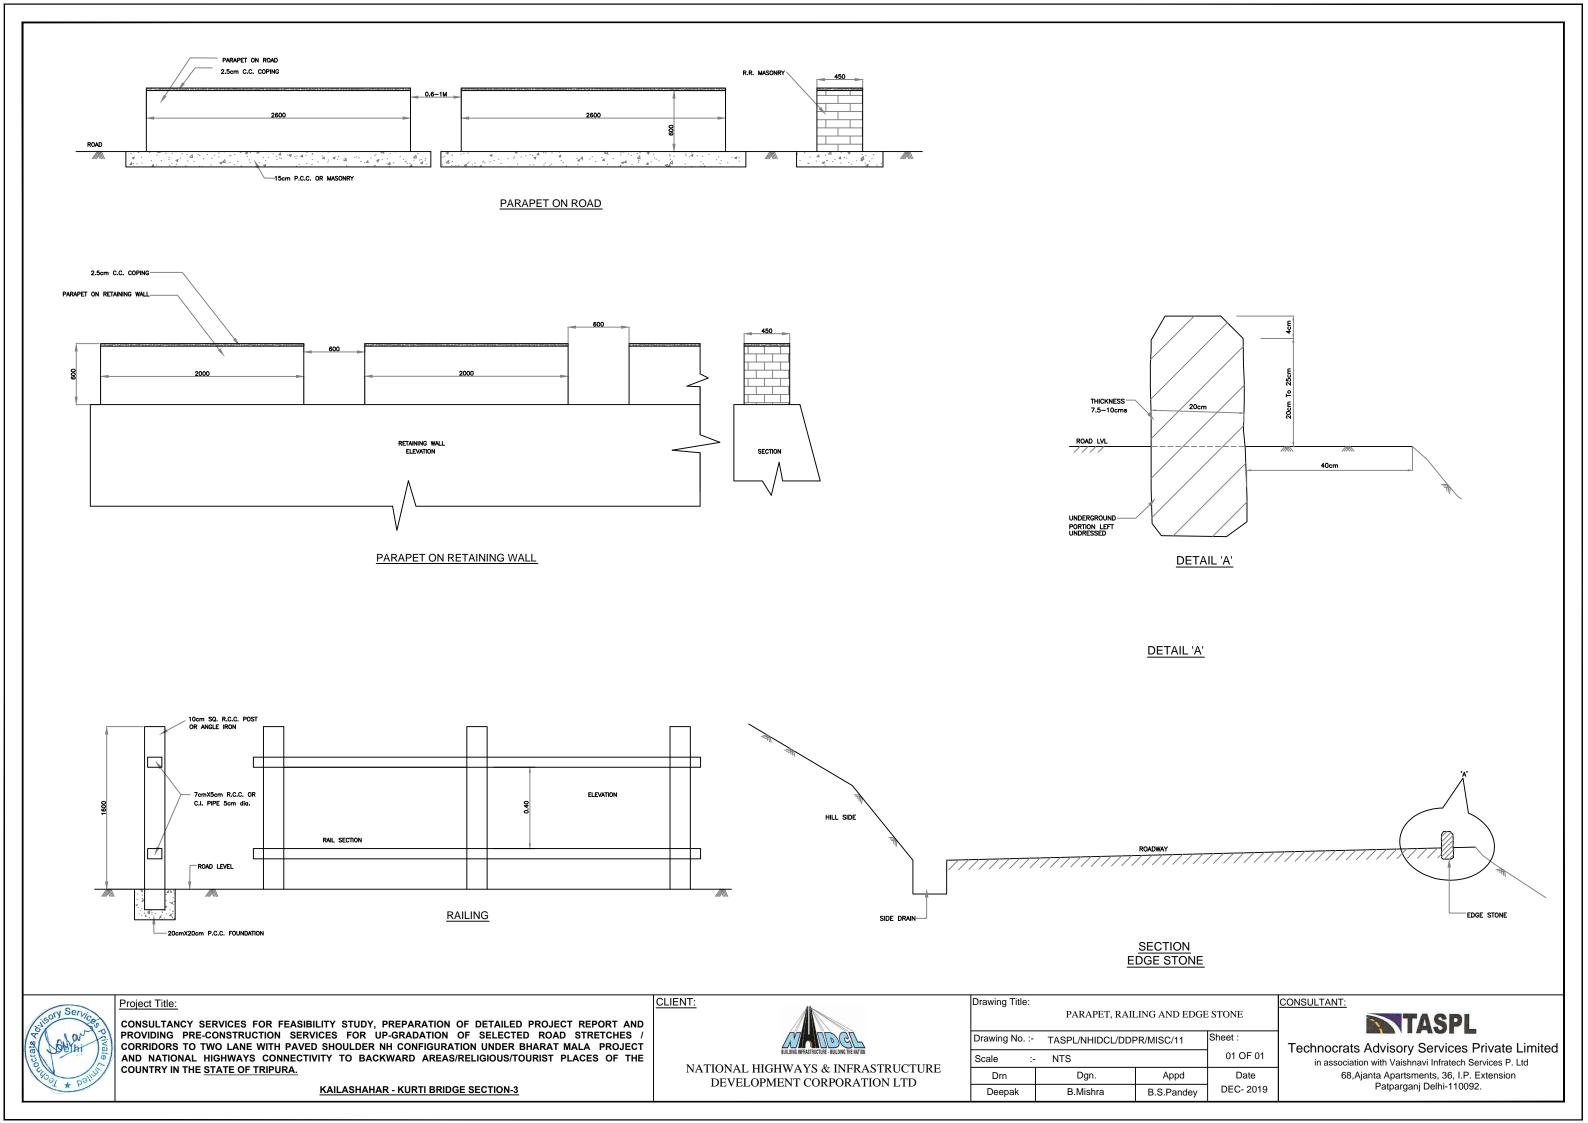

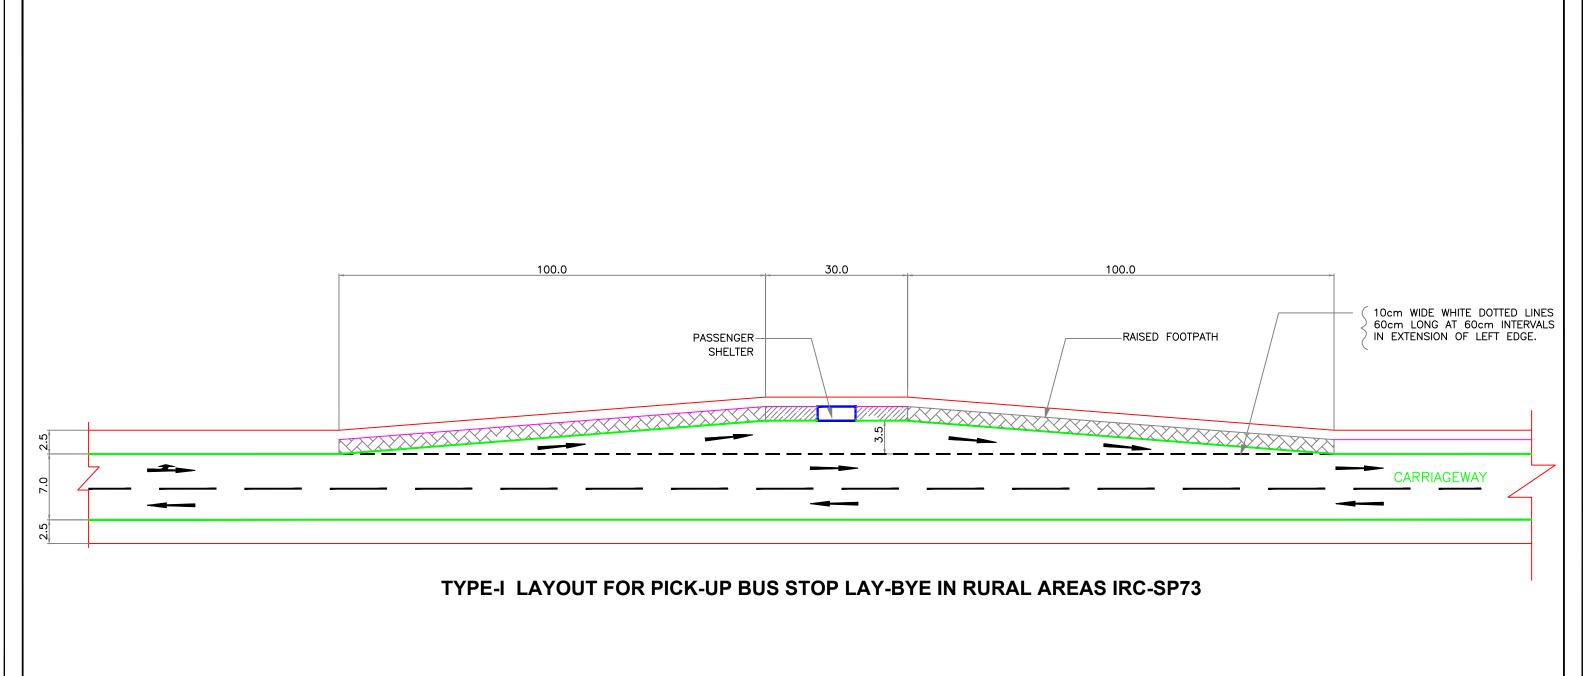



CONSULTANCY SERVICES FOR FEASIBILITY STUDY, PREPARATION OF DETAILED PROJECT REPORT AND PROVIDING PRE-CONSTRUCTION SERVICES FOR UP-GRADATION OF SELECTED ROAD STRETCHES / CORRIDORS TO TWO LANE WITH PAVED SHOULDER NH CONFIGURATION UNDER BHARAT MALA PROJECT AND NATIONAL HIGHWAYS CONNECTIVITY TO BACKWARD AREAS/RELIGIOUS/TOURIST PLACES OF THE COUNTRY IN THE STATE OF TRIPURA.

KAILASHAHAR - KURTI BRIDGE SECTION-3






NATIONAL HIGHWAYS & INFRASTRUCTURE DEVELOPMENT CORPORATION LTD

TYPICAL LAYOUT FOR BUS STOP LAY-BYE					
Drawing No. :- TASPL/NHIDCL/DDPR/MISC/11 Sheet :					
Scale :-	NTS		01 OF 01		
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Deepak	B.Mishra	B.S.Pandey	DEC- 2019		


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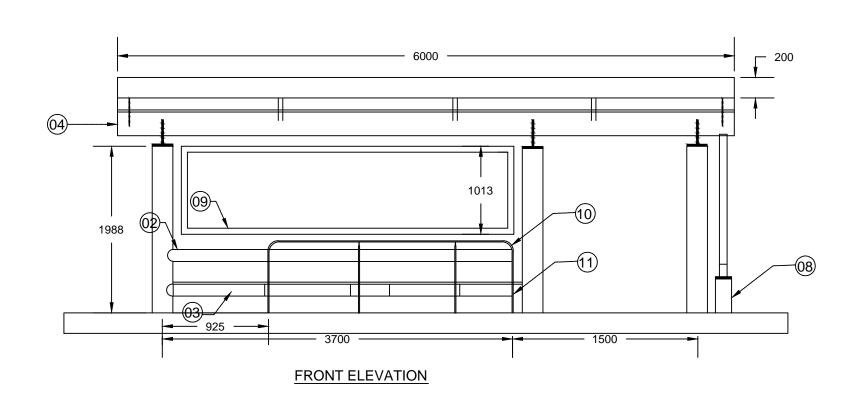


SR	DESCRIPTION	SIZE	MATERIAL
01	MAIN VERTICAL COLUMNS	OD.200mm X15 SWG	S.S 304
02	BACK SUPPORT PIPE	OD'75MM X17 SWG	S.S 304
03	BENCH SUPPORT PIPE	OD.150 X15 SWG	S.S 304
04	ROOF SUPPORT PIPE	OD.200mm X15 SWG	S.S 304
05	ROOF SUPPORT PLATES	2.5MM THK.	S.S 304
06	ADV BORD OUTER FRAME	100X40 X18 SWG	S.S 304
07	ADV BORD INNER FRAME	25X25X 18 SWG	M.S/G.I
08	ADV BORD COLUMNS (SIDE)	OD.150MM X15 SWG	S.S 304
09	ADV BORD FRAME (MAIN)	25X25X 18SWG	M.S/G.I
10	RAILING	OD.75MM X17 SWG	S.S 304
11	RAILING COLUMNS	OD.50MM X18 SWG	S.S 304

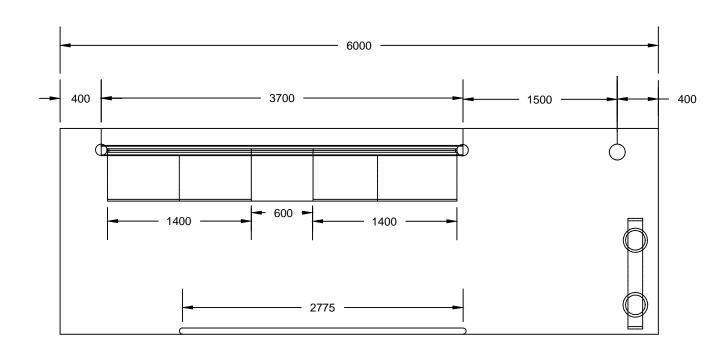

TOP PLAN



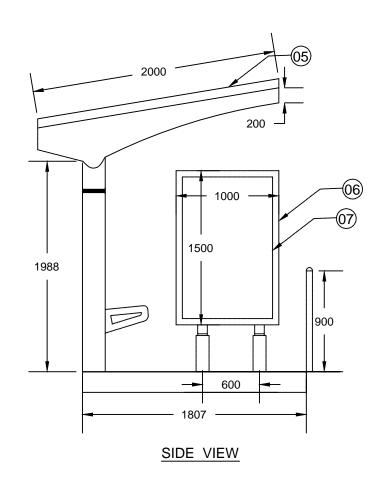

NOTE:- ALL DIMENSIONS ARE IN MM.



Project Title:


CONSULTANCY SERVICES FOR FEASIBILITY STUDY, PREPARATION OF DETAILED PROJECT REPORT AND PROVIDING PRE-CONSTRUCTION SERVICES FOR UP-GRADATION OF SELECTED ROAD STRETCHES / CORRIDORS TO TWO LANE WITH PAVED SHOULDER NH CONFIGURATION UNDER BHARAT MALA PROJECT AND NATIONAL HIGHWAYS CONNECTIVITY TO BACKWARD AREAS/RELIGIOUS/TOURIST PLACES OF THE COUNTRY IN THE STATE OF TRIPURA.

KAILASHAHAR - KURTI BRIDGE SECTION-3



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De	epak	B.Mishra	B.S.Pandey	DEC- 2019	

ONSULTANT: TASPL

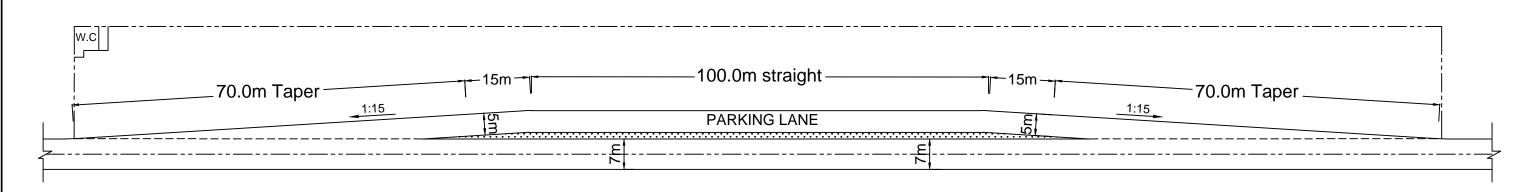

TYPICAL LAYOUT OF TRUCK LAY BYE IRC-SP73



Project Title:

CONSULTANCY SERVICES FOR FEASIBILITY STUDY, PREPARATION OF DETAILED PROJECT REPORT AND PROVIDING PRE-CONSTRUCTION SERVICES FOR UP-GRADATION OF SELECTED ROAD STRETCHES / CORRIDORS TO TWO LANE WITH PAVED SHOULDER NH CONFIGURATION UNDER BHARAT MALA PROJECT AND NATIONAL HIGHWAYS CONNECTIVITY TO BACKWARD AREAS/RELIGIOUS/TOURIST PLACES OF THE COUNTRY IN THE STATE OF TRIPURA.

KAILASHAHAR - KURTI BRIDGE SECTION-3







NATIONAL HIGHWAYS & INFRASTRUCTURE DEVELOPMENT CORPORATION LTD

TYPICAL LAYOUT OF TRUCK LAY BYE					
Drawing No. :-	Sheet :				
Scale :-	NTS		01 OF 01		
Drn	Dgn.	Appd	Date		
Deepak	B.Mishra	B.S.Pandey	DEC- 2019		

CONSULTANT:



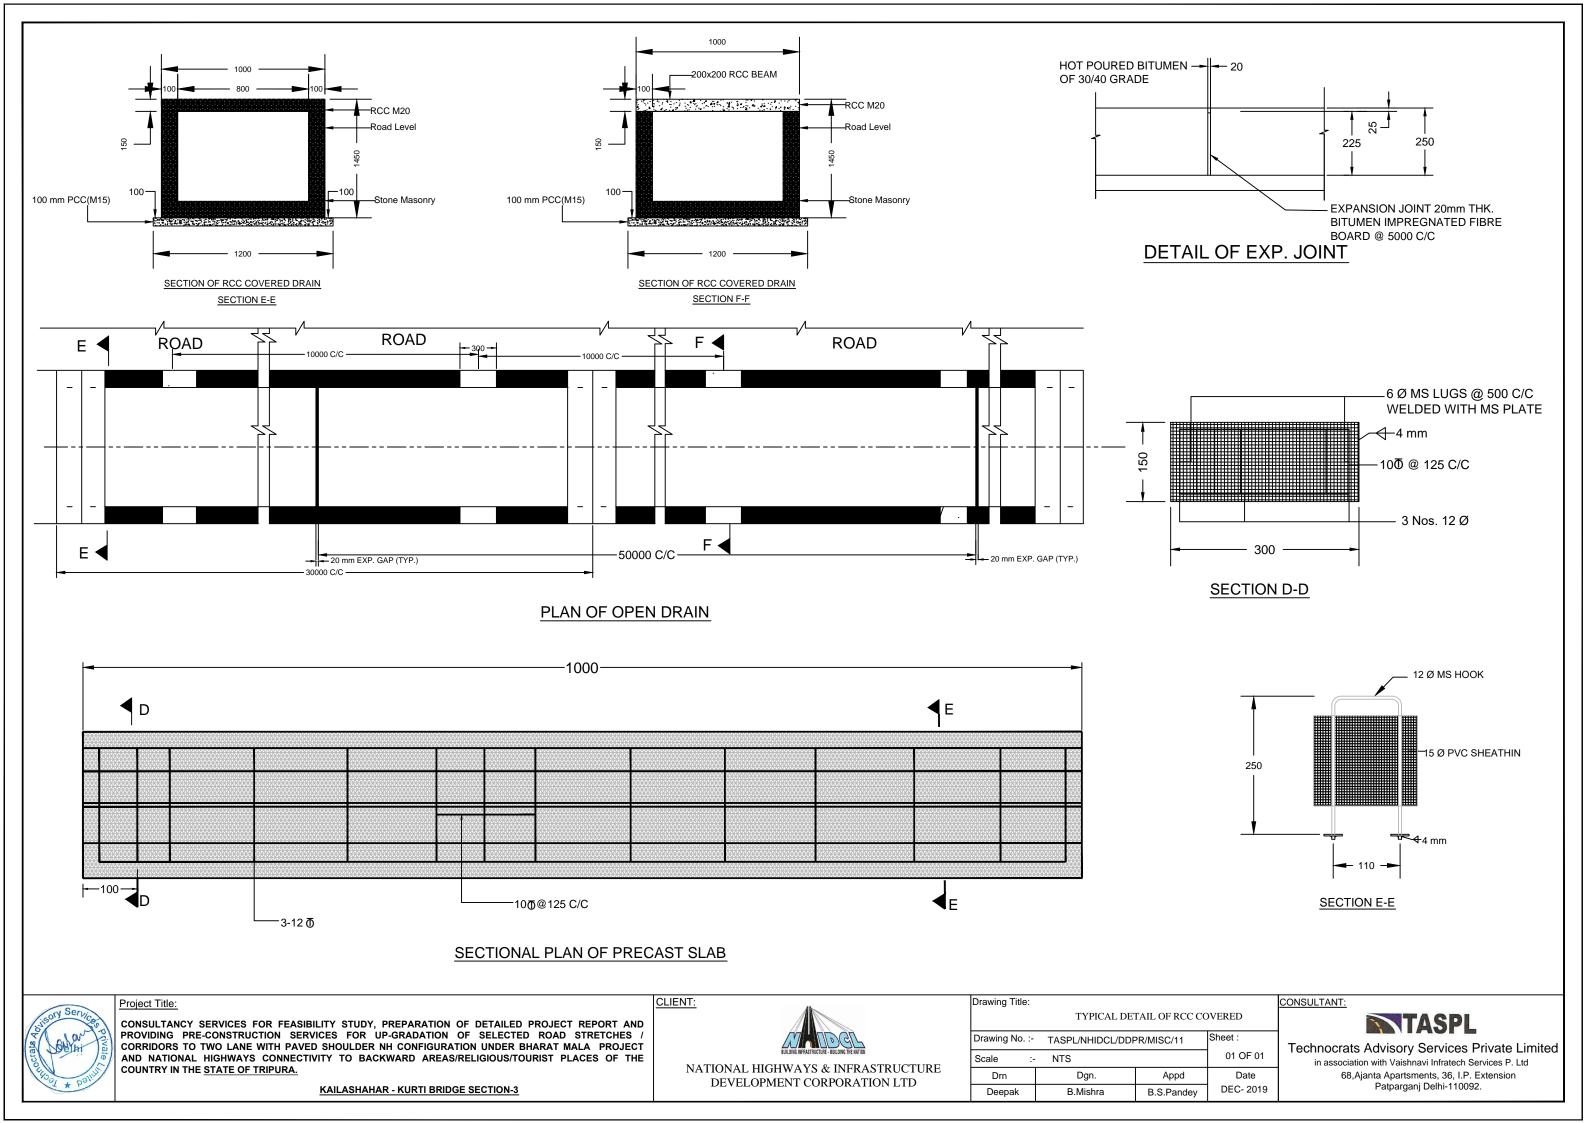

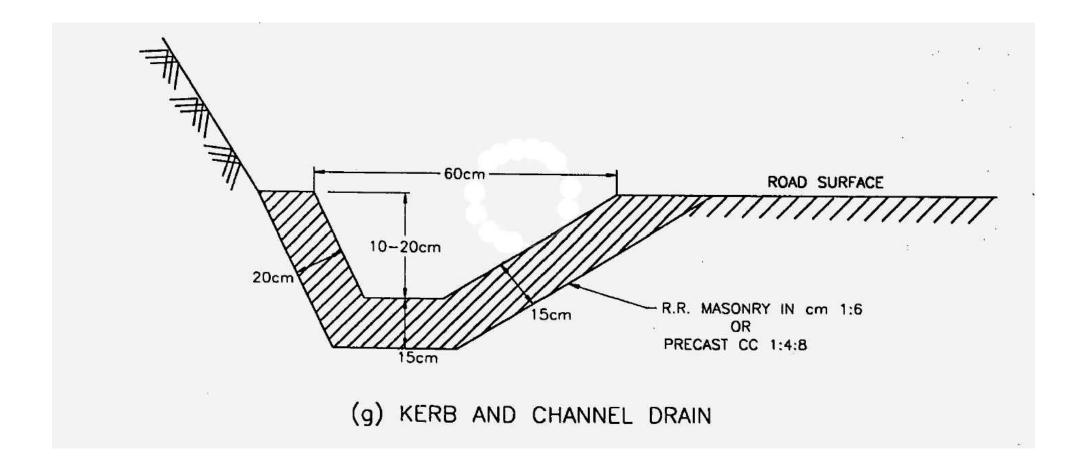



CONSULTANCY SERVICES FOR FEASIBILITY STUDY, PREPARATION OF DETAILED PROJECT REPORT AND PROVIDING PRE-CONSTRUCTION SERVICES FOR UP-GRADATION OF SELECTED ROAD STRETCHES / CORRIDORS TO TWO LANE WITH PAVED SHOULDER NH CONFIGURATION UNDER BHARAT MALA PROJECT AND NATIONAL HIGHWAYS CONNECTIVITY TO BACKWARD AREAS/RELIGIOUS/TOURIST PLACES OF THE COUNTRY IN THE STATE OF TRIPURA.

KAILASHAHAR - KURTI BRIDGE SECTION-3





NATIONAL HIGHWAYS & INFRASTRUCTURE DEVELOPMENT CORPORATION LTD

Drawing Title:	KERB CHANNEL DRAIN			
Drawing No. :-	TASPL/NHIDCL/DDF	TASPL/NHIDCL/DDPR/MISC/11		
Scale :-	NTS	NTS		
Drn	Dgn.	Appd	Date	
Deepak	B.Mishra	B.S.Pandey	DEC- 2019	


CONSULTANT:



DETAILS OF SUPERELVATION


DETAILS OF VERTICAL CURVE

DETAILS OF HORIZONTAL CURVE

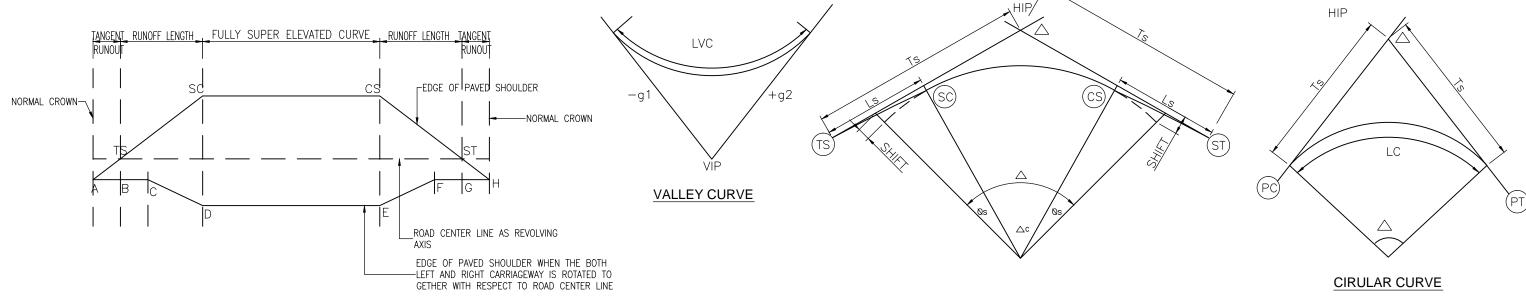

CIRCULAR CURVE WITH TRANSITION

.1/3 L, FULLY SUPER ELEVATED CURVE .1/3 L.

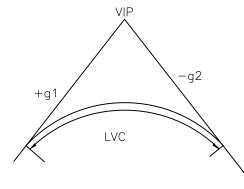

SUMMIT CURVE

NORMAL CROWN--NORMAL CROWN

> -EDGE OF PAVED SHOULDER WHEN THE BOTH LEFT AND RIGHT CARRIAGEWAY IS ROTATED TO GETHER WITH RESPECT TO ROAD CENTER LINE CIRULAR CURVE

-MEDIAN EDGE AS REVOLVING AXIS

CIRCULAR CURVE WITH TRANSITION

- TANGENT TO SPIRAL
- SPIRAL TO CURVE
- SPIRAL TO TANGENT

CURVE TO SPIRAL

- POINT OF CURVETURE
- POINT OF TANGENT

- HORIZONTAL INTERSECTION POINT
- LENGTH OF TRANSITION
- TANGENT DISTANCE
- TOTAL DEVIATION ANGLE
- DEVIATION ANGLE OF TRANSITION CURVE
- LVC LENGTH OF VERTICAL CURVE
- VERTICAL GRADIENT
- VERTICAL INTERSECTION POINT

DEC- 2019

CONSULTANCY SERVICES FOR FEASIBILITY STUDY, PREPARATION OF DETAILED PROJECT REPORT AND PROVIDING PRE-CONSTRUCTION SERVICES FOR UP-GRADATION OF SELECTED ROAD STRETCHES / CORRIDORS TO TWO LANE WITH PAVED SHOULDER NH CONFIGURATION UNDER BHARAT MALA PROJECT AND NATIONAL HIGHWAYS CONNECTIVITY TO BACKWARD AREAS/RELIGIOUS/TOURIST PLACES OF THE COUNTRY IN THE STATE OF TRIPURA.

KAILASHAHAR - KURTI BRIDGE SECTION-3





NATIONAL HIGHWAYS & INFRASTRUCTURE DEVELOPMENT CORPORATION LTD

Drawing Title:			
	DETAILS OF CU	RVE & SUPER ELE	EVATION
Drawing No. :- TASPL/NHIDCL/DDPR/MISC/11		Sheet :	
Scale :-	NTS		01 OF 01
Drn	Dan	Annd	Data


B.S.Pandey

B Mishra

Deepak

CONSULTANT:



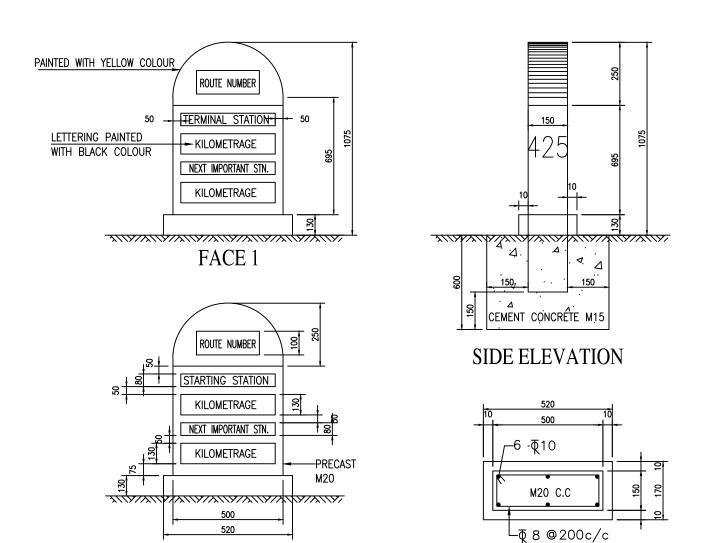


FACE 2


TYPICAL DESIGN FOR THE 5TH KILOMETRE STONE


SECTIONAL PLAN

	INDEX FOR KILOMETRE STONES		
Km No. SCRIPT FOR PLACE NAMES		PLACE TO BE SHOWN	
0	ROMAN	TERMINAL/STARTING STATION AND NEXT IMPORTANT TOWN	
1	HINDI (DEVANAGARI SCRIPT)	NEXT IMPORTANT TOWN	
2	LOCAL LANGUAGE	NEXT IMPORTANT TOWN	
3	HINDI (DEVANAGARI SCRIPT)	TERMINAL / STARTING STATION	
4	LOCAL LANGUAGE	TERMINAL / STARTING STATION	
5	ROMAN	TERMINAL/STARTING STATION AND NEXT IMPORTANT TOWN	
6	HINDI (DEVANAGARI SCRIPT)	NEXT IMPORTANT TOWN	

PAINTED WITH YELLOW COLOUR LETTERING PAINTED WITH BLACK COLOUR ROUTE NUMBER KILOMETRAGE FACE 1

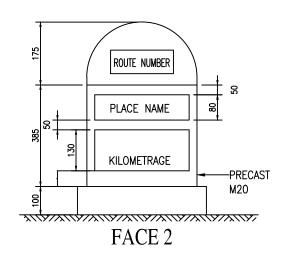

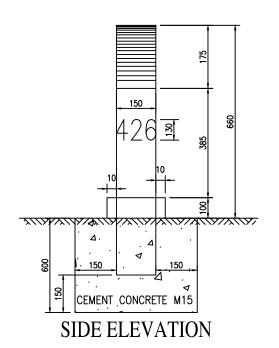

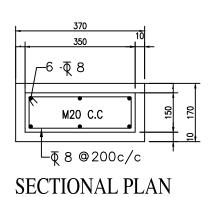

TYPICAL DESIGN FOR ORDINARY KILOMETRE STONE

NOTES:

- 1. ALL DIMENSIONS ARE IN MILLIMETRES.
- 2. REFLECTORISED PAINT SHALL BE IN ACCORDANCE WITH CL.803.5 OF M.O.R.T & H SPEC.
- 3. FOR TYPE & STYLE SIZE OF LETTERING RELEVANT IRC CODE OF PRATICE SHALL BE REFERED.
- 4. LETTERING IS DONE WITH APPROVED QUALITY BLACK ENAMEL PAINT USING STENCIL



Project Title:

CONSULTANCY SERVICES FOR FEASIBILITY STUDY, PREPARATION OF DETAILED PROJECT REPORT AND PROVIDING PRE-CONSTRUCTION SERVICES FOR UP-GRADATION OF SELECTED ROAD STRETCHES / CORRIDORS TO TWO LANE WITH PAVED SHOULDER NH CONFIGURATION UNDER BHARAT MALA PROJECT AND NATIONAL HIGHWAYS CONNECTIVITY TO BACKWARD AREAS/RELIGIOUS/TOURIST PLACES OF THE COUNTRY IN THE STATE OF TRIPURA.

KAILASHAHAR - KURTI BRIDGE SECTION-3




NATIONAL HIGHWAYS & INFRASTRUCTURE DEVELOPMENT CORPORATION LTD

Drawing Title:				CON
	TYPICAL DR	AWING OF KM	STONE	
Drawing No. :-	TASPL/NHIDCL/DDF	PR/MISC/11	Sheet :	l _T ,
Scale :-	NTS		01 OF 02] '`
Drn	Dgn.	Appd	Date	
Deepak	B.Mishra	B.S.Pandey	DEC- 2019	

ONSULTANT:

TASPL

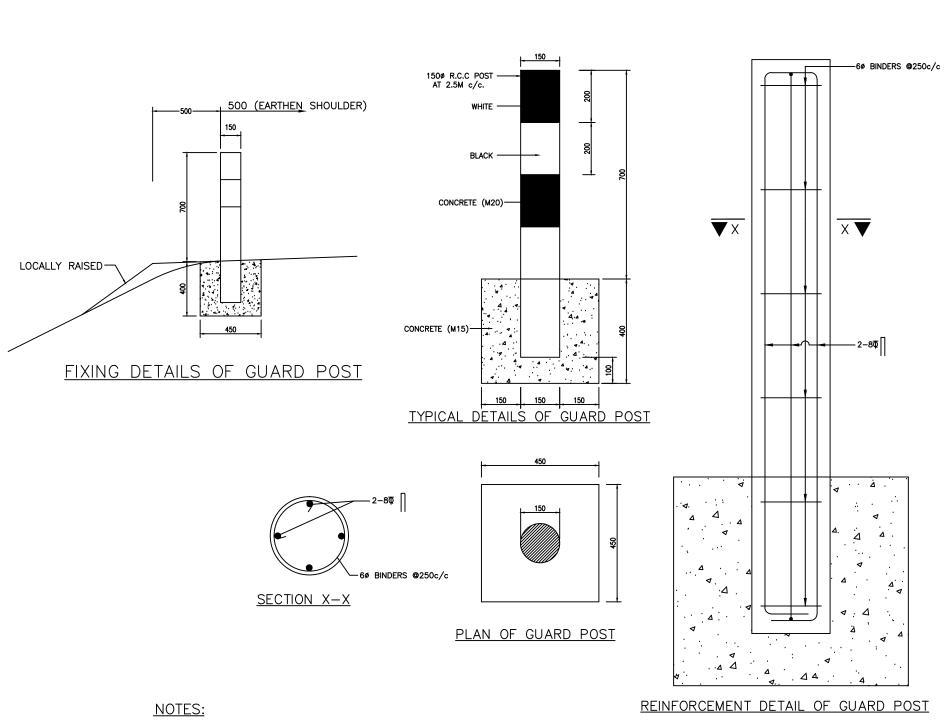

PLAN

SCHEDULE OF REINFORCEMENT

TYPICAL DESIGN FOR 200m STONES

-5 Nos. BARS 6mm ø, EACH 375mm LONG.

-2 Nos. BARS 6mm ø, EACH 1400mm LONG.

-M20 CEMENT CONCRETE

CEMENT CONCRETE

NOTES:

LETTERING PAINTED

WITH BLACK COLOUR

XXXXX

FRONT ELEVATION

- 1. ALL DIMENSIONS ARE IN MILLIMETRES.
- 2. REFLECTORISED PAINT SHALL BE IN ACCORDANCE WITH CL.803.5 OF M.O.R.T & H SPEC.
- 3. FOR TYPE & STYLE SIZE OF LETTERING RELEVANT IRC CODE OF PRATICE SHALL BE REFERED.
- 4. LETTERING IS DONE WITH APPROVED QUALITY BLACK ENAMEL PAINT USING STENCIL

- 1. ALL DIMENSIONS ARE IN mm UNLESS OTHERWISE MENTIONED.
- 2. FOR EXACT DETAILS OF W-BEAM, REFER MANUFACTURER DRAWING.
- 3. W-BEAM BARRIER IS INSTALLED WHERE EMBANKMENT HEIGHT IS MORE THAN 6 METRES & AT IMMEDIATE BRIDGE APPROACHES.
- 4. R.C.C. GUARD POSTS IS TO BE INSTALLED AS PER THE INSTRUCTIONS OF ENGINEER.

Services of the services of th

Project Title:

CONSULTANCY SERVICES FOR FEASIBILITY STUDY, PREPARATION OF DETAILED PROJECT REPORT AND PROVIDING PRE-CONSTRUCTION SERVICES FOR UP-GRADATION OF SELECTED ROAD STRETCHES / CORRIDORS TO TWO LANE WITH PAVED SHOULDER NH CONFIGURATION UNDER BHARAT MALA PROJECT AND NATIONAL HIGHWAYS CONNECTIVITY TO BACKWARD AREAS/RELIGIOUS/TOURIST PLACES OF THE COUNTRY IN THE STATE OF TRIPURA.

KAILASHAHAR - KURTI BRIDGE SECTION-3



NATIONAL HIGHWAYS & INFRASTRUCTURE DEVELOPMENT CORPORATION LTD

Drawing Title:				CONSULTANT:
	TYPICAL DR	TYPICAL DRAWING OF KM STONE		
Drawing No. :-	TASPL/NHIDCL/DDF	PR/MISC/11	Sheet :	Technocra
Scale :-	NTS		02 OF 02	in associa
Drn	Dgn.	Appd	Date	68
Deepak	B.Mishra	B.S.Pandey	DEC- 2019	

Technocrats Advisory Services Private Limited in association with Vaishnavi Infratech Services P. Ltd 68,Ajanta Apartsments, 36, I.P. Extension Patparganj Delhi-110092.

PAINTED WITH WHITE COLOUR

REFLECTORISED PAINT

SIDE VIEW

PROJECT ROAD PROJECT ROAD CARRIAGEWAY CARRIAGEWAY -CARRIAGEWAY SINGLE LANE ROAD TYPICAL 'THREE ARM' JUNCTION



Project Title:

CONSULTANCY SERVICES FOR FEASIBILITY STUDY, PREPARATION OF DETAILED PROJECT REPORT AND PROVIDING PRE-CONSTRUCTION SERVICES FOR UP-GRADATION OF SELECTED ROAD STRETCHES / CORRIDORS TO TWO LANE WITH PAVED SHOULDER NH CONFIGURATION UNDER BHARAT MALA PROJECT AND NATIONAL HIGHWAYS CONNECTIVITY TO BACKWARD AREAS/RELIGIOUS/TOURIST PLACES OF THE COUNTRY IN THE STATE OF TRIPURA.

KAILASHAHAR - KURTI BRIDGE SECTION-3






NATIONAL HIGHWAYS & INFRASTRUCTURE DEVELOPMENT CORPORATION LTD

TYPICAL 'T' JUNCTION				
Drawing No. :- TASPL/NHIDCL/DDPR/MISC/11			Sheet :	-
Scale :-	NTS		01 OF 03	
Drn	Dgn.	Appd	Date	
Deepak	B.Mishra	B.S.Pandev	DEC- 2019	

CONSULTANT: TASPL

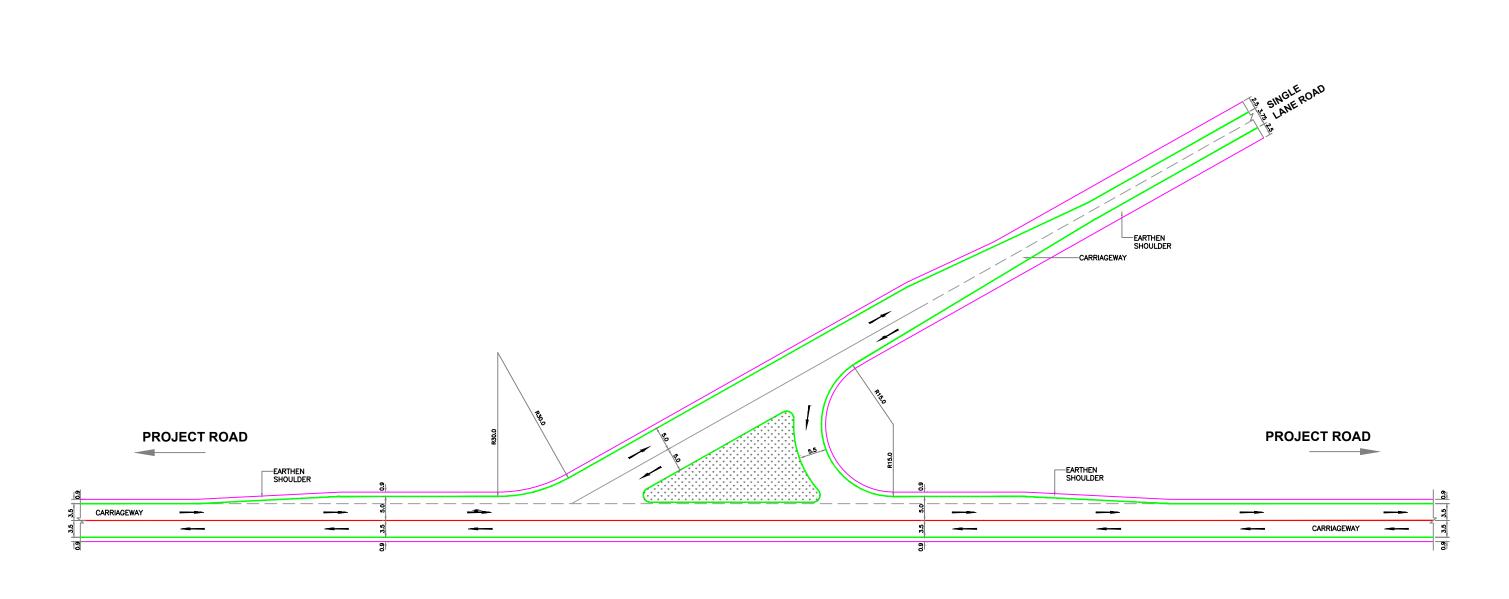

TYPICAL 'Y' JUNCTION



CONSULTANCY SERVICES FOR FEASIBILITY STUDY, PREPARATION OF DETAILED PROJECT REPORT AND PROVIDING PRE-CONSTRUCTION SERVICES FOR UP-GRADATION OF SELECTED ROAD STRETCHES / CORRIDORS TO TWO LANE WITH PAVED SHOULDER NH CONFIGURATION UNDER BHARAT MALA PROJECT AND NATIONAL HIGHWAYS CONNECTIVITY TO BACKWARD AREAS/RELIGIOUS/TOURIST PLACES OF THE COUNTRY IN THE STATE OF TRIPURA.

KAILASHAHAR - KURTI BRIDGE SECTION-3





NATIONAL HIGHWAYS & INFRASTRUCTURE DEVELOPMENT CORPORATION LTD

Drawing Title:

TYPICAL 'Y' JUNCTION

Drawing No. :- TASPL/NHIDCL/DDPR/MISC/11

 Drawing No. : TASPL/NHIDCL/DDPR/MISC/11
 Sheet :


 Scale : NTS
 02 OF 03

 Drn
 Dgn.
 Appd
 Date

 Deepak
 B.Mishra
 B.S.Pandey
 DEC- 2019

CONSULTANT:



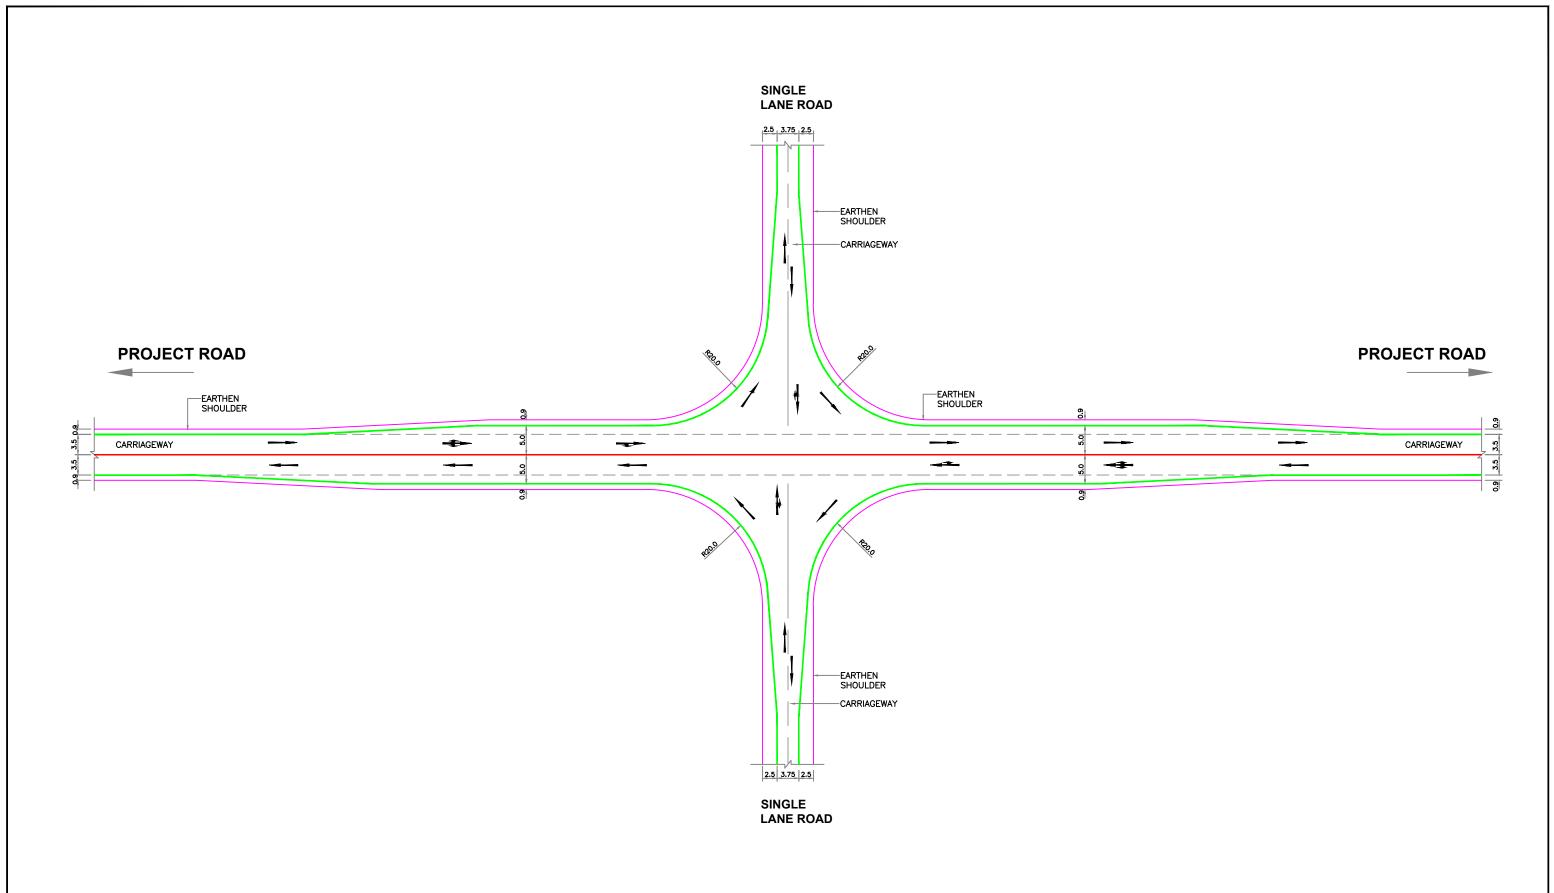

TYPICAL 'FOUR ARM' JUNCTION



Project Title:

CONSULTANCY SERVICES FOR FEASIBILITY STUDY, PREPARATION OF DETAILED PROJECT REPORT AND PROVIDING PRE-CONSTRUCTION SERVICES FOR UP-GRADATION OF SELECTED ROAD STRETCHES / CORRIDORS TO TWO LANE WITH PAVED SHOULDER NH CONFIGURATION UNDER BHARAT MALA PROJECT AND NATIONAL HIGHWAYS CONNECTIVITY TO BACKWARD AREAS/RELIGIOUS/TOURIST PLACES OF THE COUNTRY IN THE STATE OF TRIPURA.

KAILASHAHAR - KURTI BRIDGE SECTION-3




DEVELOPMENT CORPORATION LTD


Drawing Title:	TYPICAL 'FO	ΓΙΟN	CC	
Drawing No. :-	TASPL/NHIDCL/DDF	Sheet :	-	
Scale :-	NTS	NTS		'
Drn	Dgn.	Appd	Date	
Deepak	B.Mishra	B.S.Pandey	DEC- 2019	ĺ

CONSULTANT:


TASPL



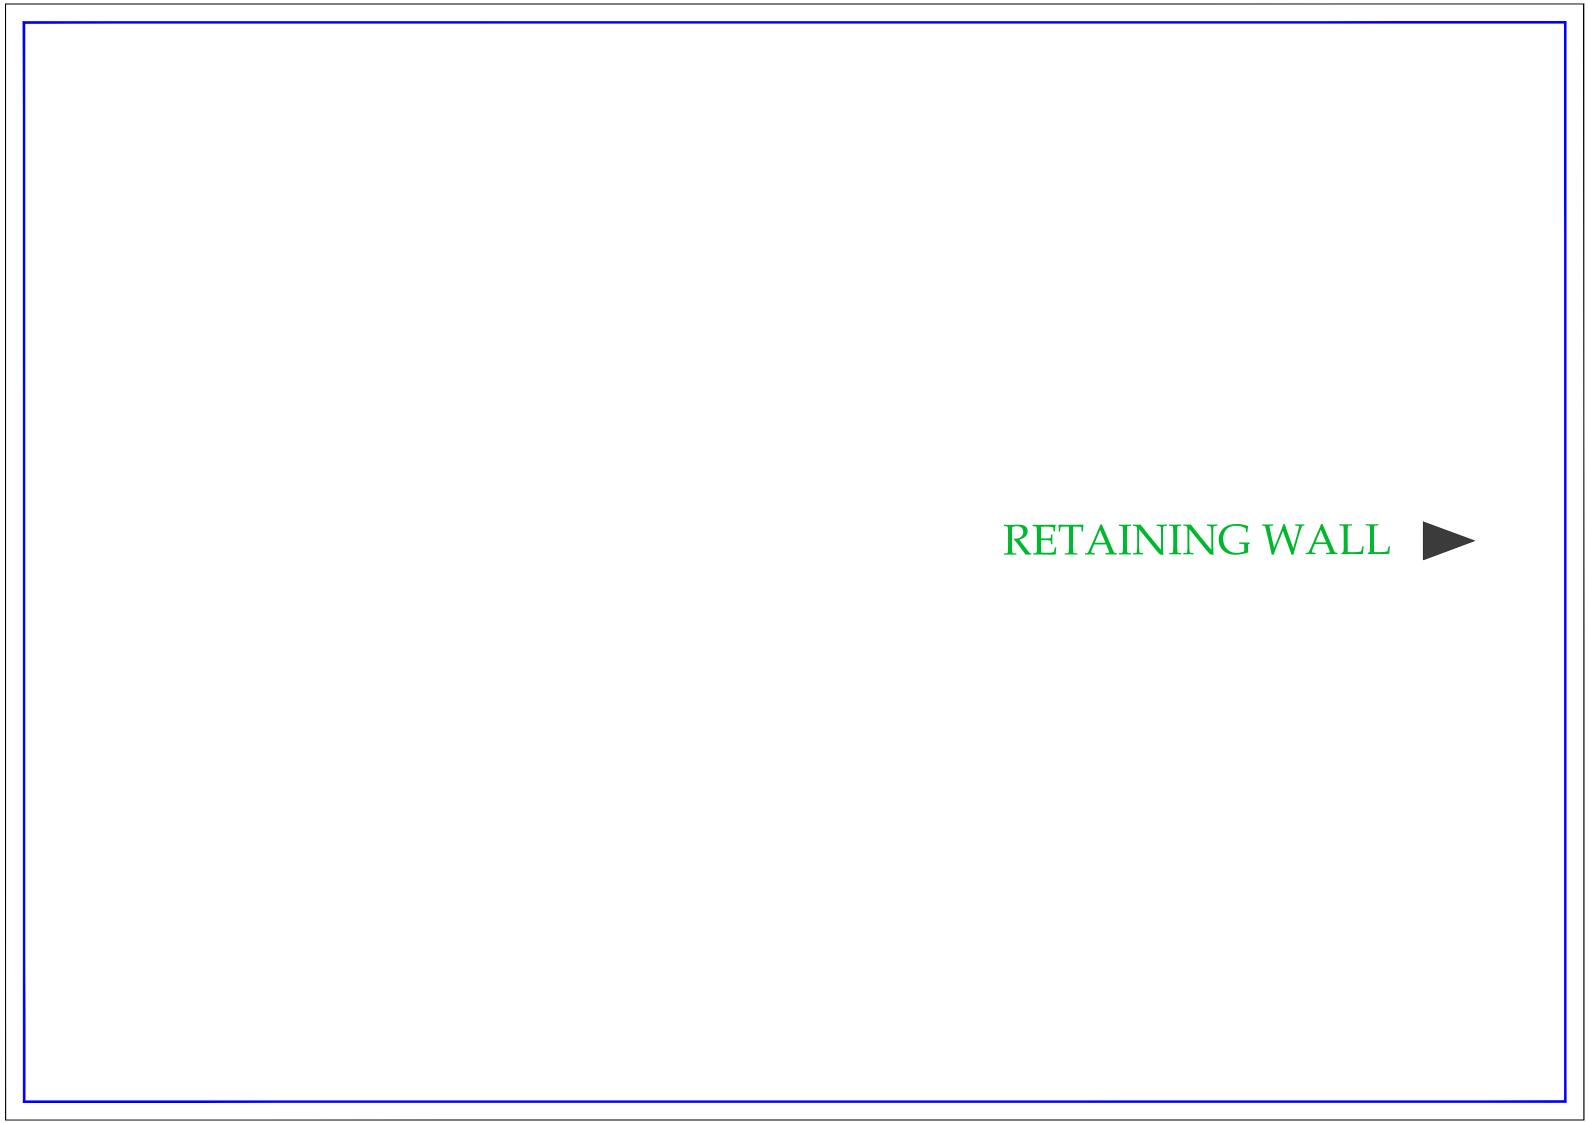

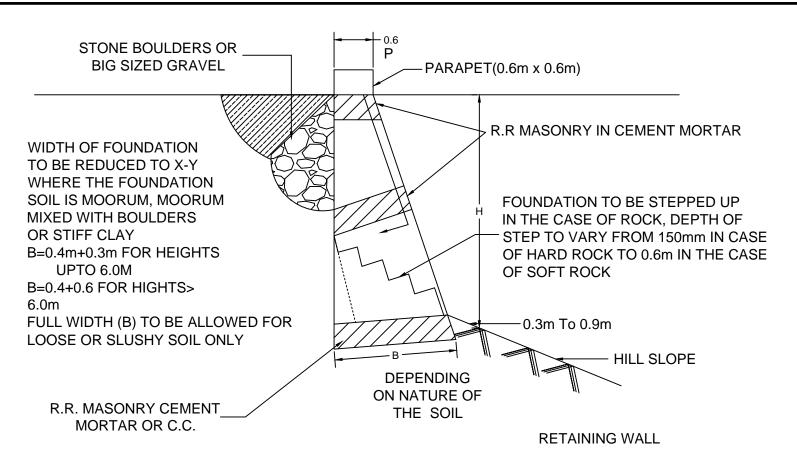

CROSS SECTION

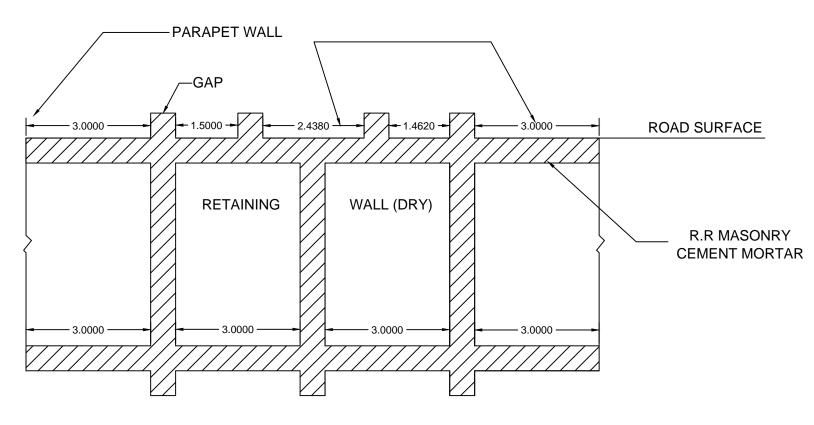

L-SECTION ON P-Q



Project Title:-

CONSULTANCY SERVICES FOR FEASIBILITY STUDY, PREPARATION OF DETAILED PROJECT REPORT AND PROVIDING PRE-CONSTRUCTION SERVICES FOR UP-GRADATION OF SELECTED ROAD STRETCHES / CORRIDORS TO TWO LANE WITH PAVED SHOULDER NH CONFIGURATION UNDER BHARAT MALA PROJECT AND NATIONAL HIGHWAYS CONNECTIVITY TO BACKWARD AREAS/RELIGIOUS/TOURIST PLACES OF THE COUNTRY IN THE STATE OF TRIPURA.

KAILASHAHAR - KURTI BRIDGE SECTION-3






NATIONAL HIGHWAYS & INFRASTRUCTURE DEVELOPMENT CORPORATION LTD

Drawing Title:	GENERAL ARRANGEMENT DRAV OF RETAINING WALL		WING
Drawing No. :-	Drawing No. :- TASPL/NHIDCL/DDPR/RW/12		Sheet :
Scale :-	NTS		01 OF 01
Drn	Dgn.	Appd	Date
D.S	B.Mishra	B.S.Pandey	DEC- 2019


CONSULTANT:





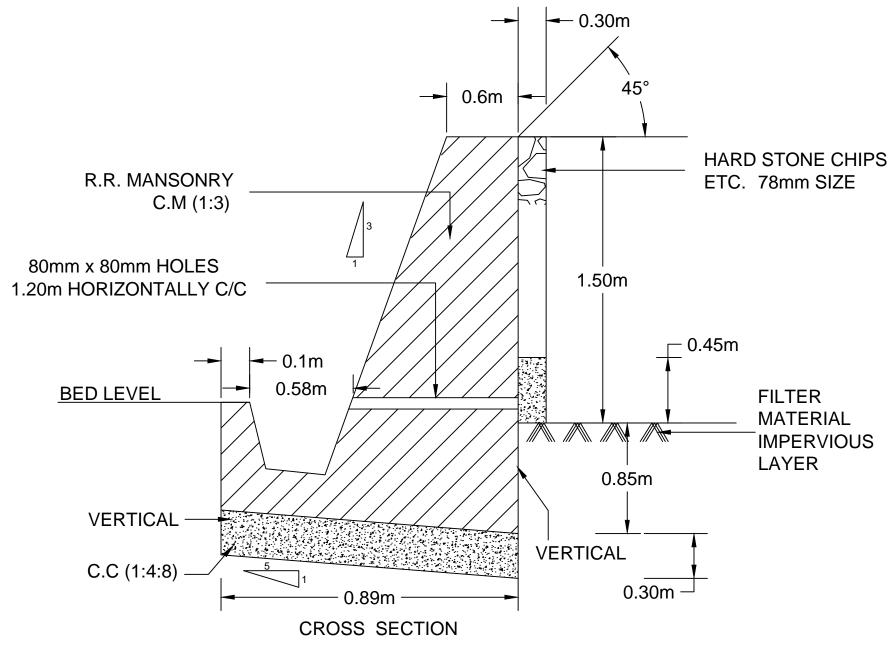

STANDARD 1.50m HIGH BREAST WALL

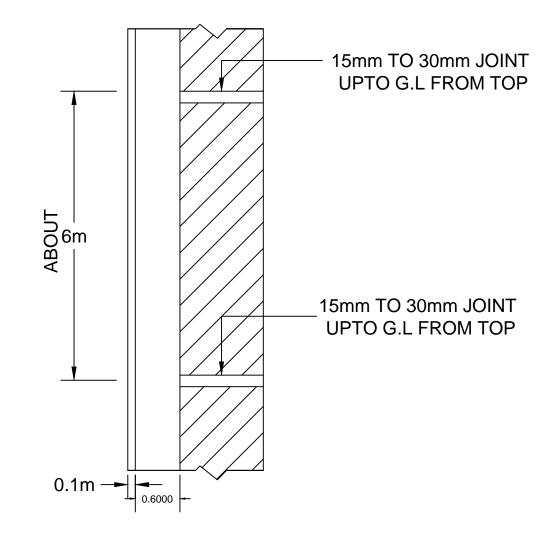

PLAN (AT GROUND LEVEL)



Project Title:-

CONSULTANCY SERVICES FOR FEASIBILITY STUDY, PREPARATION OF DETAILED PROJECT REPORT AND PROVIDING PRE-CONSTRUCTION SERVICES FOR UP-GRADATION OF SELECTED ROAD STRETCHES / CORRIDORS TO TWO LANE WITH PAVED SHOULDER NH CONFIGURATION UNDER BHARAT MALA PROJECT AND NATIONAL HIGHWAYS CONNECTIVITY TO BACKWARD AREAS/RELIGIOUS/TOURIST PLACES OF THE COUNTRY IN THE STATE OF TRIPURA.

KAILASHAHAR - KURTI BRIDGE SECTION-3





NATIONAL HIGHWAYS & INFRASTRUCTURE DEVELOPMENT CORPORATION LTD

Drawing Title.	GENERAL ARRANGEMENT DR OF BREAST WALL		RAWING
Drawing No. :-	TASPL/NHIDCL/DD	TASPL/NHIDCL/DDPR/BW/12	
Scale :-	NTS		01 OF 01
Drn	Dan	Annd	Date

B.S.Pandey

B.Mishra

D.S

CONSULTANT:

